


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ARCHITECTS - PC



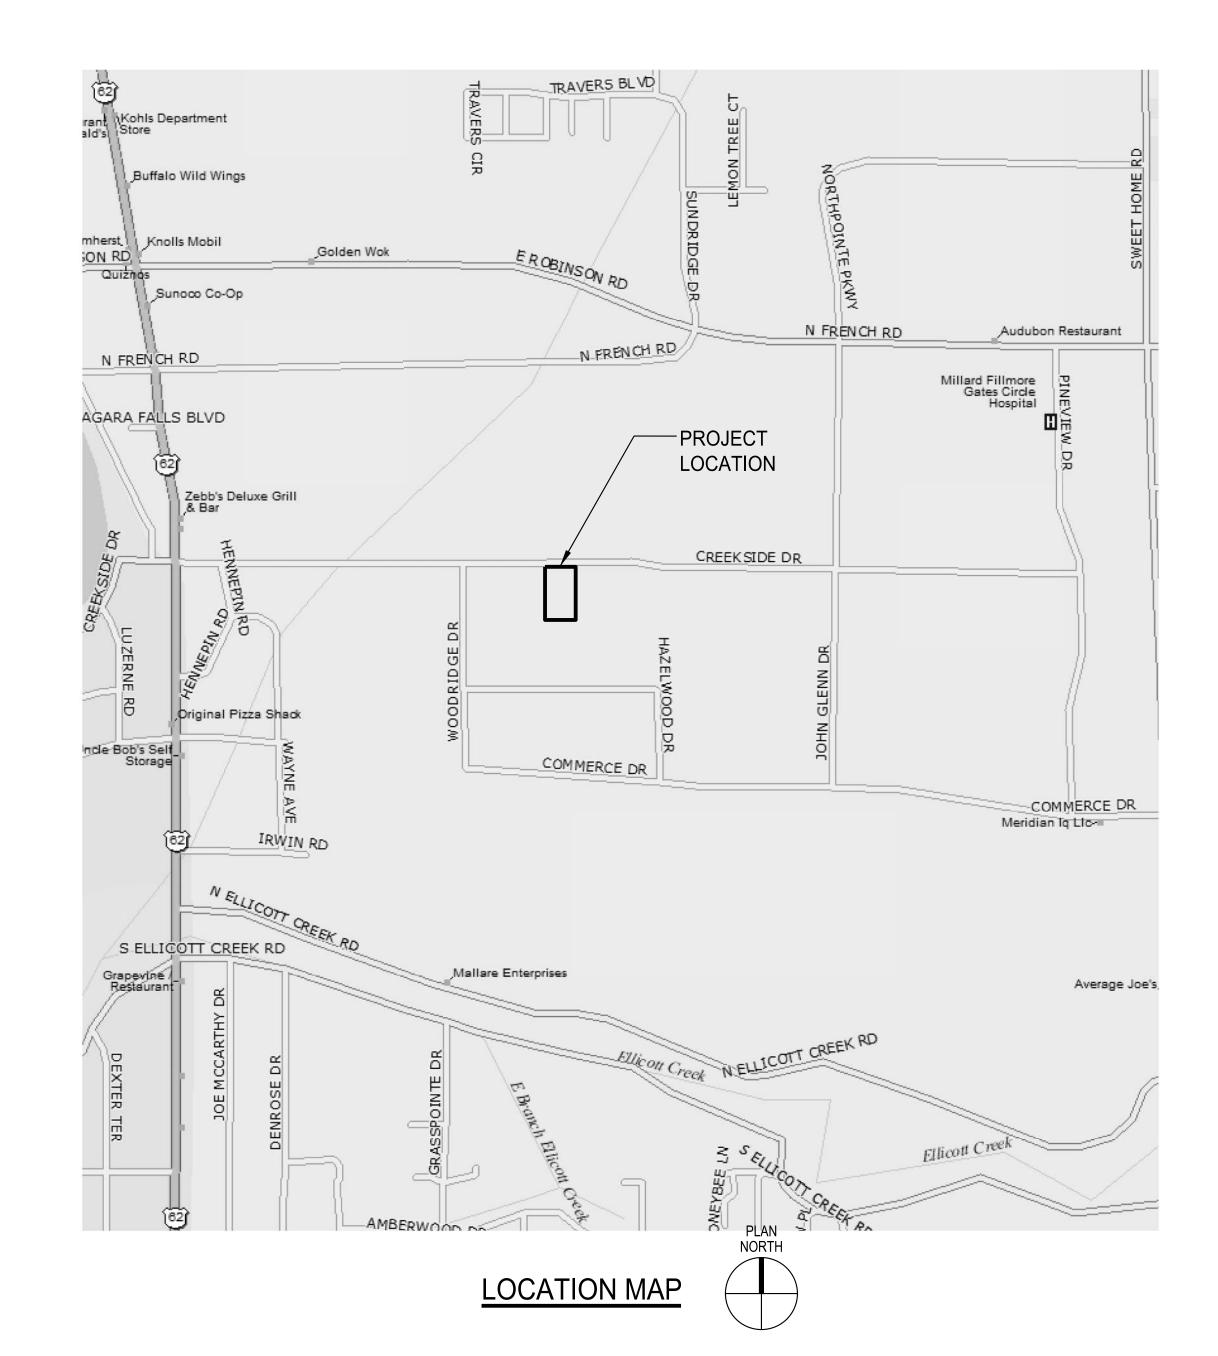

CONTRACT DRAWINGS FOR THE CONSTRUCTION OF

FRANK P. LANGLEY COMPANY, INC. 219 CREEKSIDE DRIVE AMHERST, NEW YORK

APPLICANT SCOTT A. CREGO FRANK P. LANGLEY CO., INC. 219 CREEKSIDE DRIVE AMHERST, NY 14228 PHONE: 716-691-7575 EXT. 8555

DRAWING LIS	T T
SHEET NO.	SHEET NAME
G-001	TITLE SHEET
	BOUNDARY & TOPOGRAPHIC SURVEY
C-101	SITE PLAN
C-102	DEMOLITION PLAN
C-103	GRADING & EROSION & SEDIMENT CONTROL PLAN
C-104	UTILITY PLAN
C-105	LANDSCAPING PLAN
C-106	PHOTOMETRIC PLAN
C-501	SITE DETAILS
C-502	EROSION & SEDIMENT CONTROL & STORM DETAILS


C&S PROJECT: D51.123.001


APRIL 19, 2024


TO THE BEST OF OUR KNOWLEDGE, INFORMATION AND BELIEF THE PLANS AND SPECIFICATIONS FOR THIS PROJECT ARE IN COMPLIANCE WITH THE NEW YORK STATE ENERGY CONSERVATION CONSTRUCTION CODE AND THE BUILDING CODE OF NEW YORK STATE


NO ALTERATION PERMITTED HEREON EXCEPT AS PROVIDED UNDER SECTION 7209
SUBDIVISION 2 OF THE NEW YORK STATE EDUCATION LAW


G-001

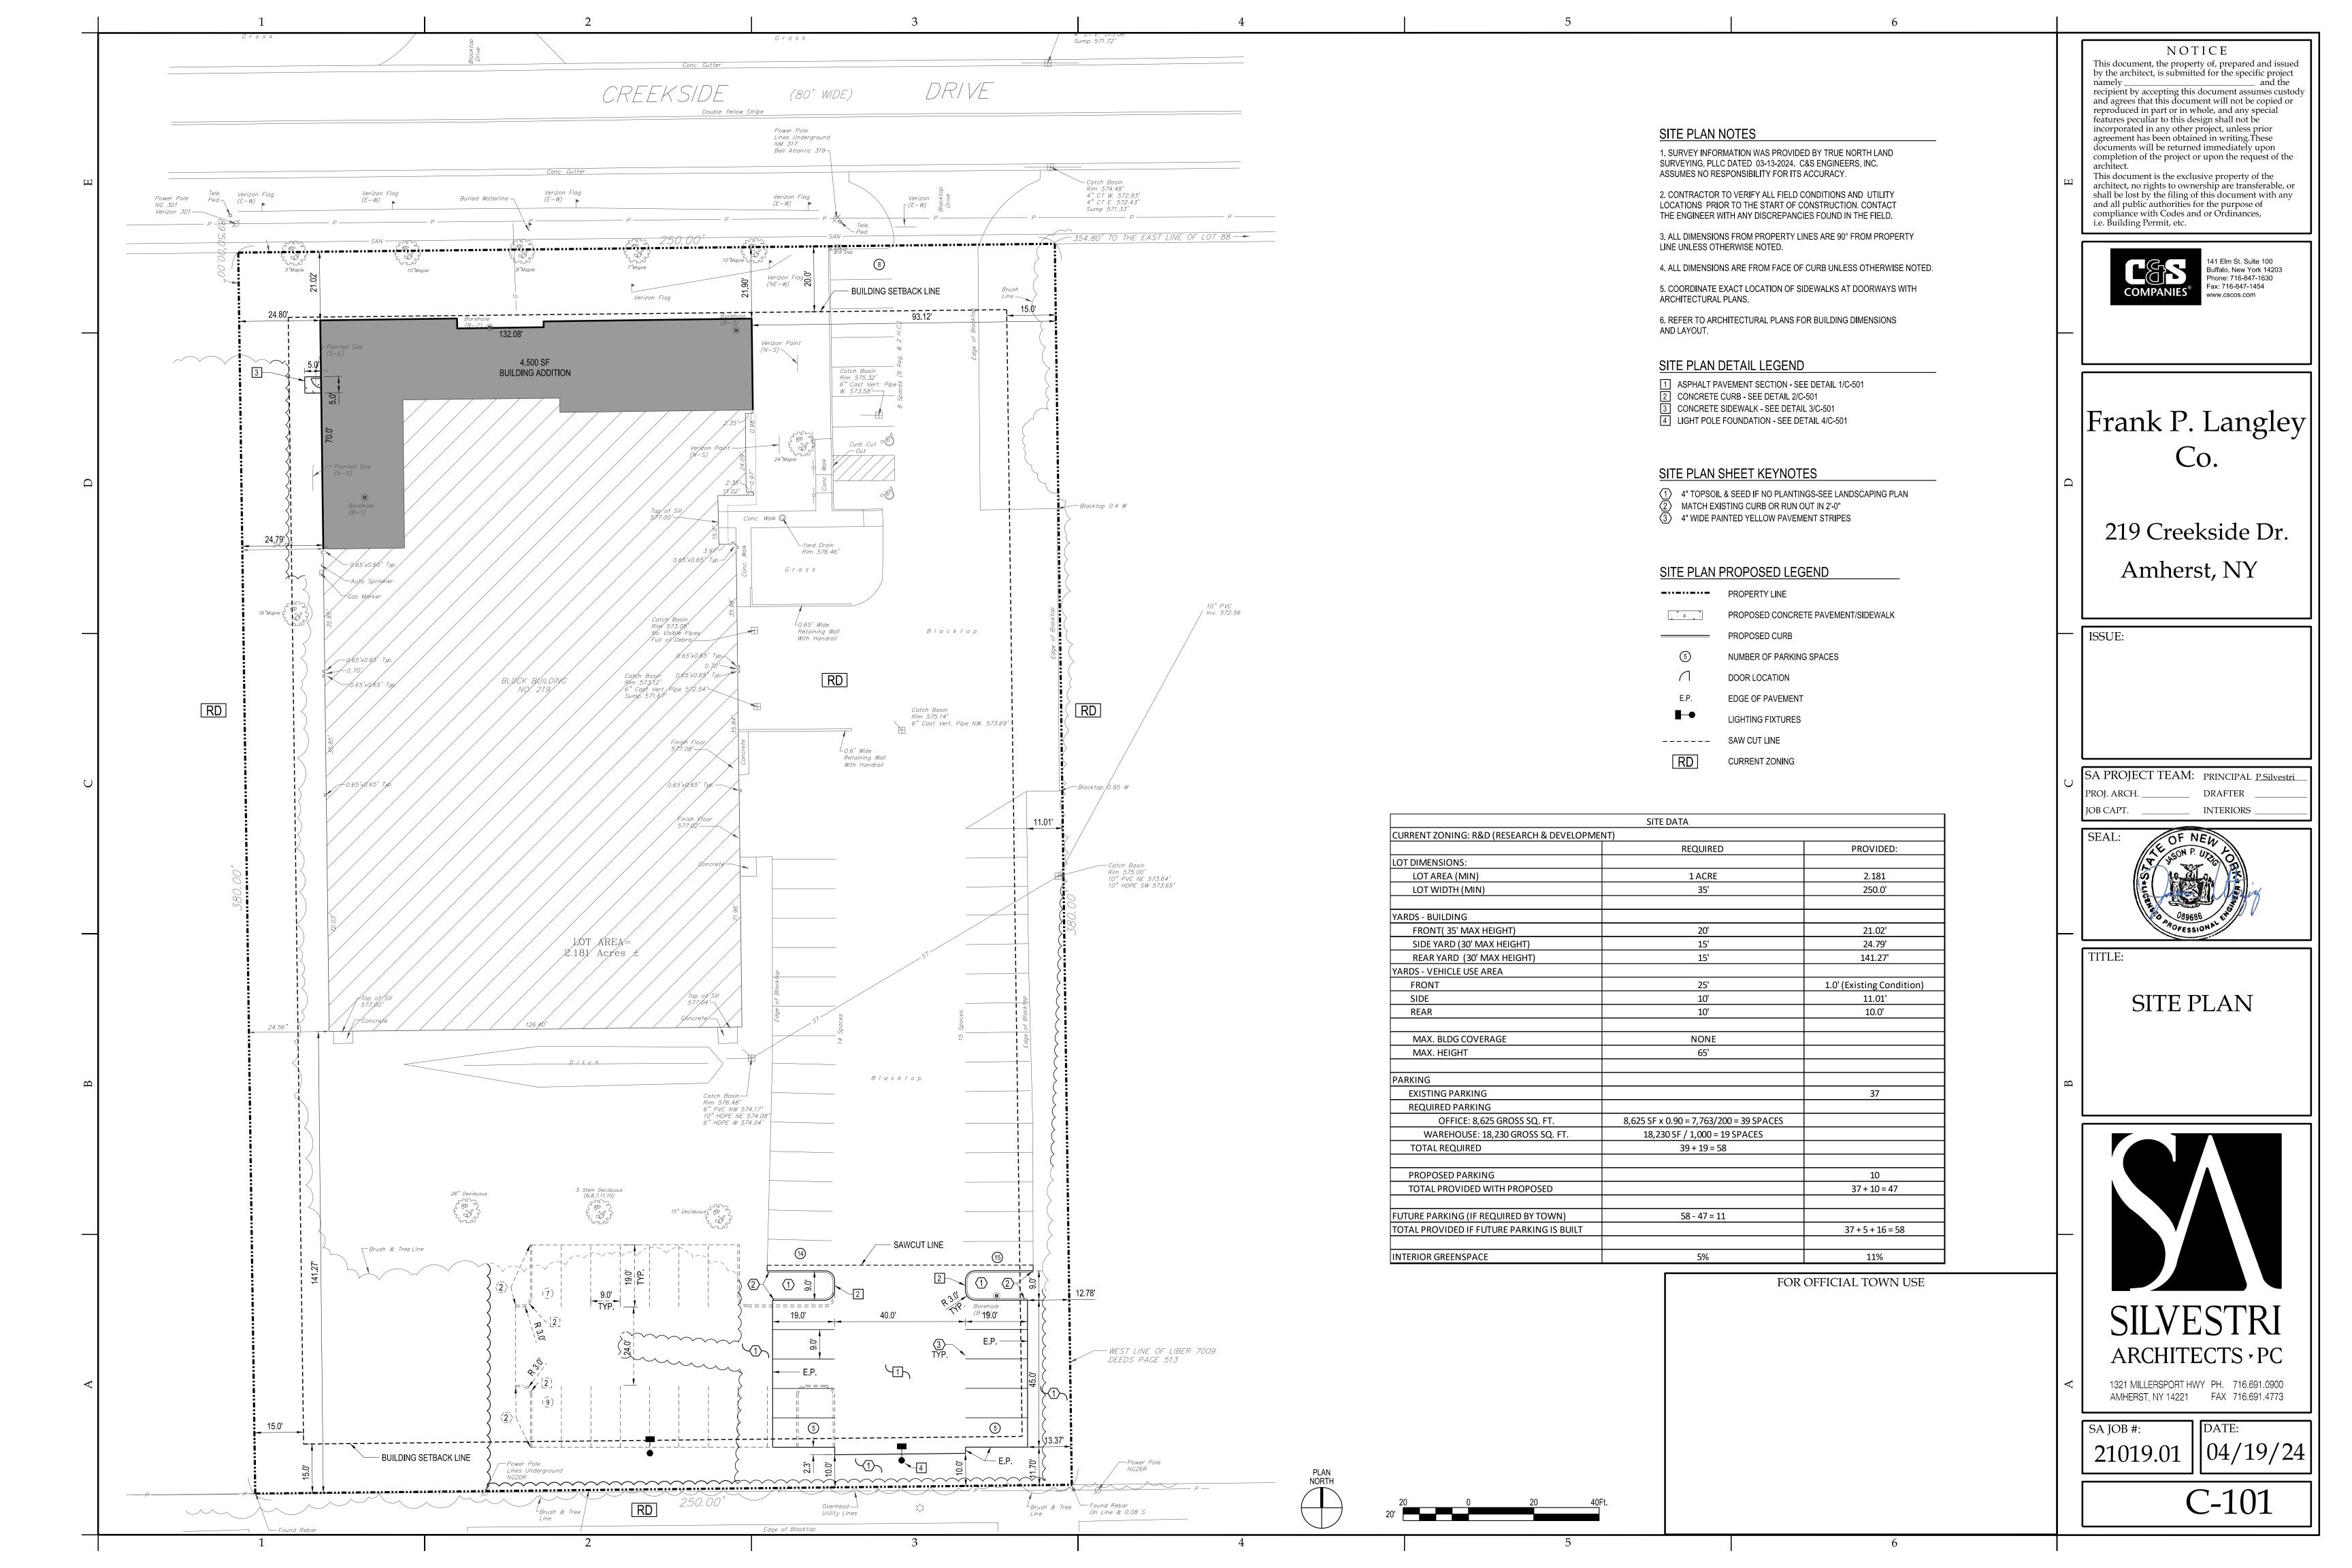

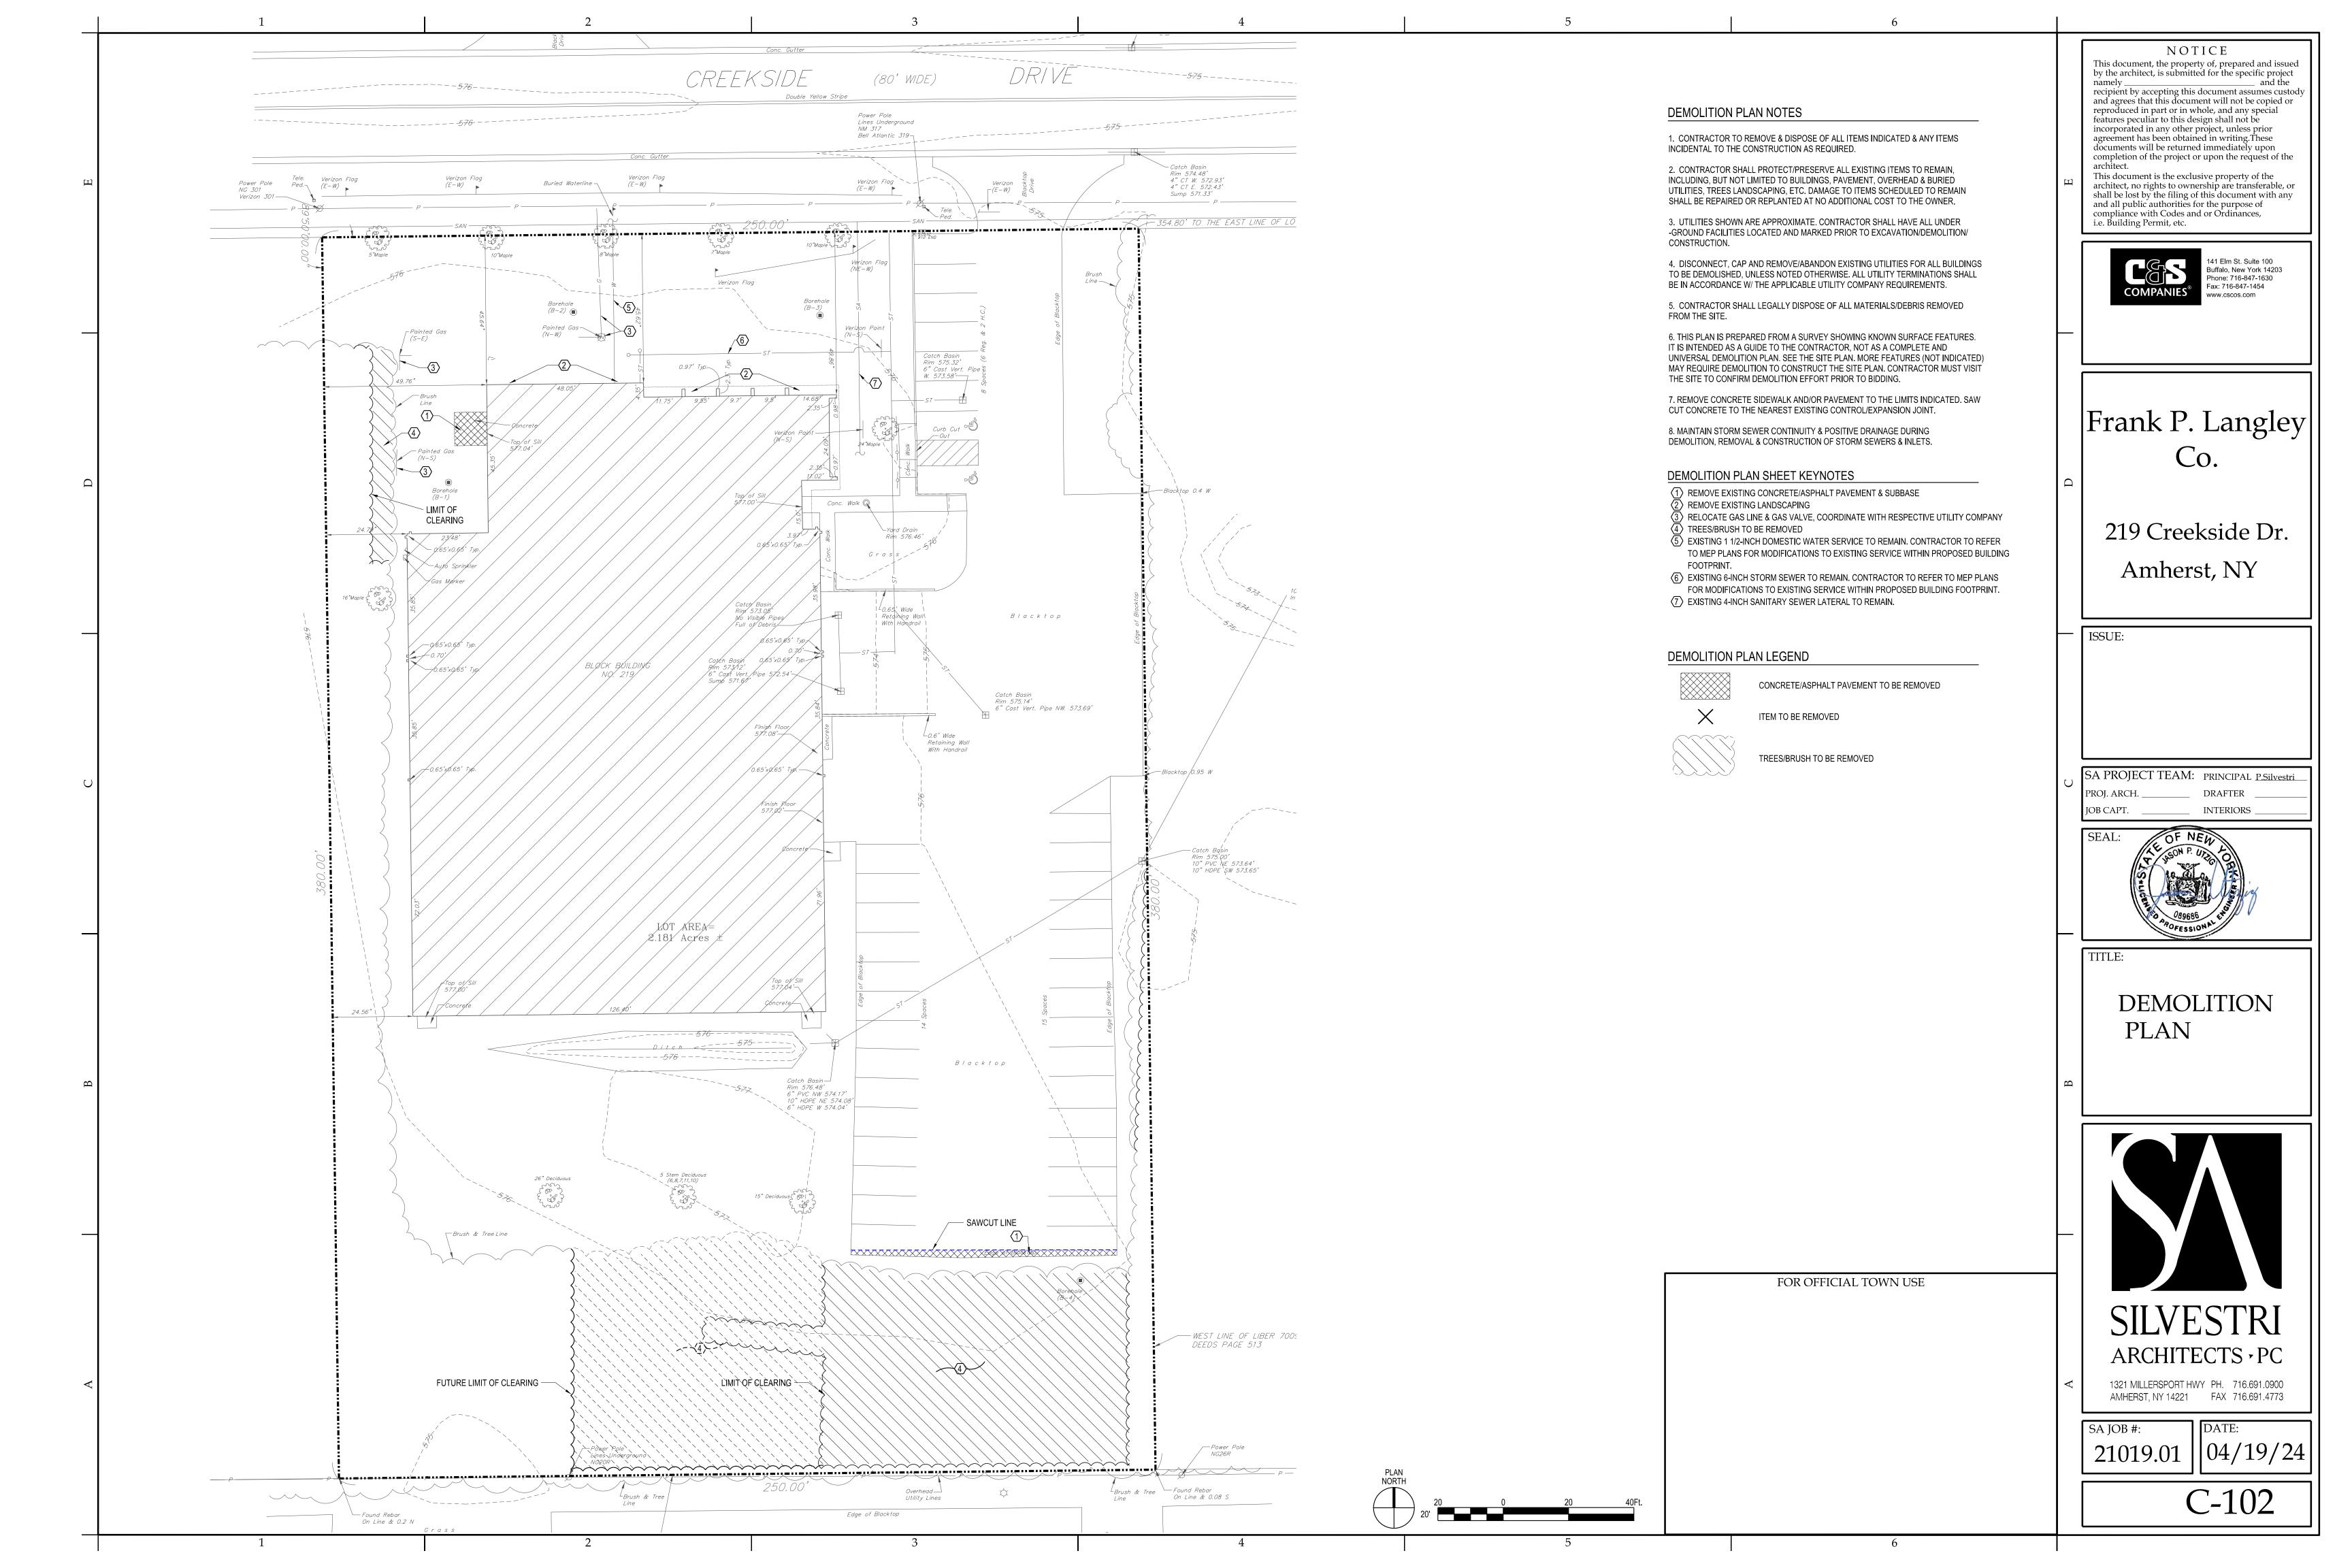

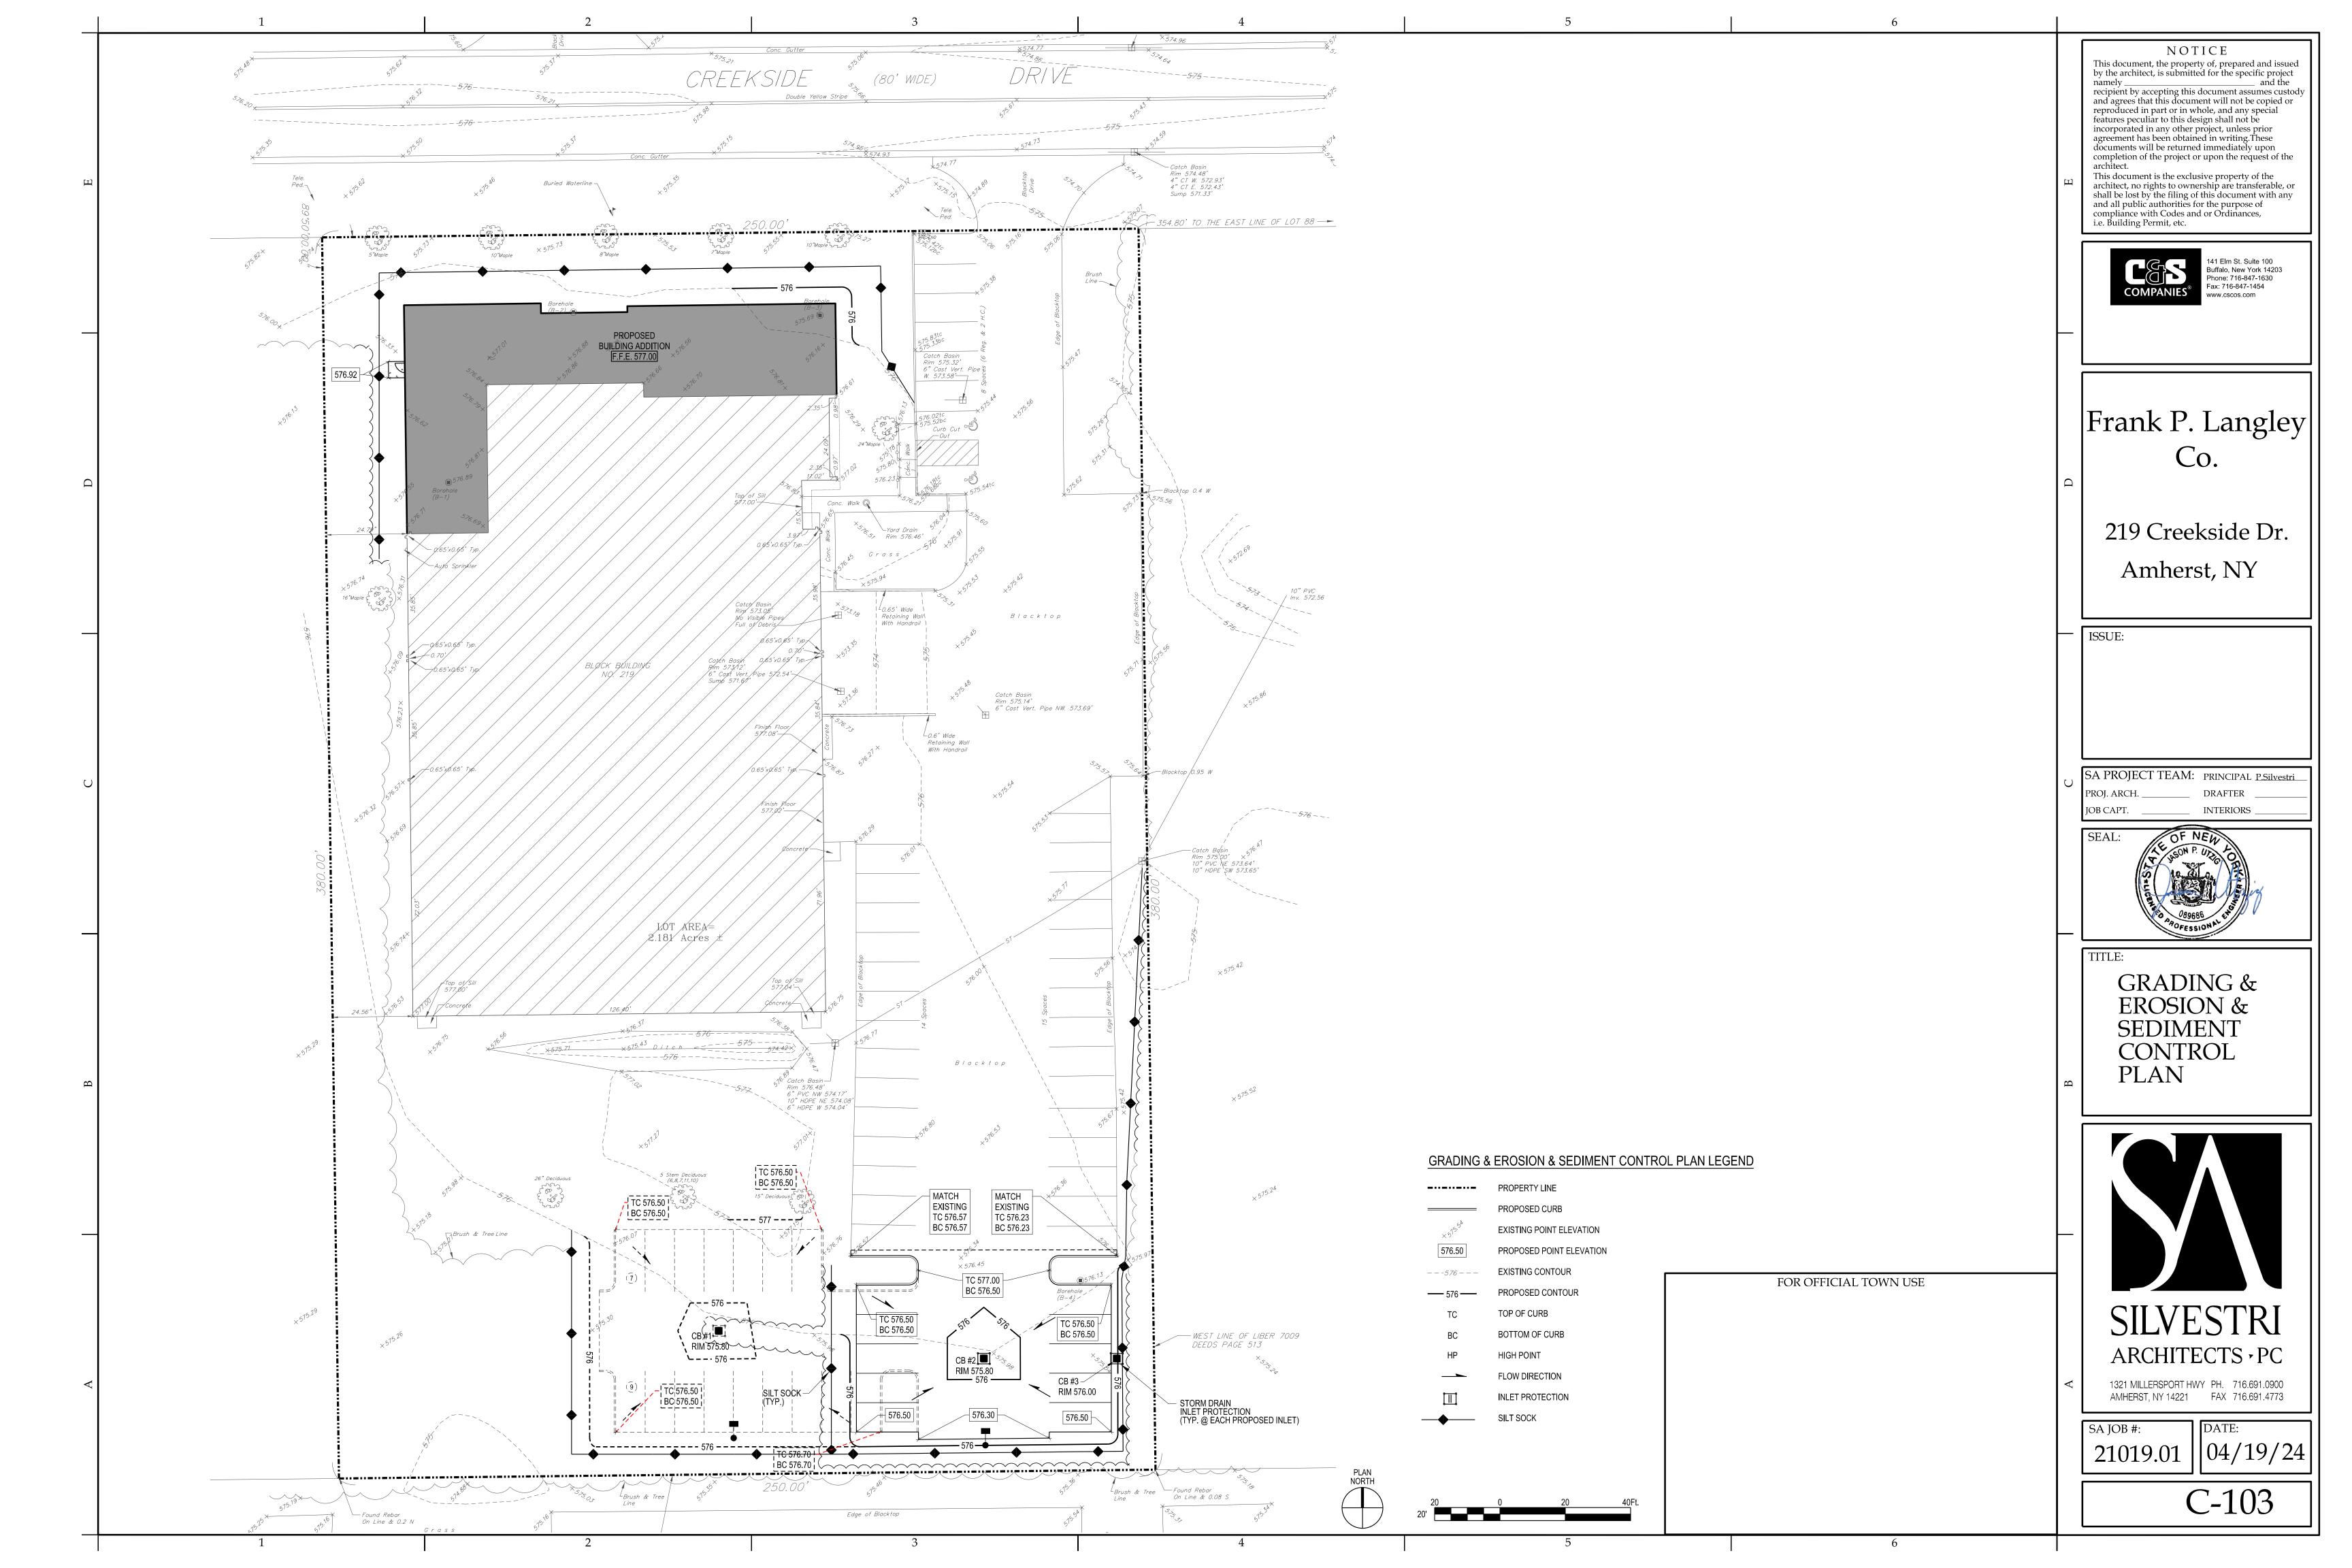

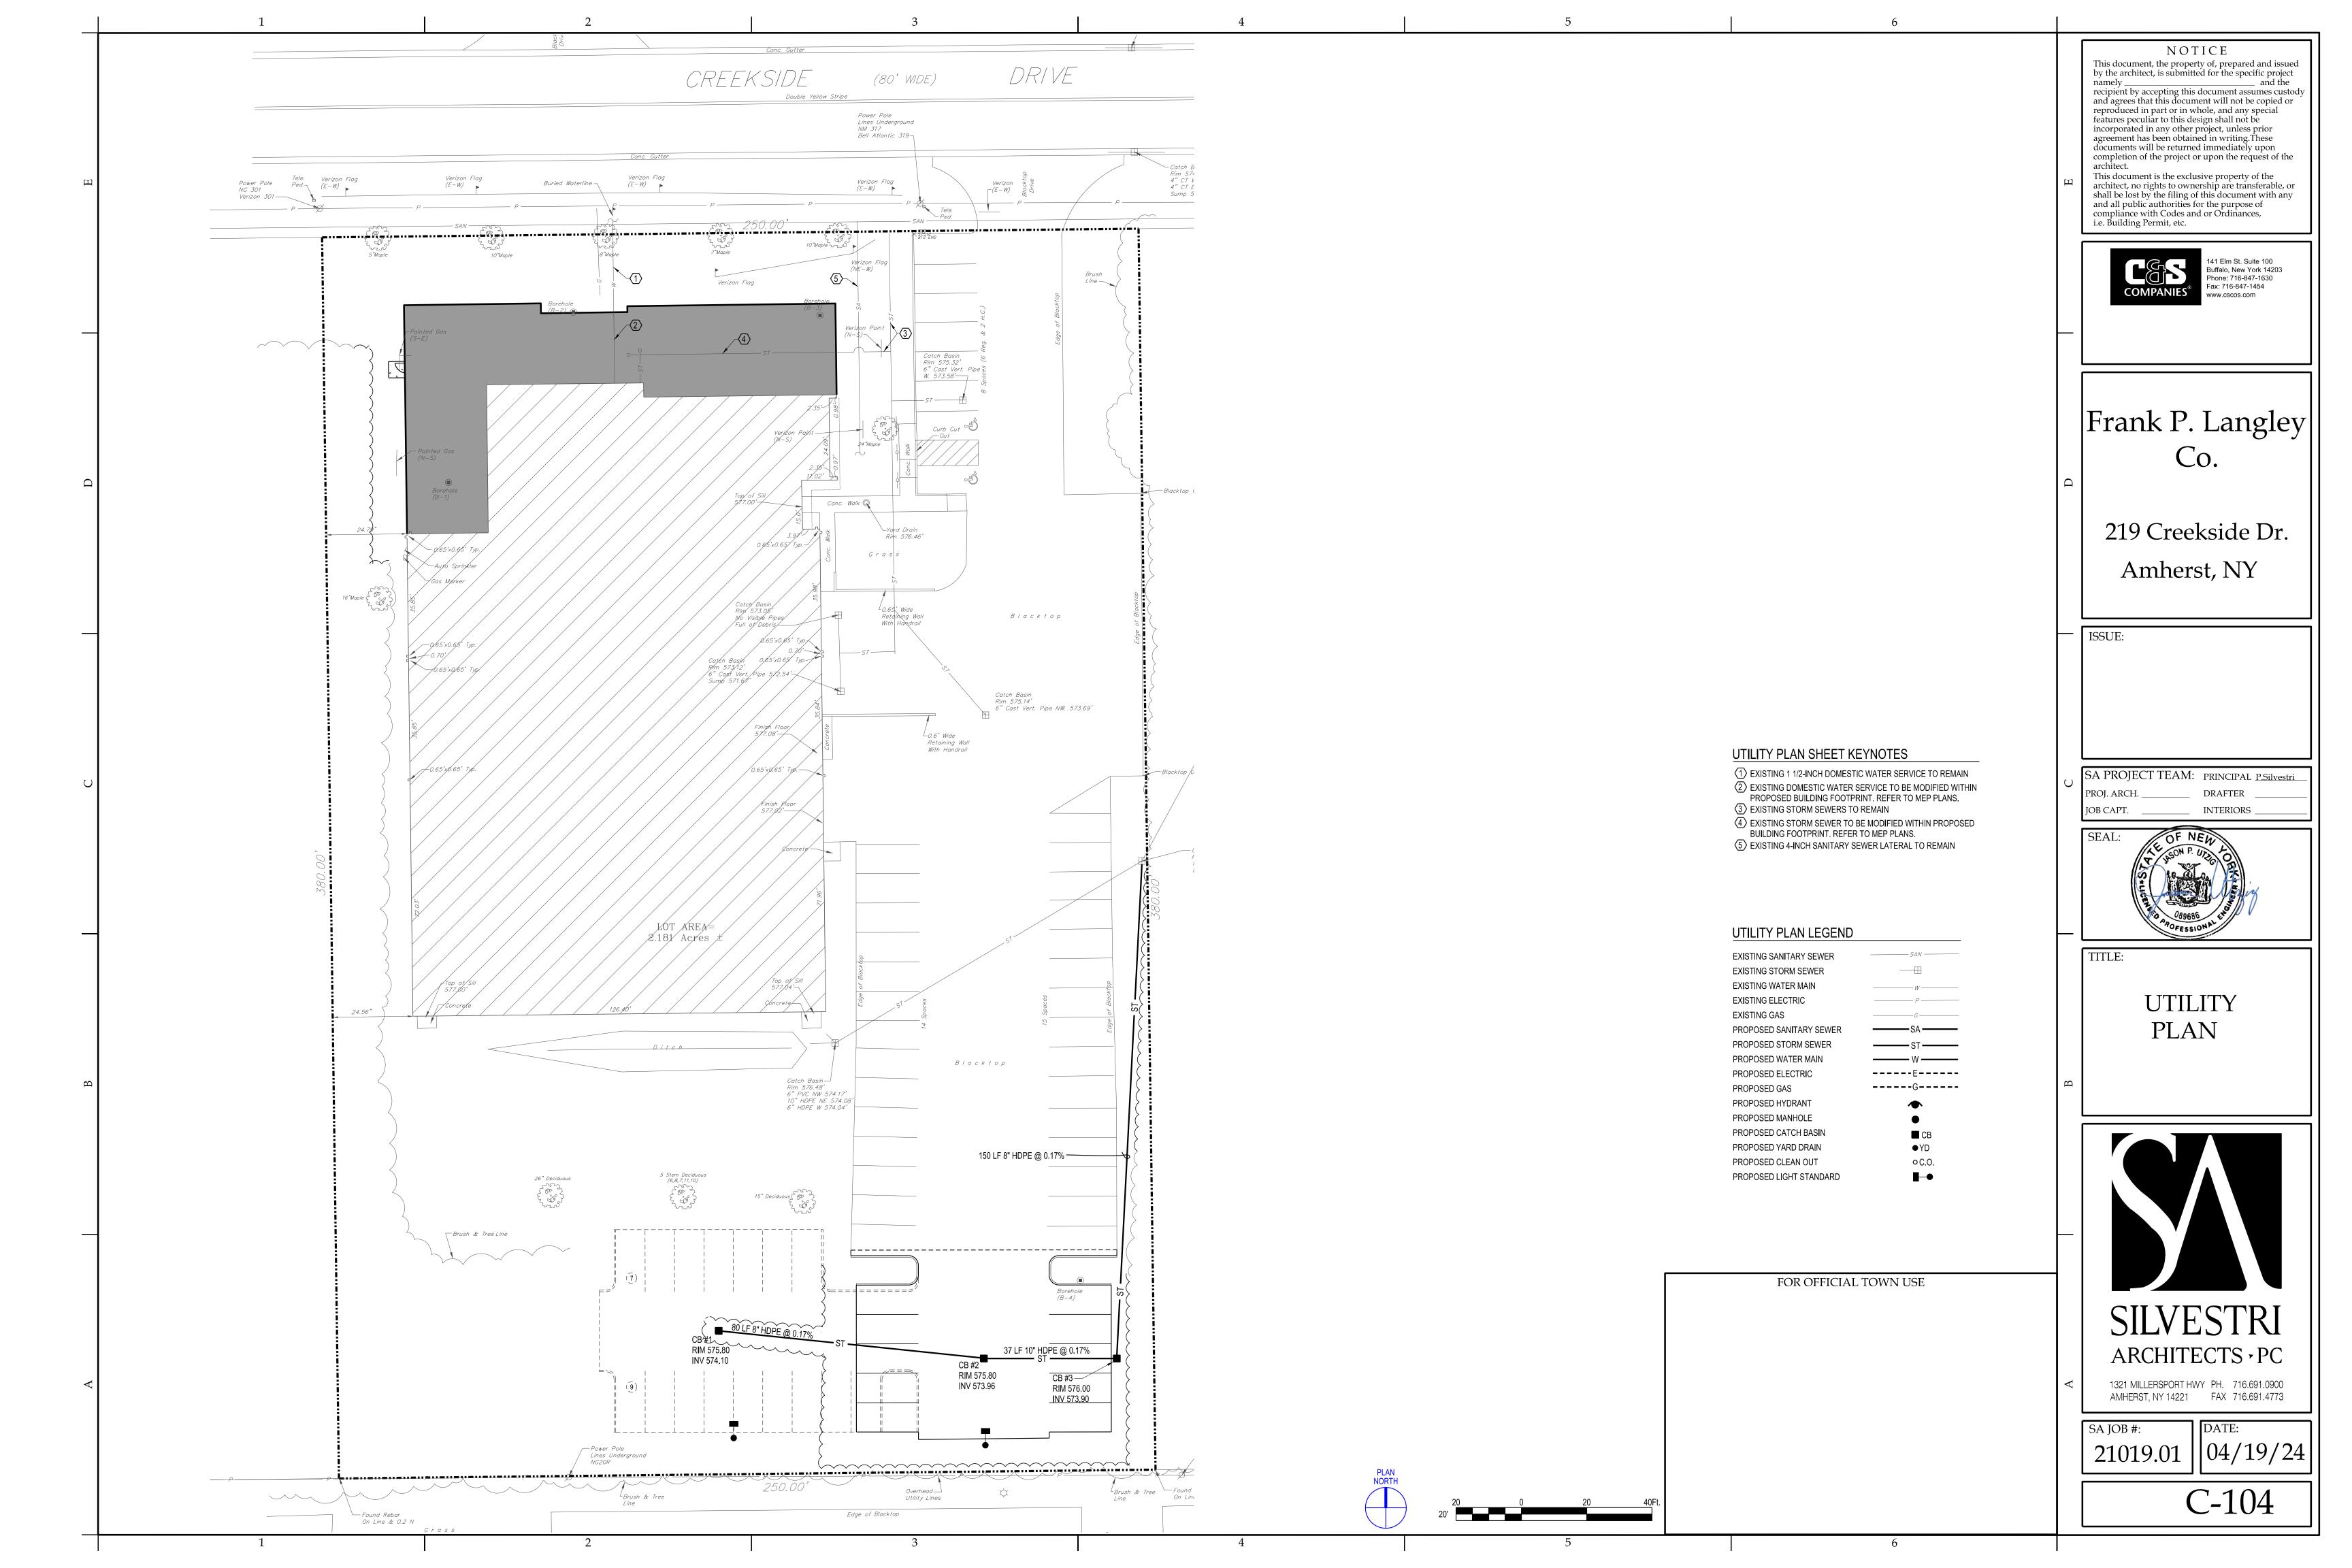

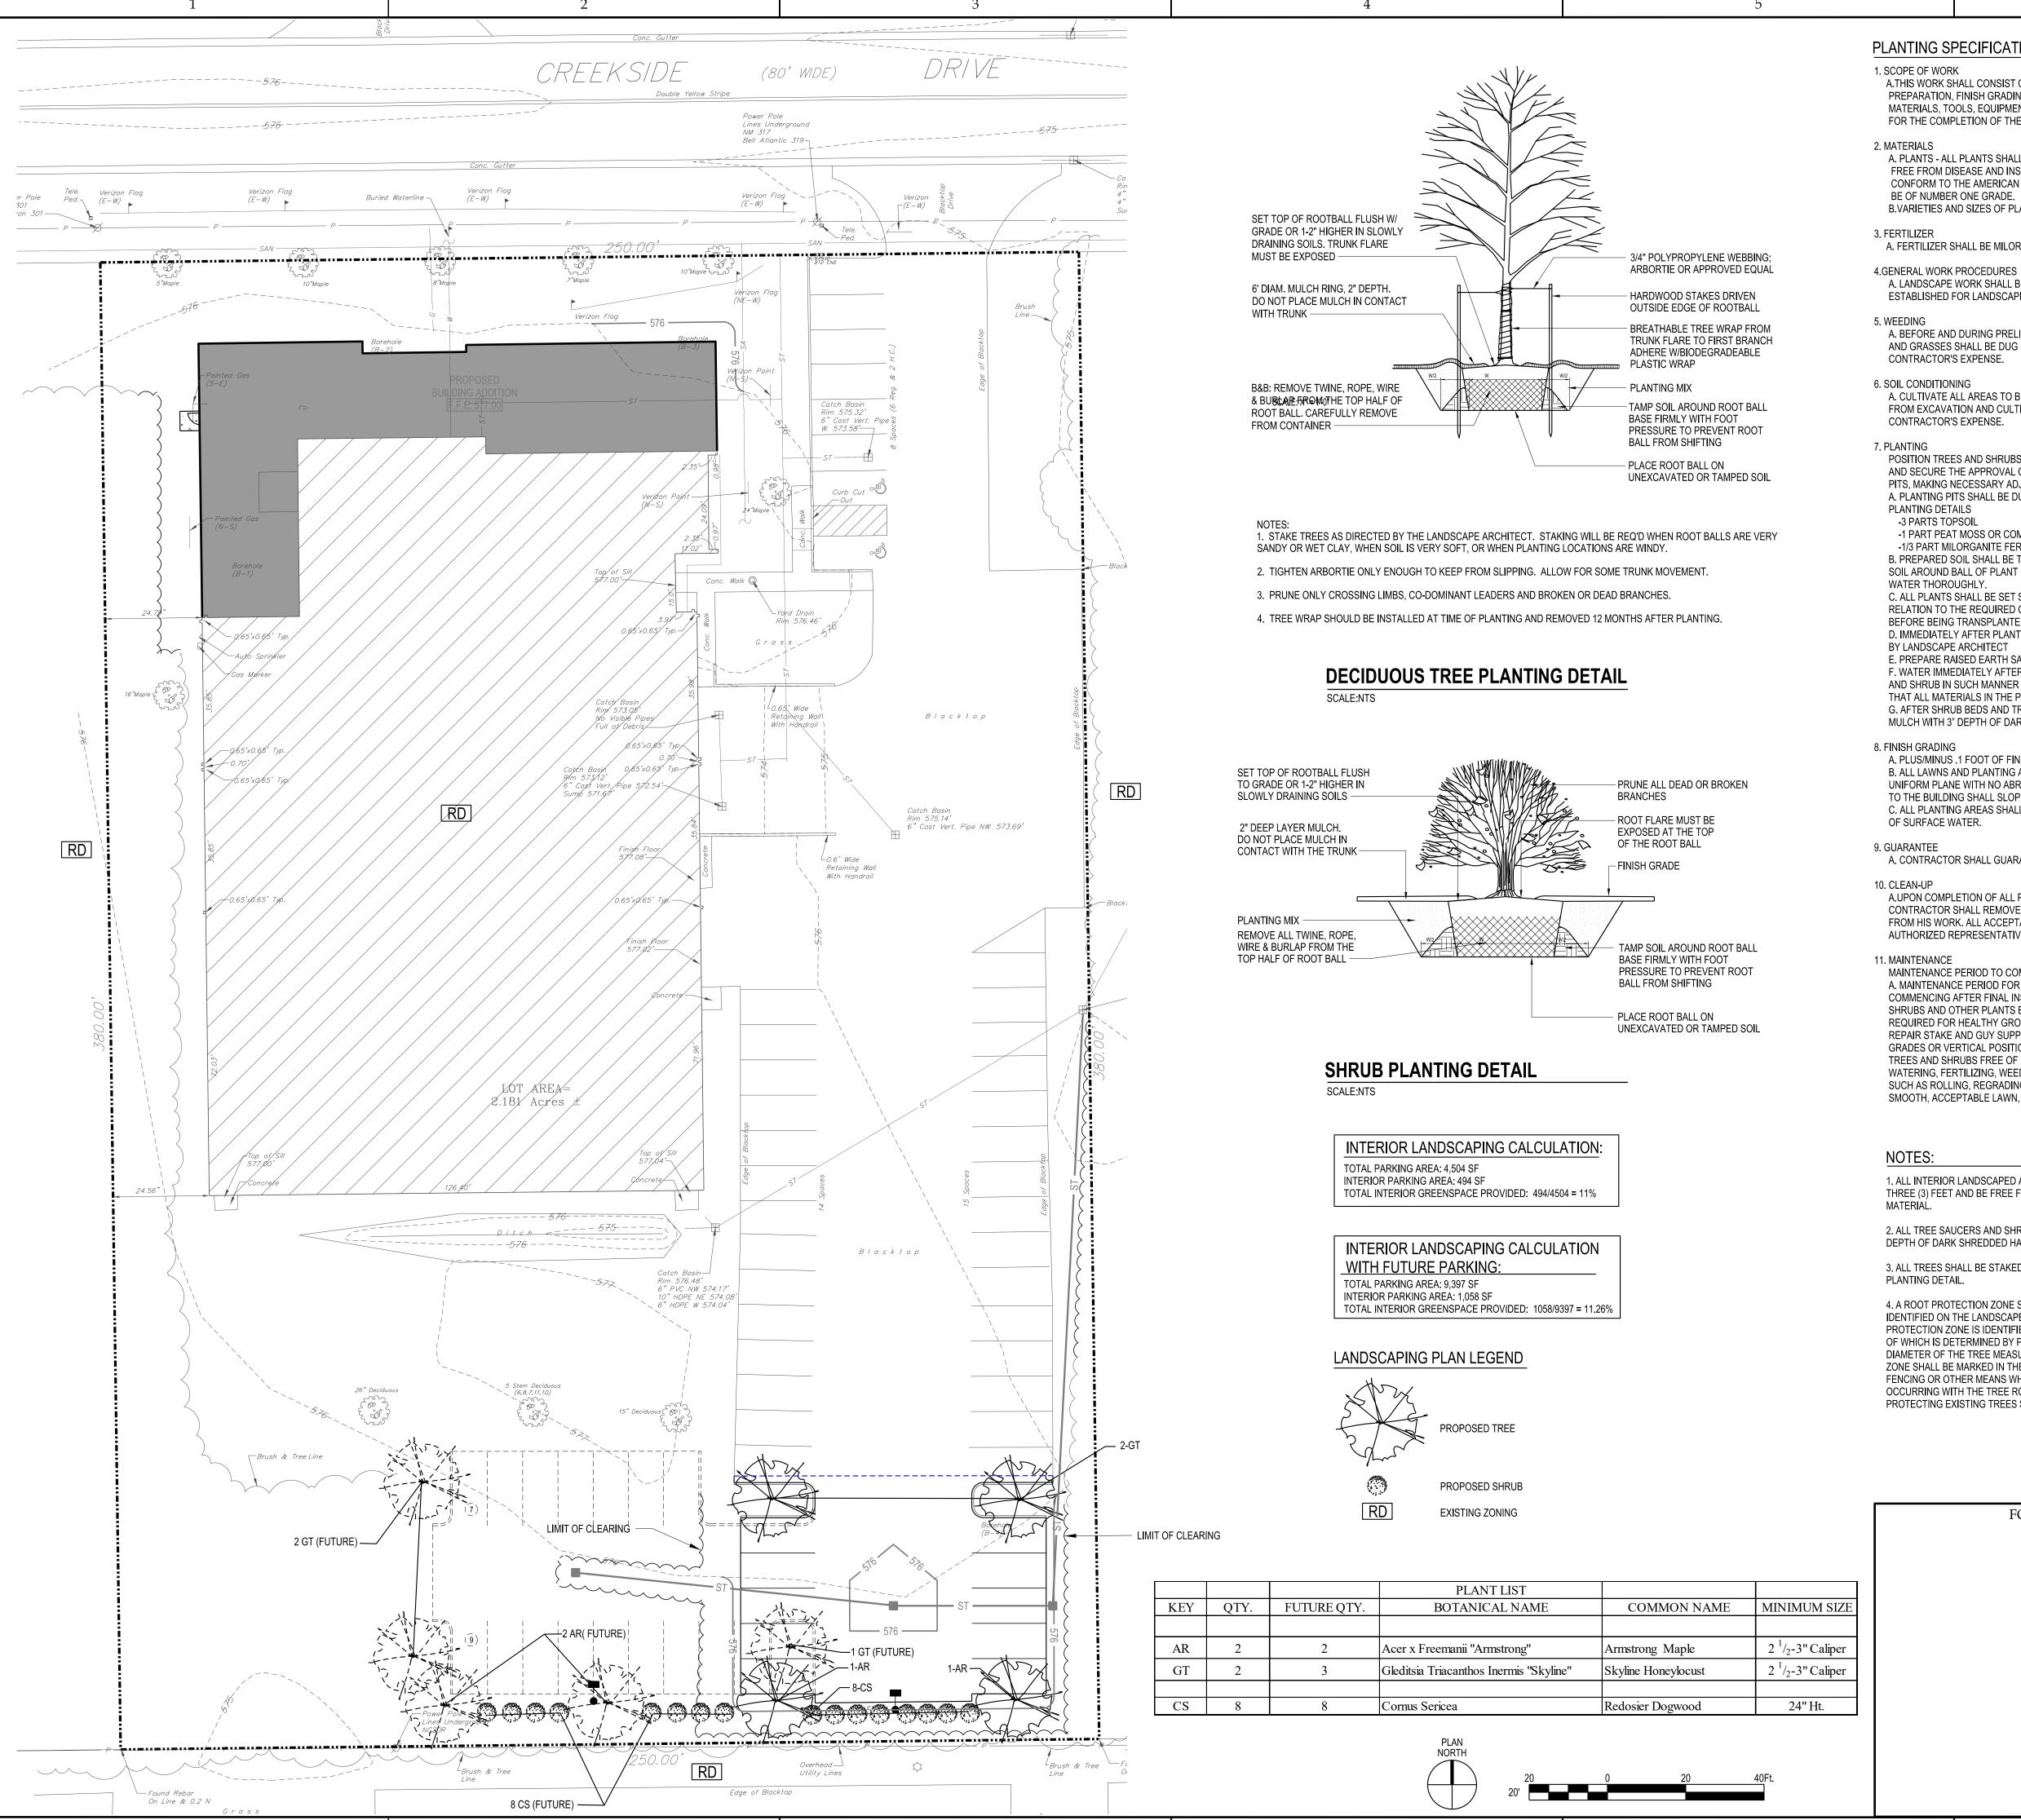

PLANTING SPECIFICATION

A.THIS WORK SHALL CONSIST OF PERFORMING, CLEARING, AND GRUBBING SOIL PREPARATION, FINISH GRADING, PLANTING AND DRAINAGE INCLUDING ALL LABOR MATERIALS, TOOLS, EQUIPMENT, AND ANY OTHER APPURTENANCES NECESSARY FOR THE COMPLETION OF THE PROJECT.

A. PLANTS - ALL PLANTS SHALL BE HEALTHY, OF NORMAL GROWTH, WELL ROOTED, FREE FROM DISEASE AND INSECTS. QUALITY AND PLANT MATERIAL SHALL

CONFORM TO THE AMERICAN STANDARDS FOR NURSERY STOCK (ANSI Z60.1) AND BE OF NUMBER ONE GRADE.

B. VARIETIES AND SIZES OF PLANTS SHALL BE SHOWN ON DRAWING.

A. FERTILIZER SHALL BE MILORGANITE (6-2-0) OR APPROVED EQUAL

A. LANDSCAPE WORK SHALL BE ACCORDING TO THE WORKMANLIKE STANDARDS ESTABLISHED FOR LANDSCAPING CONSTRUCTION AND PLANTING.

A. BEFORE AND DURING PRELIMINARY GRADING AND FINISH GRADING, ALL WEEDS

AND GRASSES SHALL BE DUG OUT BY THE ROOTS AND DISPOSED OF AT THE CONTRACTOR'S EXPENSE.

A. CULTIVATE ALL AREAS TO BE PLANTED TO A DEPTH OF 6". ALL DEBRIS EXPOSED FROM EXCAVATION AND CULTIVATION SHALL BE DISPOSED OF AT THE CONTRACTOR'S EXPENSE.

POSITION TREES AND SHRUBS AT THEIR INTENDED LOCATIONS AS PER THE PLANS AND SECURE THE APPROVAL OF THE LANDSCAPE ARCHITECT BEFORE EXCAVATING PITS, MAKING NECESSARY ADJUSTMENTS AS DIRECTED. A. PLANTING PITS SHALL BE DUG WITH LEVEL BOTTOMS. AS SHOWN ON THE

-3 PARTS TOPSOIL -1 PART PEAT MOSS OR COMPOST

-1/3 PART MILORGANITE FERTILIZER B. PREPARED SOIL SHALL BE TAMPED FIRMLY AT BOTTOM OF PIT. FILL PREPARED SOIL AROUND BALL OF PLANT 1/2 WAY, AND WATER. COMPLETE BACK-FILLING AND

C. ALL PLANTS SHALL BE SET SO THAT, WHEN SETTLED, THEY BEAR THE SAME RELATION TO THE REQUIRED GRADE AS THEY BORE TO THE NATURAL GRADE BEFORE BEING TRANSPLANTED.

D. IMMEDIATELY AFTER PLANTING, STAKE ALL TREES PER DETAILS AND AS DIRECTED BY LANDSCAPE ARCHITECT E. PREPARE RAISED EARTH SAUCER AS WIDE AS PLANTING HOLE OF EACH PLANT. F. WATER IMMEDIATELY AFTER PLANTING. WATER SHALL BE APPLIED TO EACH TREE AND SHRUB IN SUCH MANNER AS NOT TO DISTURB BACKFILL AND TO THE EXTENT

THAT ALL MATERIALS IN THE PLANTING HOLE ARE THOROUGHLY SATURATED. G. AFTER SHRUB BEDS AND TREE SAUCERS ARE BACKFILLED AND FINE GRADED, MULCH WITH 3" DEPTH OF DARK, SHREDDED HARDWOOD BARK MULCH.

A. PLUS/MINUS .1 FOOT OF FINISH GRADE B. ALL LAWNS AND PLANTING AREAS SHALL BE GRADED TO A SMOOTH, EVEN UNIFORM PLANE WITH NO ABRUPT CHANGE OF SURFACE. SOIL AREAS ADJACENT TO THE BUILDING SHALL SLOPE AWAY FROM THE BUILDING. C. ALL PLANTING AREAS SHALL BE GRADED AND MAINTAINED TO ALLOW FREE FLOW

A. CONTRACTOR SHALL GUARANTEE ALL PLANTS FOR A PERIOD OF ONE (1) YEAR

A.UPON COMPLETION OF ALL PLANTING WORK AND BEFORE FINAL ACCEPTANCE, THE CONTRACTOR SHALL REMOVE ALL MATERIAL, EQUIPMENT AND DEBRIS RESULTING FROM HIS WORK. ALL ACCEPTABLE CONDITIONS AS APPROVED BY THE OWNERS AUTHORIZED REPRESENTATIVE.

MAINTENANCE PERIOD TO COMMENCE AFTER FINAL INSPECTION A. MAINTENANCE PERIOD FOR THIS CONTRACT SHALL BE 90 CALENDAR DAYS COMMENCING AFTER FINAL INSPECTION OF CONSTRUCTION. MAINTAIN TREES, SHRUBS AND OTHER PLANTS BY PRUNING, CULTIVATING AND WEEDING AS REQUIRED FOR HEALTHY GROWTH. RESTORE PLANTING SAUCERS. TIGHTEN AND REPAIR STAKE AND GUY SUPPORT AND RESET TREES AND SHRUBS TO PROPER GRADES OR VERTICAL POSITION AS REQUIRED. SPRAY AS REQUIRED TO KEEP TREES AND SHRUBS FREE OF INSECTS AND DISEASE. MAINTAIN LAWNS BY WATERING, FERTILIZING, WEEDING, MOWING, TRIMMING, AND OTHER OPERATIONS SUCH AS ROLLING, REGRADING AND REPLANTING AS REQUIRED TO ESTABLISH A SMOOTH, ACCEPTABLE LAWN, FREE OF ERODED OR BARE AREAS.

1. ALL INTERIOR LANDSCAPED AREA SHALL HAVE A MINIMUM PLANTING SOIL DEPTH OF THREE (3) FEET AND BE FREE FROM ALL FORMS OF CONSTRUCTION DEBRIS AND FOREIGN

2. ALL TREE SAUCERS AND SHRUB BEDS SHALL RECEIVE A MINIMUM OF THREE (3) INCHES DEPTH OF DARK SHREDDED HARDWOOD BARK MULCH.

3. ALL TREES SHALL BE STAKED WITH THREE (3) WOOD STAKES AS SHOWN ON THE TREE

4. A ROOT PROTECTION ZONE SHALL BE ESTABLISHED AROUND ANY TREE WHICH IS IDENTIFIED ON THE LANDSCAPE PLAN AS A TREE TO BE PRESERVED. THE ROOT PROTECTION ZONE IS IDENTIFIED BY CREATING A CIRCLE AROUND THE TREE, THE SIZE OF WHICH IS DETERMINED BY PROVIDING ONE FOOT OF RADIUS FOR EVERY INCH DIAMETER OF THE TREE MEASURED AT BREAST HEIGHT (DBH). THE ROOT PROTECTION ZONE SHALL BE MARKED IN THE FIELD WITH A PHYSICAL BARRIER SUCH AS TEMPORARY FENCING OR OTHER MEANS WHICH SHALL PREVENT CONSTRUCTION ACTIVITIES FROM OCCURRING WITH THE TREE ROOT PROTECTION ZONE. METHODS FOR PRESERVING AND PROTECTING EXISTING TREES SHALL BE INCLUDED AS PART OF THE LANDSCAPE PLAN.

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Frank P. Langley Co.

219 Creekside Dr. Amherst, NY

ISSUE:

SA PROJECT TEAM: PRINCIPAL P.Silvestri PROJ. ARCH. DRAFTER JOB CAPT. **INTERIORS**




LANDSCAPING PLAN




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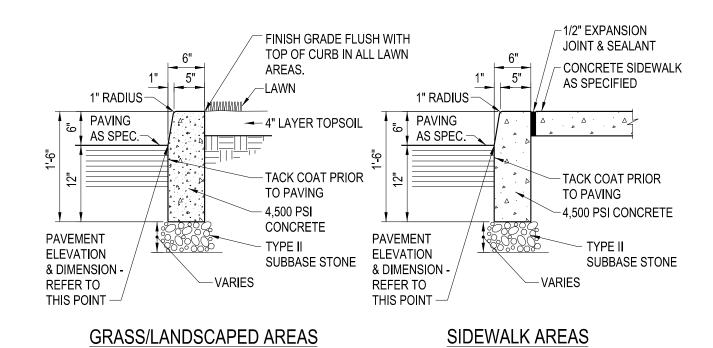
C-105



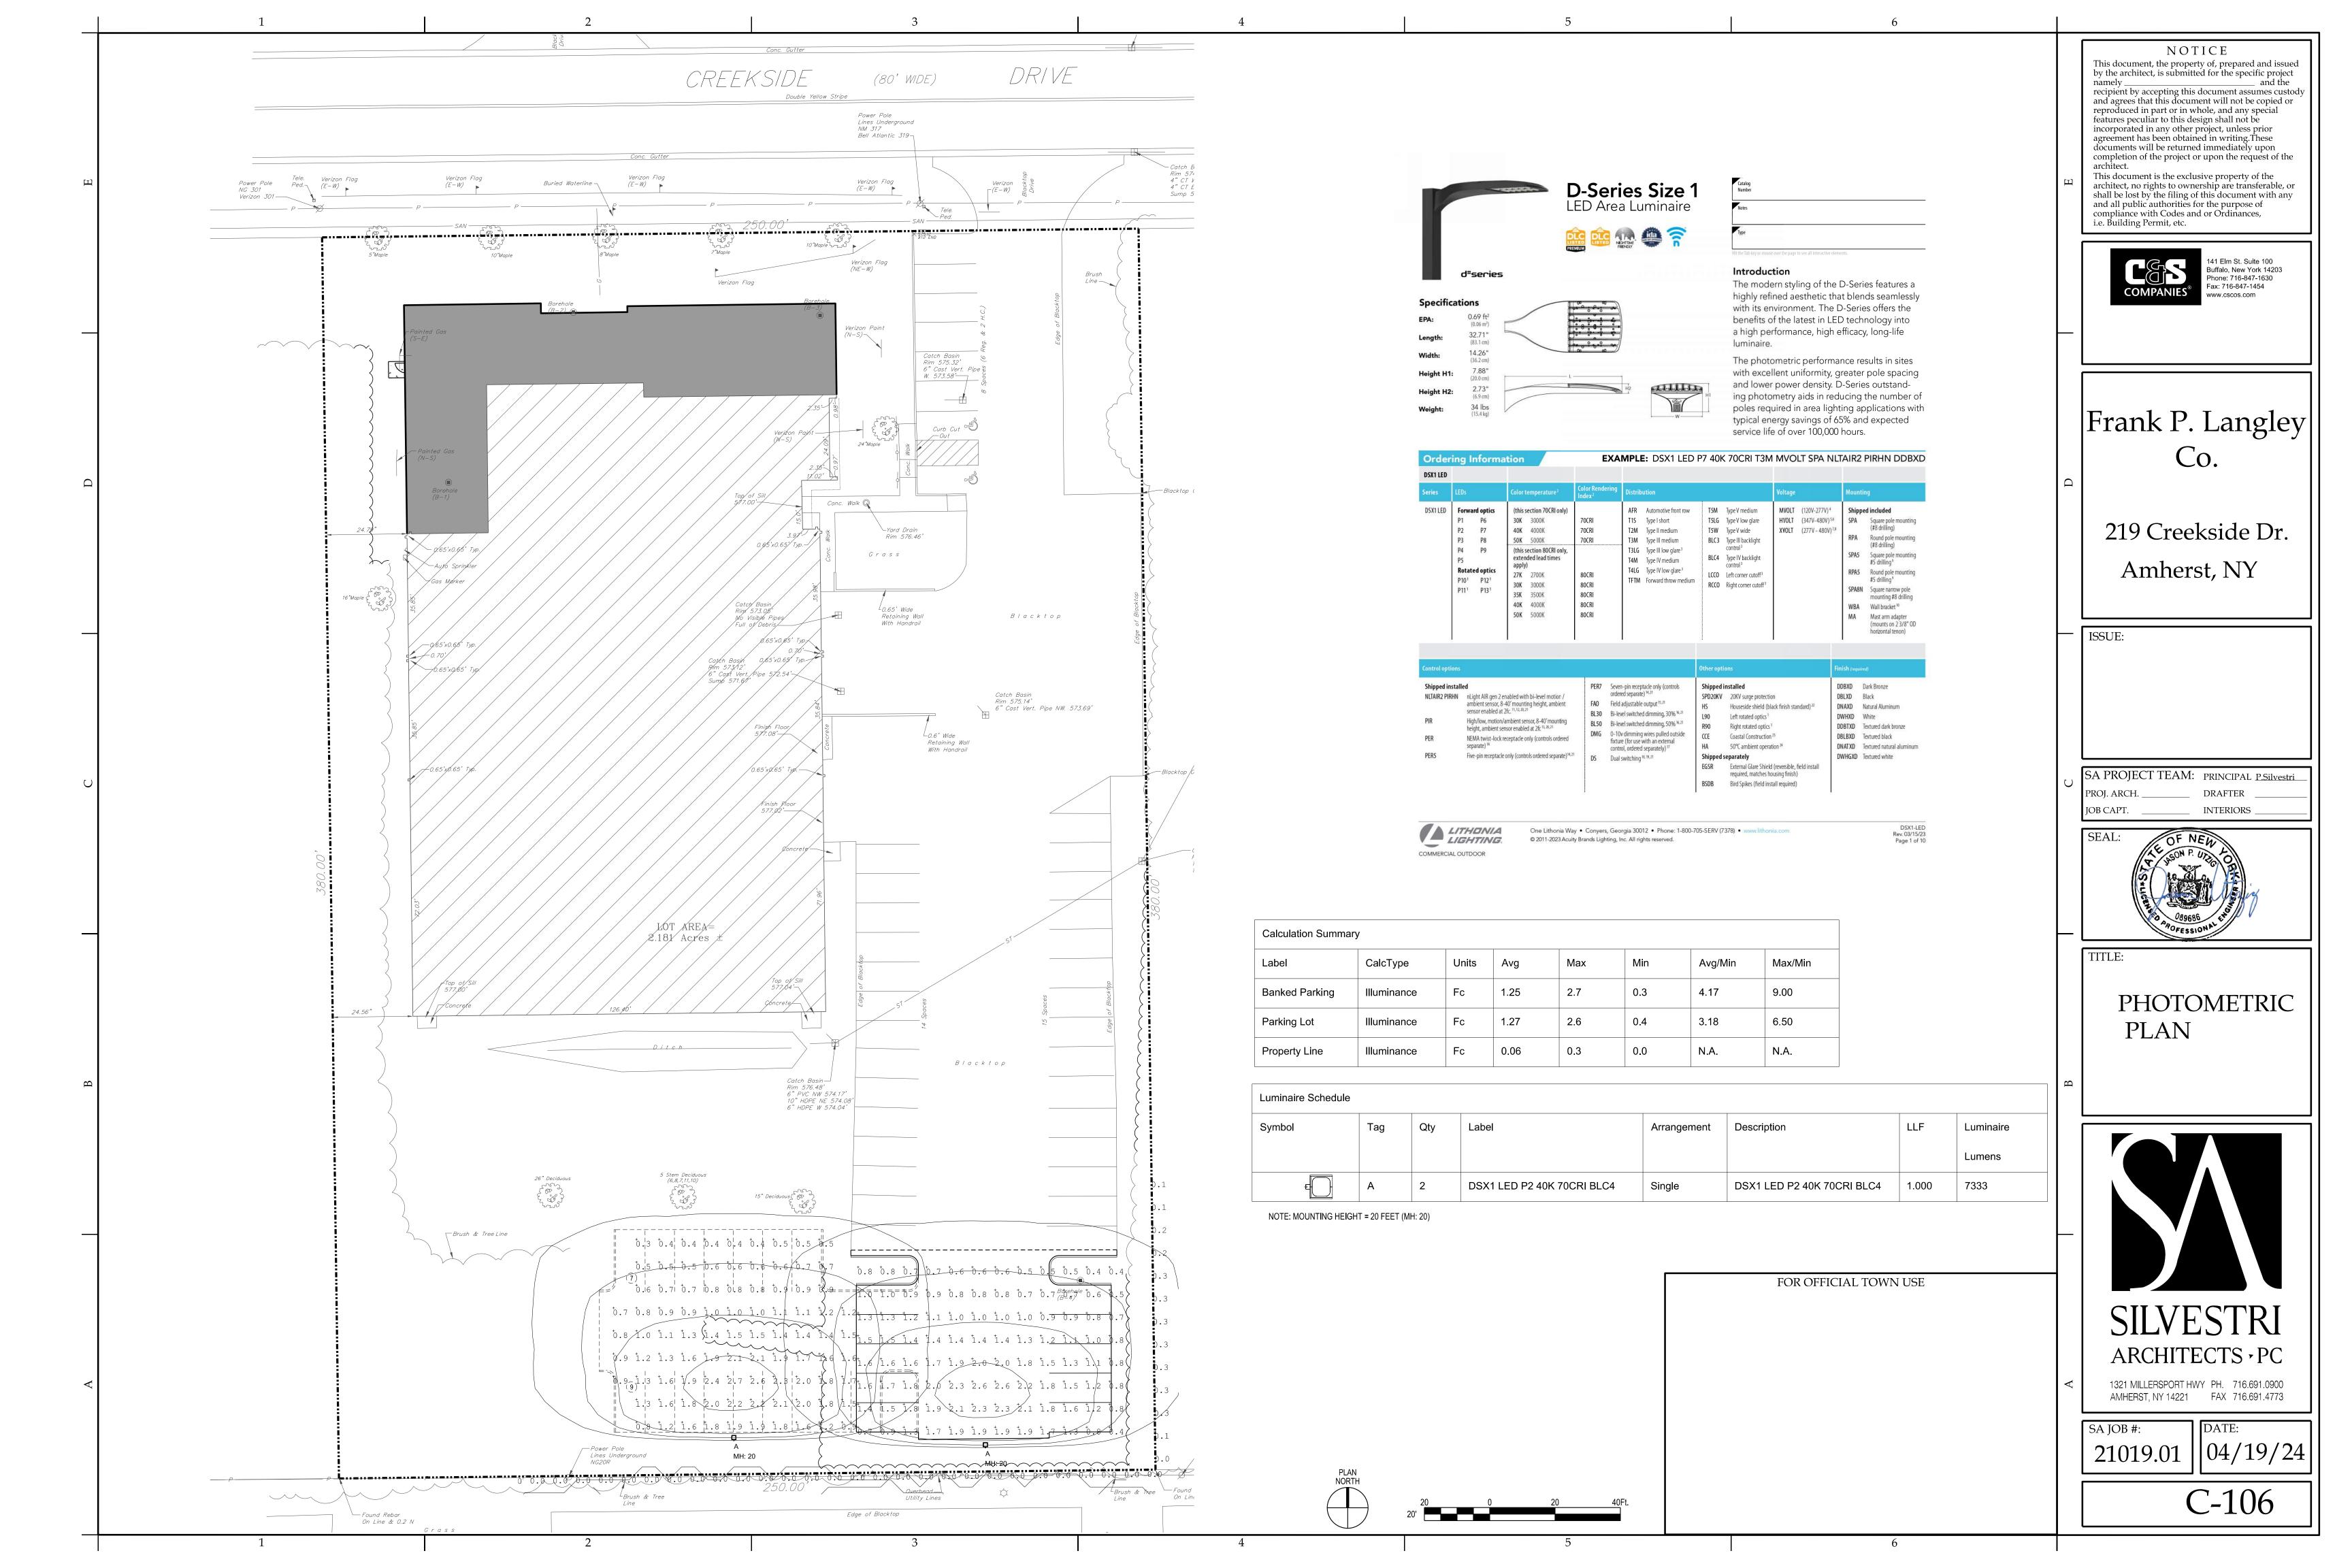


NOTE: CONSTRUCTION METHODS FOR ASPHALT PAVEMENT SHALL CONFORM TO FORMER NYSDOT STANDARD SPECIFICATION 401.3, WITH SUBBASE CONSTRUCTION METHODS CONFORMING TO NYSDOT STANDARD SPECIFICATION 304.3.

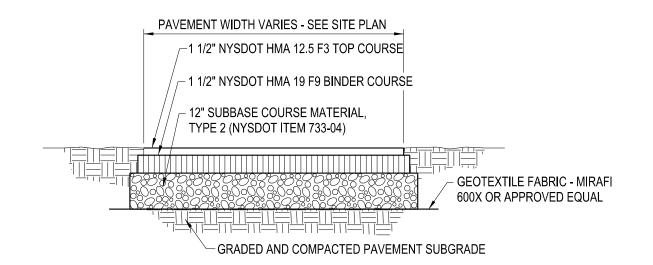1 ASPHALT PAVEMENT SECTION SCALE: NTS



NOTE: CONTROL JOINTS TO BE 2" DEEP AT 15'-0". SEE SPECIFICATIONS FOR FURTHER JOINT REQUIREMENTS NYSDOT 702-0700

CONCRETE CURB

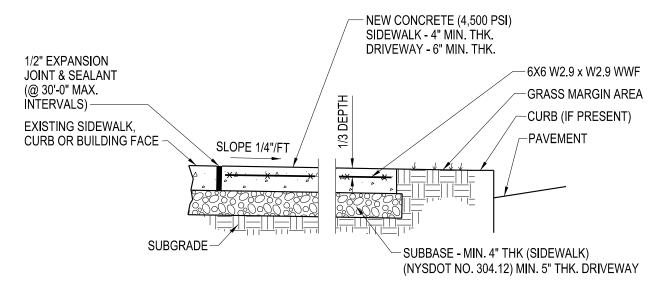


CROSS SECTION

NOTES:

1. CONTROL JOINTS TO BE AT 5'-0" O.C. BOTH WAYS OR AS SHOWN ON DRAWINGS. SEAL JOINTS PER SPECIFICATIONS.

2. CONCRETE SIDEWALK AND DRIVEWAY MATERIAL SHALL CONFORM TO NYSDOT STANDARD SPECIFICATION 501 AND CONSTRUCTION METHODS SHALL CONFORM TO NYSDOT STANDARD SPECIFICATION 608-3

3 CONCRETE SIDEWALK SCALE: NTS

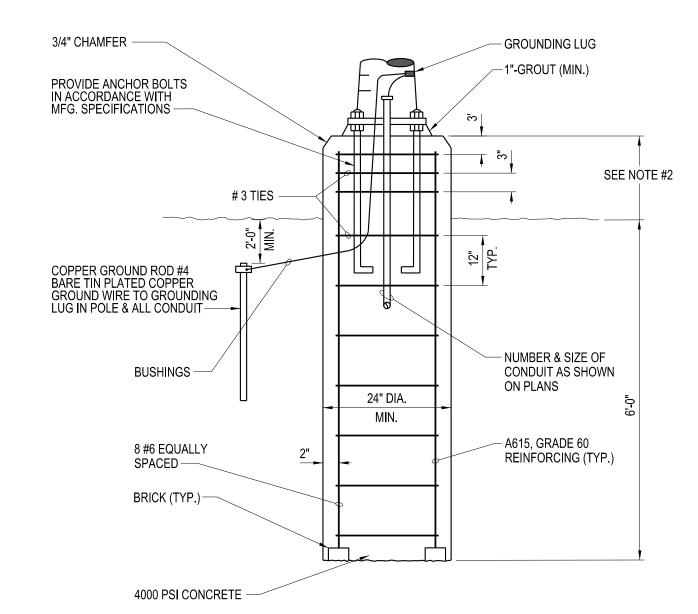

NOTES:

1. AUGER HOLES FOR FOOTING, INSPECT THE EXCAVATION & NOTIFY THE ENGINEER OF UNSUITABLE MATERIALS BEFORE PLACING THE STEEL & CONCRETE.

2. LIGHT POLE BASE SHALL BE: 30" ABOVE GRADE IN PAVED AREAS
6" ABOVE GRADE IN LANDSCAPED AREAS

3. FOR LOCATIONS OF LIGHT POLES, SEE SITE PLAN.

4 LIGHT POLE FOUNDATION 'A'
SCALE: NTS

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ISSUE:

SA PROJECT TEAM: PRINCIPAL P.Silvestri
PROJ. ARCH. _____ DRAFTER _____

JOB CAPT. ____



INTERIORS

TITI E.

SITE DETAILS

SILVESTRI ARCHITECTS · PC

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SA JOB #: DATE:

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C-501

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THE FOLLOWING EROSION CONTROL PROCEDURE SHALL BE ADHERED TO BY THE CONTRACTOR:

1. INSTALL TEMPORARY SILT FENCE BARRIERS AS SHOWN ON THE PLAN AND AT ALL EXISTING STORMWATER CATCH BASINS WITHIN THE WORK AREA TO PREVENT SEDIMENT MIGRATION. ALL SILT FENCE/SOCK BARRIERS SHALL BE INSTALLED IN ACCORDANCE WITH THE DETAILS SHOWN ON THE PLANS.

2. THE TOPSOIL SHALL BE STRIPPED & STOCKPILED ON SITE FOR RE-USE AS DIRECTED BY THE OWNER. ALL LOCAL ORDINANCES REGARDING THE SALE AND/OR REMOVAL OF TOPSOIL FROM THE SITE MUST BE FOLLOWED.

3. ALL SILT FENCES/SOCKS SHALL BE REPLACED WHENEVER THEY BECOME CLOGGED OR INOPERABLE.

4. THE CONTRACTOR SHALL BE RESPONSIBLE FOR MAINTENNACE & REMOVAL OF TEMPORARY SEDIMENTATION CONTROLS.

5. THE CONTRACTOR MUST CONTROL DUST DURING CONSTRUCTION. DURING EARTHWORK OPERATIONS, WATER SPREADING EQUIPMENT SHALL BE PROVIDED BY THE CONTRACTOR AND WATER APPLIED AS NECESSARY AND AS DIRECTED BY THE OWNER IN ORDER TO CONTROL DUST.

6. DIRT OR DEBRIS LEFT ON LOCAL PUBLIC ROADS AS A RESULT OF THIS CONSTRUCTION PROJECT SHALL BE REMOVED & ROAD SURFACES CLEANED BY THE CONTRACTOR ON A DAILY BASIS.

7. ALL DISTURBED AREAS (EXCEPT AREAS TO BE PAVED OR BUILT UPON) SHALL BE TOPSOILED TO A MINIMUM 4" DEPTH & SEEDED IMMEDIATELY AFTER FINE GRADING TAKES PLACE & AS SOON AS PHYSICALLY POSSIBLE.

8. THE CONTRACTOR IS RESPONSIBLE FOR THE MAINTENANCE OF DOWNSTREAM STORM SEWERS, DITCHES & CULVERTS. SILT BUILD-UP FOUND TO BE A RESULT OF THIS SITE CONSTRUCTION WORK SHALL BE REMOVED FROM DOWNSTREAM CULVERTS BY THE CONTRACTOR AT NO ADDITIONAL EXPENSE TO THE OWNER OR THE TOWN.

9. IN ADDITION TO STORM WATER DISCHARGES, THE FOLLOWING NON-STORM WATER DISCHARGES MAY CONTRIBUTE TO THE RUN-OFF FROM THE SITE:

- WATER FROM WATER SERVICE FLUSHINGS

- WATER USED TO WASH DOWN CONSTRUCTION VEHICLES (NO DETERGENTS)
- WATER USED FOR DUST CONTROL
- UNCONTAMINATED GROUNDWATER

10. THE ABOVE NON-STORM WATER FLOWS SHALL BE TREATED IN THE SAME MANNER AS STORM WATER FLOWS

STORM SEWER GRATE —


REINFORCED

MANAGEABLE 2 FOOT CONTAINMENT AREA DANDY SACK™

STRAPS

- DUMPING STRAPS

INLET

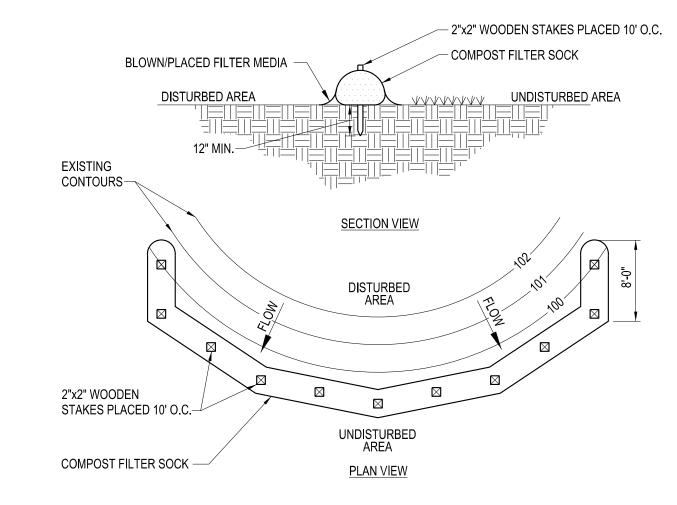

ADAPTED FROM DETAILS PROVIDED BY: FILTREXX						
COMPOST STANDARDS TABLE						
DRGANIC MATTER CONTENT	25% - 100% (DRY WEIGHT)					
RGANIC PORTION	FIBROUS & ELONGATED					
PH	6.0 - 8.0					
ACICTUDE CONTENT	200/ 600/					

MOISTURE CONTENT

30% - 60%

PARTICLE SIZE

100 % PASSING A 1" SCREEN
10 - 50% PASSING A 3/8" SCREEN

SOLUBLE SALT CONCENTRATION

5.0 ds/M (mmhos/cm) MAXIMUM

1. SOCK FABRIC SHALL MEET STANDARDS OF TABLE 5.1. COMPOST SHALL MEET THE STANDARDS LISTED ON OF

2. COMPOST FILTER SOCK SHALL BE PLACED AT EXISTING LEVEL GRADE. BOTH ENDS OF THE SOCK SHALL BE EXTENDED AT LEAST 8 FEET UP SLOPE AT 45 DEGREES TO THE MAIN SOCK ALIGNMENT (FIGURE 5.2). MAXIMUM SLOPE LENGTH ABOVE ANY SOCK SHALL NOT EXCEED THAT SHOWN ON FIGURE X.X. STAKES MAY BE INSTALLED IMMEDIATELY DOWNSLOPE OF THE SOCK IF SO SPECIFIED BY THE MANUFACTURER.

3. TRAFFIC SHALL NOT BE PERMITTED TO CROSS FILTER SOCKS.

4. ACCUMULATED SEDIMENT SHALL BE REMOVED WHEN IT REACHES HALF THE ABOVE GROUND HEIGHT OF THE SOCK & DISPOSED IN THE MANNER DESCRIBED ELSEWHERE IN THE PLAN.

5. SOCKS SHALL BE INSPECTED WEEKLY AND AFTER EACH RUNOFF EVENT. DAMAGED SOCKS SHALL BE REPAIRED ACCORDING TO MANUFACTURER'S SPECIFICATIONS OR REPLACED WITHIN 24 HOURS OF INSPECTION.

6. BIODEGRADABLE FILTER SOCKS SHALL BE REPLACED AFTER 6 MONTHS; PHOTODEGRADABLE SOCKS AFTER 1 YEAR. POLYPROPYLENE SOCKS SHALL BE REPLACED ACCORDING TO MANUFACTURER'S RECOMMENDATIONS.

7. UPON STABILIZATION OF THE AREA TRIBUTARY TO THE SOCKS, STAKES SHALL BE REMOVED. THE SOCK MAY BE LEFT IN PLACE AND VEGETATED OR REMOVED. IN THE LATTER CASE, THE MESH SHALL BE CUT OPEN AND THE MULCH SPREAD AS A SOIL SUPPLEMENT.

COMPOST FILTER SOCK

SCALE:NTS

DANDY SACKTM SPECIFICATIONS

NOTE: THE DANDY SACKTM WILL BE MANUFACTURED IN THE U.S.A. FROM A WOVEN MONOFILAMENT FABRIC THAT MEETS OR EXCEEDS THE FOLLOWING SPECIFICATIONS:

REGULAR FLOW DANDY SACKTM (BLACK)

MECHANICAL PROPERTIES	TEST METHOD	UNITS	MARV
GRAB TENSILE STRENGTH	ASTM D 4632	kN (lbs)	1.78 (400) x 1.40 (315)
GRAB TENSILE ELONGATION	ASTM D 4632	%	15 x 15
PUNCTURE STRENGTH	ASTM D 4833	kN (lbs)	0.67 (150)
MULLEN BURST STRENGTH	ASTM D 3786	kPa (psi)	5506 (800)
TRAPEZOID TEAR STRENGTH	ASTM D 4533	kN (lbs)	0.67 (150) x 0.73 (165)
UV RESISTANCE	ASTM D 4355	%	90
APPARENT OPENING SIZE	ASTM D 4751	Mm (US Std Sieve)	0.425 (40)
FLOW RATE	ASTM D 4491	1/min/m² (gal/min/ft²)	2852 (70)
PERMITTIVITY	ASTM D 4491	Sec ⁻¹	0.90


HI-FLOW DANDY SACKTM (SAFETY ORANGE)

MECHANICAL PROPERTIES	TEST METHOD	UNITS	MARV
GRAB TENSILE STRENGTH	ASTM D 4632	kN (lbs)	1.62 (365) X 0.89 (200)
GRAB TENSILE ELONGATION	ASTM D 4632	%	24 X 10
PUNCTURE STRENGTH	ASTM D 4833	kN (lbs)	0.40 (90)
MULLEN BURST STRENGTH	ASTM D 3786	kPa (psi)	3097 (450)
TRAPEZOID TEAR STRENGTH	ASTM D 4533	kN (lbs)	0.51 (115) X 0.33 (75)
UV RESISTANCE	ASTM D 4355	%	90
APPARENT OPENING SIZE	ASTM D 4751	Mm (US Std Sieve)	0.425 (40)
FLOW RATE	ASTM D 4491	1/min/m² (gal/min/ft²)	5907 (145)
PERMITTIVITY	ASTM D 4491	Sec ⁻¹	2.1

*NOTE: DANDY SACKS $^{\text{TM}}$ CAN BE ORDERED WITH OUR OPTIONAL OIL ABSORBENT PILLOWS.


FILTER SACK INLET PROTECTION

SCALE:NTS

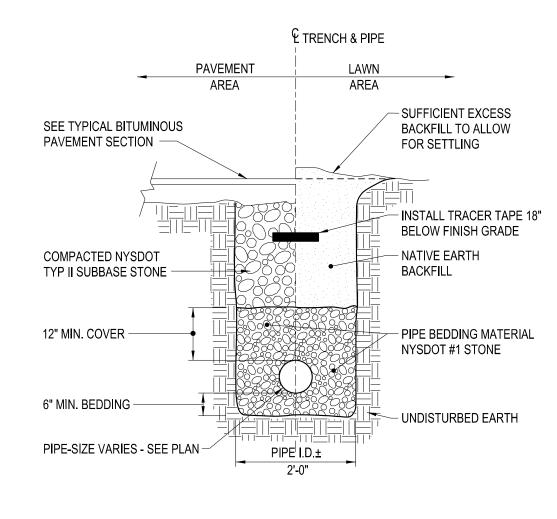

STORM PIPE TRENCH SECTION

SCALE: NTS

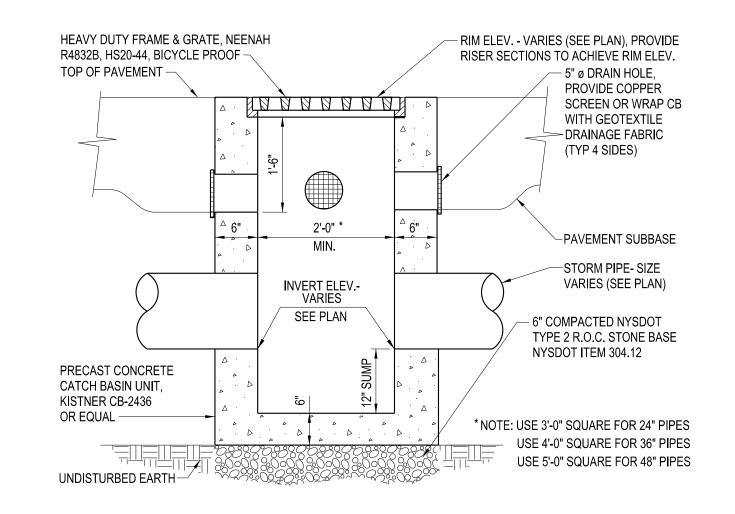

TYPICAL PRECAST CATCH BASIN

SCALE: NTS

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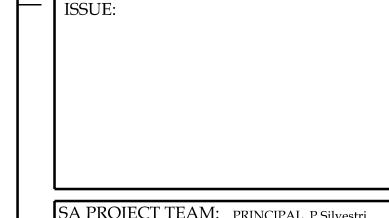
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SA PROJECT TEAM: PRINCIPAL P.Silvestri
PROJ. ARCH. _____ DRAFTER _____
JOB CAPT. ____ INTERIORS _____



TITLE:

EROSION & SEDIMENT CONTROL & STORM DETAILS



SA JOB #: **21019.01**

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