
CENTER FOR JEWISH LIFE 757 HOPKINS ROAD

TOWN OF AMHERST,

ERIE COUNTY,

NEW YORK

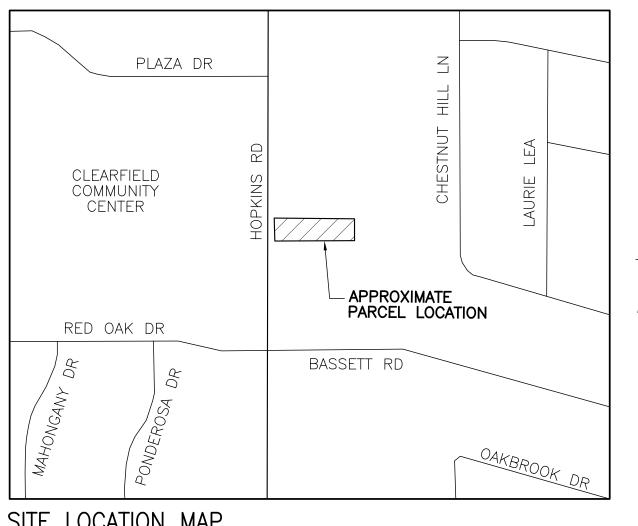

SITE LOCATION MAP

* WHERE APPLICABLE

EXISTING FEATURES* PROPOSED FEATURES* PROJECT BOUNDARY LINE STORM CATCH BASIN • W WATER VALVE ELEC. M.H. E ——SA——SA——SANITARY MANHOLE & LINE SPOT ELEVATION UTILITY POLE WATER VALVE FLOW DIRECTION D. HYDRANT INLET PROTECTION GAS LINE ----- OH ----- OVERHEAD WIRES

METZGER CIVIL ENGINEERING, PLLC

PROJECT LEGEND

STABILIZED CONSTRUCTION ENTRANCE

CIVIL ENGINEER:

757 HOPKINS ROAD

OWNER:

METZGER CIVIL ENGINEERING, PLLC. 8245 SHERIDAN DRIVE WILLIAMSVILLE, NEW YORK 14221 PHONE: (716) 633-2601 FAX: (716) 633-2704 EMAIL: meteng@roadrunner.com

CENTER FOR JEWISH LIFE, INC.

WILLIAMSVILLE, NEW YORK 14221


ARCHITECT:

SUTTON ARCHITECTURE, PLLC 5409 MAIN STREET - SUITE #2 WILLIAMSVILLE, NEW YORK 14221 PHONE: (716) 932-7156 EMAIL: mikeb@design2build.com

SCHEDULE OF DRAWINGS:

<u> </u>		
SHEET NO	<u>DRAWING</u>	DESCRIPTION
1 2 3 4 5 6 7 8	CS-1 DP-1 SP-1 GD-1 ESC-1 LP-1 DT-1	COVER SHEET TRUE NORTH BOUNDARY & TOPOGRAPHY SURVEY DEMOLITION PLAN SITE PLAN GRADING & DRAINAGE PLAN EROSION & SEDIMENT CONTROL PLAN LANDSCAPE PLAN SITE DETAILS

TOWN OF AMHERST NOTES: 1) CONSTRUCTION SHALL BE IN ACCORDANCE WITH ALL TOWN CONSTRUCTION SPECIFICATIONS WHERE APPLICABLE AND/OR SUBJECT TO THE LATEST REVISIONS.

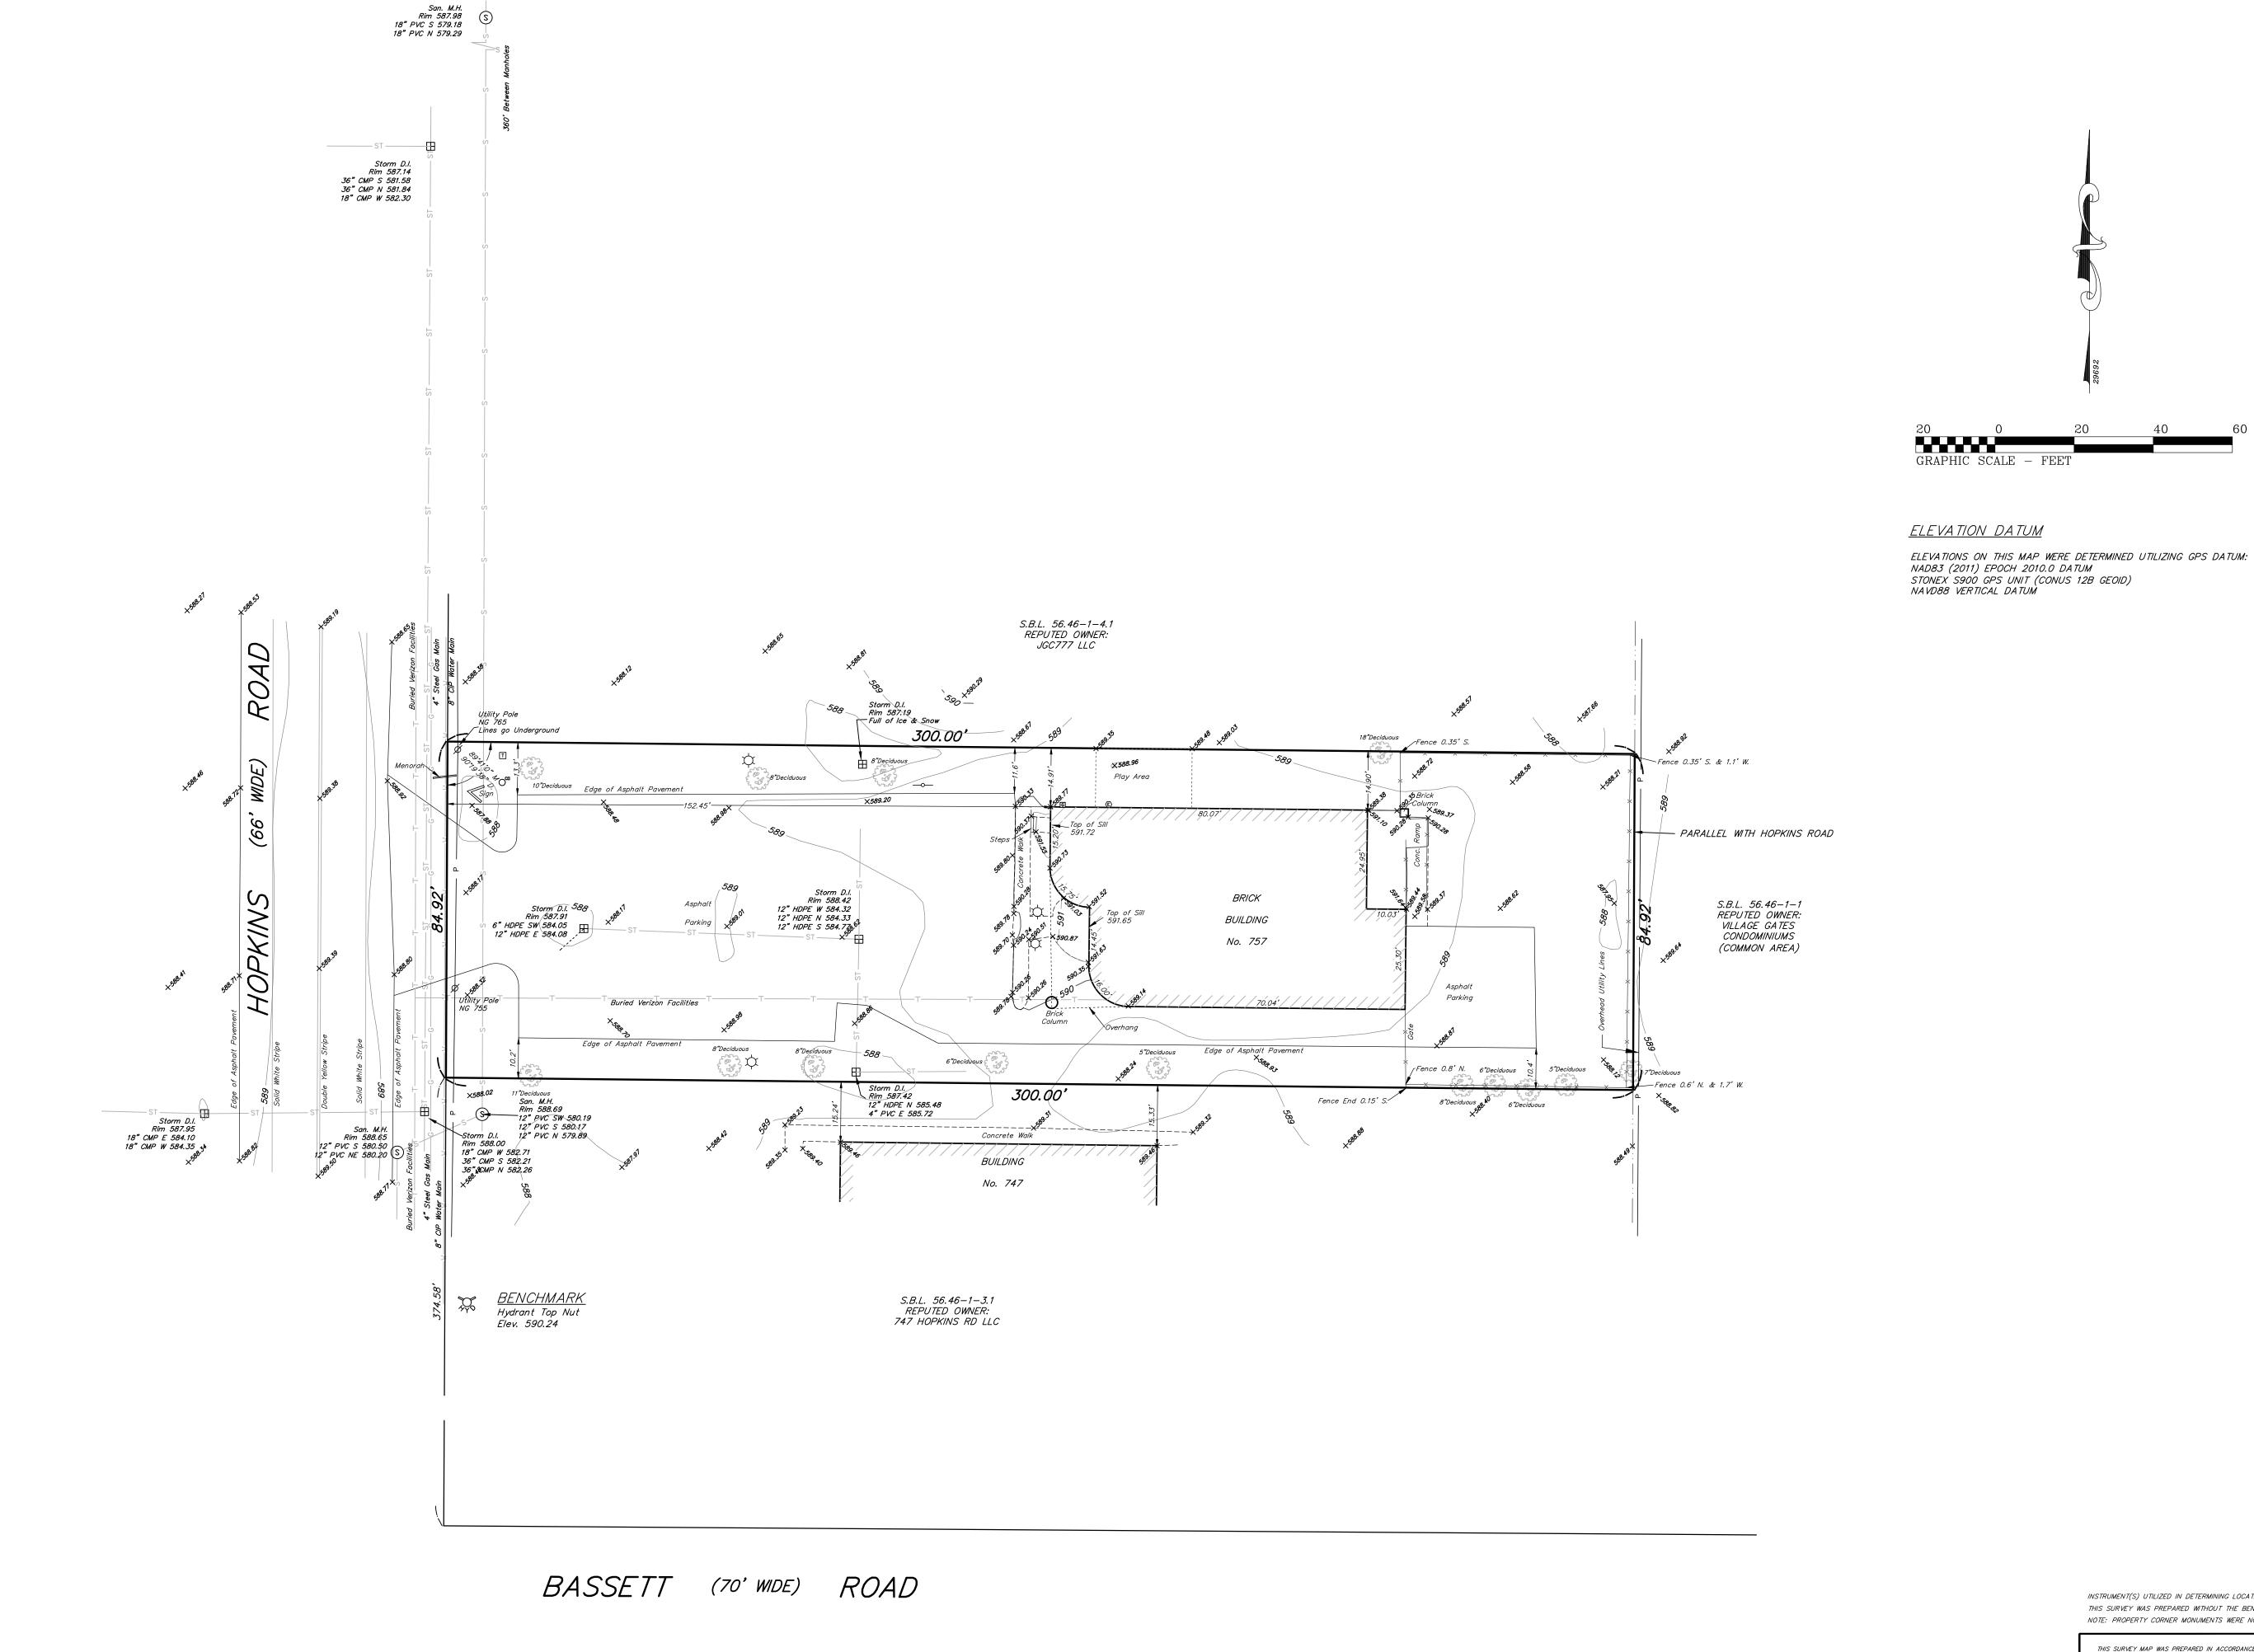



Ø UTILITY / SERVICE POLE

₩ WATER LINE VALVE FIRE HYDRANT

⊞ D.I. (DROP INLET - STORM) MANHOLE (STORM) MANHOLE (ELECTRIC) MANHOLE (TRAFFIC)

MANHOLE (SANITARY)

MANHOLE (TELEPHONE) © GASLINE MARKER ₩ GAS LINE VALVE

\(\triangle \) LIGHT STANDARD —ċ— SIGN H.C. HANDICAP

□ TELEPHONE PEDESTAL

G GAS METER

© ELECTRIC METER

 \bigcirc^{CD} CLEANOUT

D. DEED M. MEASURED L. LIBER

P. PAGE

R.O.W. RIGHT OF WAY

CONC. CONCRETE

INV. INVERT

M.H. MANHOLE

—G— GAS LINE

—T— *TELEPHONE LINE*

—E— ELECTRIC LINE

—P— UTILITY LINES

—C— CABLE LINES

The underground utilities shown have been located from field survey information & existing drawings. The surveyor makes no guarantee that the underground utilities shown comprise all such utilities in the area, either in service or abandoned. The surveyor further does not warrant that the underground utilities shown are in the exact location indicated although he does certify that they are located as accurately as possible from the information available. This surveyor has not physically located the underground utilities.

<u>UTILITIES</u>


Note: Underground Utility information has been ordered from the respective utility companies. As the information is received, this map will be amended to reflect said information.

National Fuel Attn: Ed Kulpa Time Warner Cable Attn: Chris Smith Verizon Attn: Mark Granschow (716) 857-7967 (800) 262–8600 (716) 840–8656 (716) 685–8289

(716) 651-5256

(315) 428–6319

INSTRUMENT(S) UTILIZED IN DETERMINING LOCATION OF BOUNDARY LINES: Liber 11408 Deeds P.1209 (First Described Parcel) THIS SURVEY WAS PREPARED WITHOUT THE BENEFIT OF A CURRENT ABSTRACT OF TITLE AND IS SUBJECT TO ANY STATE OF FACTS THAT MAY BE REVEALED IN SAID ABSTRACT. NOTE: PROPERTY CORNER MONUMENTS WERE NOT PLACED AS PART OF THIS SURVEY. NOTE: THIS SURVEY WAS PERFORMED UNDER SEVERE SNOW AND ICE CONDITIONS.

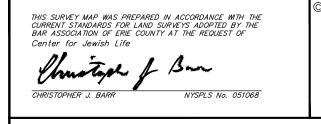

PYRIGHT <u>2025</u> BY:
TRUE NORTH
LAND SURVEYING, PLLC
150 AERO DRIVE
BUFFALO, NEW YORK 14225 6)631—5140 ~ Truenorthpllc@aol.com
-,

SURVEY DATE: 2-12-25 $^{\circ}$ drawing date: 2-18-25SCALE: 1" = 20'"ALL RIGHTS RESERVED"


AMEND:

BOUNDARY AND TOPOGRAPHIC SURVEY

PART OF LOT __49 _ SECTION ___ TOWNSHIP __12 _ RANGE __7 _ OF THE:
__Holland Land Company's SURVEY - ___ Erie ___ COUNTY, N.Y.

THIS MAP VOID UNIESS
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SURVEY OF: 757 Hopkins Road, Town of Amherst SBL No. *56.46-1-3.2*

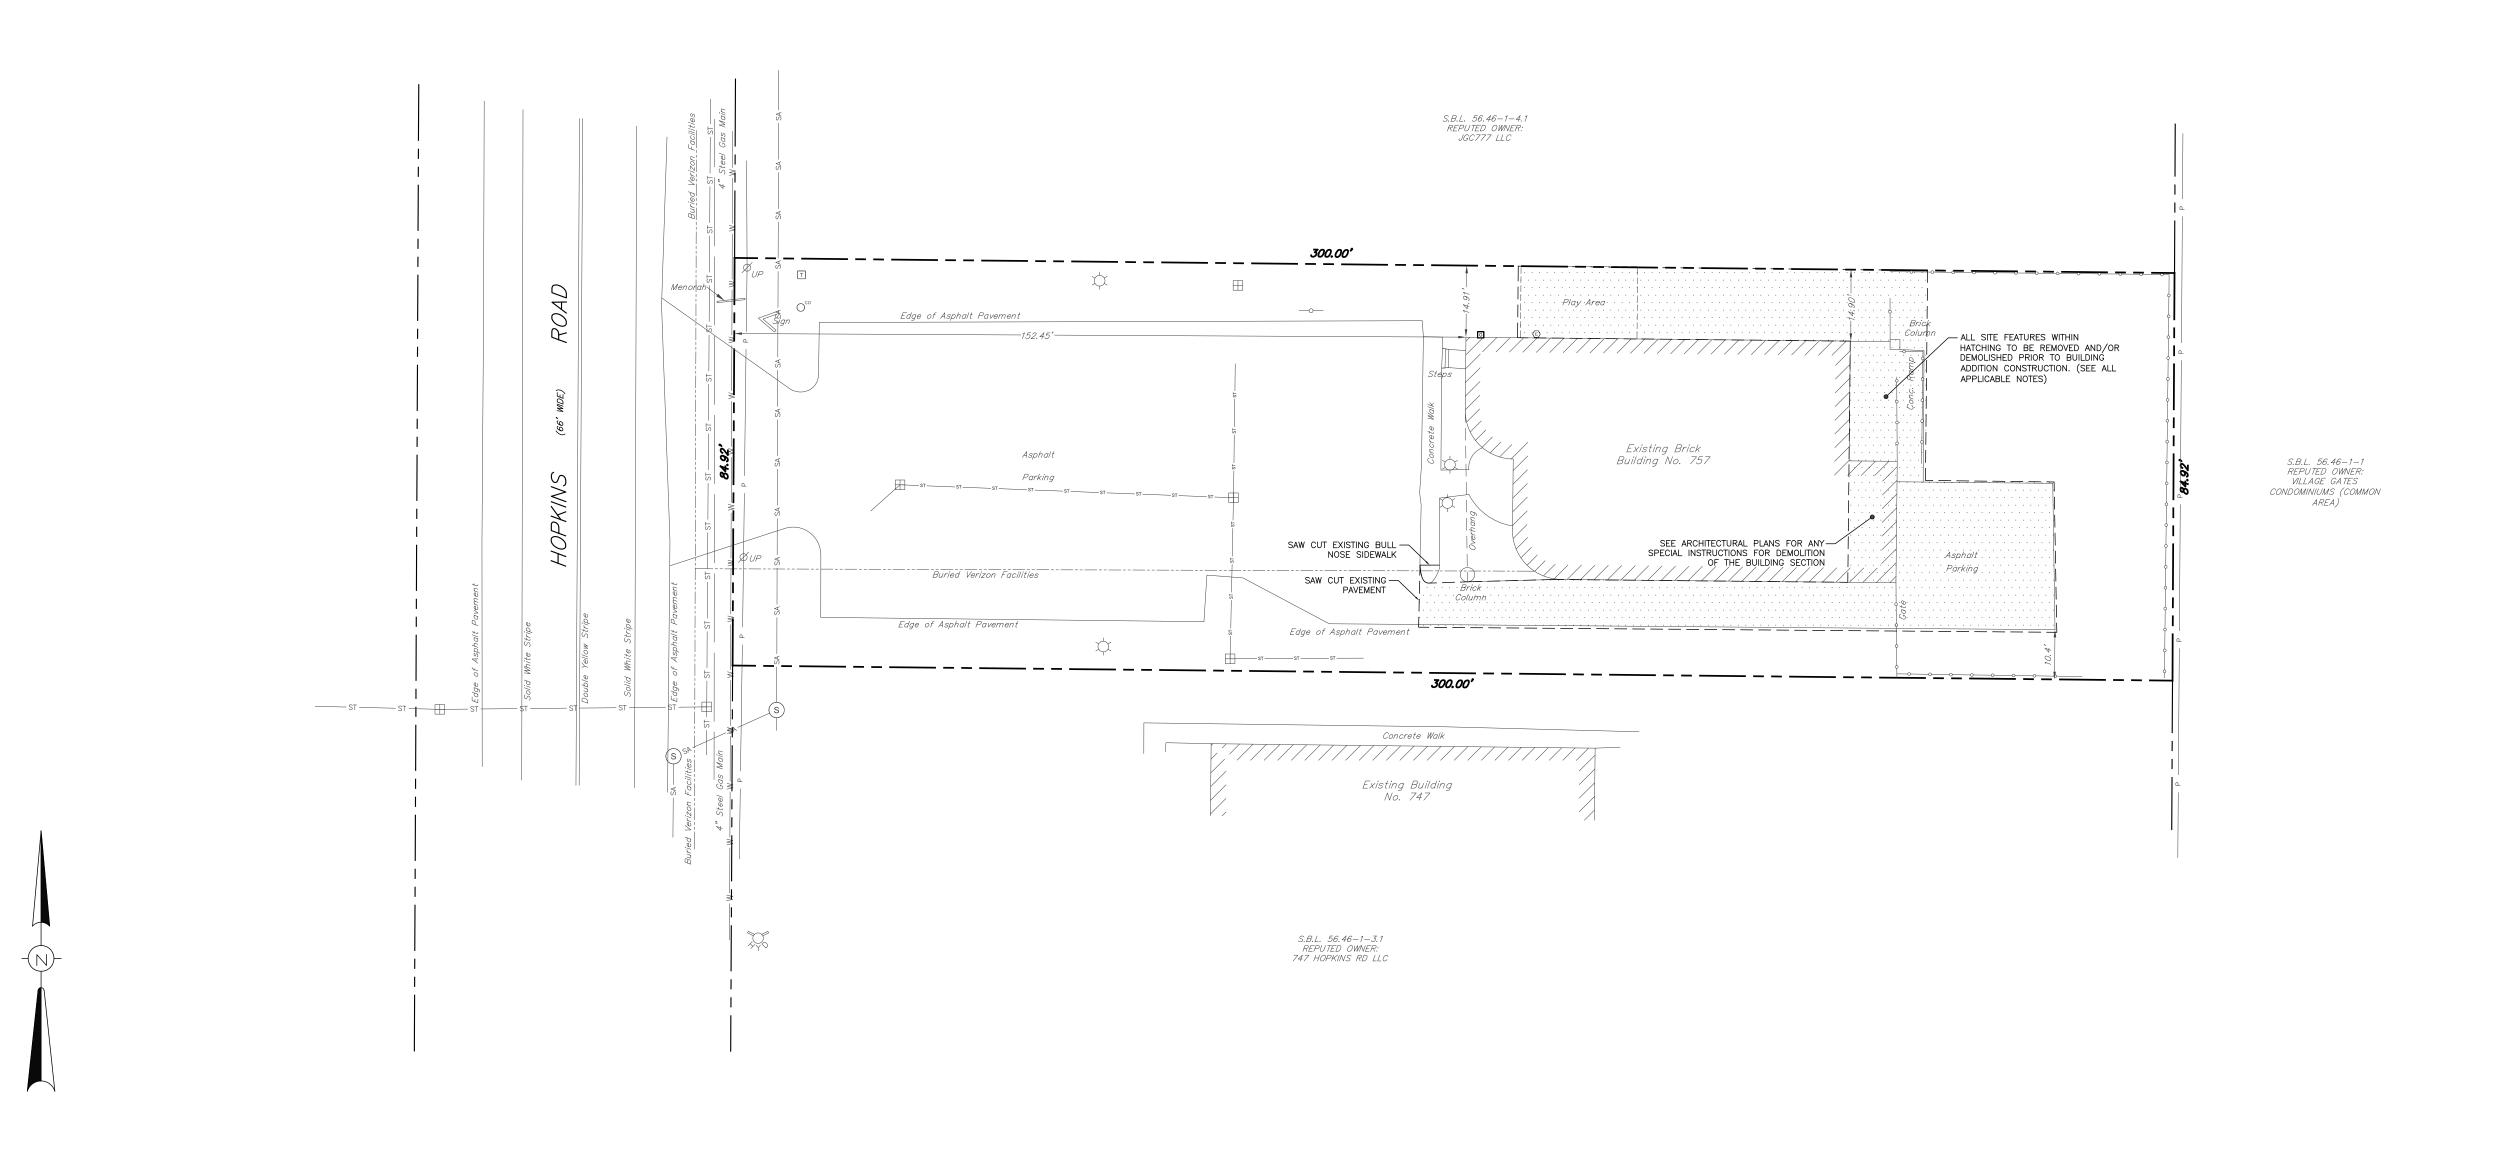

NOTES:

- 1. CONTRACTOR SHALL PROTECT ALL EXISTING STRUCTURES AND FEATURES TO REMAIN. THE CONTRACTOR SHALL BE RESPONSIBLE FOR ANY REPAIRS CAUSED BY DAMAGE TO EXISTING STRUCTURES DURING THE CONSTRUCTION PROCESS. ALL REPAIRS SHALL BE
- MADE AT THE CONTRACTOR'S EXPENSE. 2. CONTRACTOR SHALL REPAIR ANY DAMAGE TO EXISTING PAVEMENT SECTIONS THAT OCCUR DURING CONSTRUCTION.
- 3. ALL NECESSARY DEMOLITION PERMITS SHALL BE OBTAINED BY THE CONTRACTOR PRIOR TO ANY DEMOLITION WORK. 4. ALL VEGETATION AND TREES WITHIN THE LIMITS OF DISTURBANCE SHALL BE REMOVED
- UNLESS OTHERWISE NOTED. SEE LANDSCAPE PLAN FOR FURTHER DETAILS.

 5. DEMOLITION OF STRUCTURES AND DISPOSAL OF MATERIALS SHALL BE IN ACCORDANCE WITH ALL APPLICABLE TOWN AND STATE REGULATIONS. ANY FOUNDATIONS, INCLUDING BASEMENTS, ARE TO BE COMPLETELY REMOVED AND BACKFILLED WITH SUITABLE
- GRANULAR FILL. 6. EXISTING UTILITY SERVICE CONNECTIONS SHALL REMAIN IN PLACE TO SERVE THE BUILDING ADDITION.

NOTES:	ľ
1) THESE PLANS HAVE BEEN DEVELOPED FROM THE BOUNDARY AND TOPOGRAPHY SURVEYS	[
COMPLETED BY TRUE NORTH LAND SURVEYING, PLLC DATED FEBRUARY 18, 2025.	(
THIS IS NOT A PROPERTY SURVEY.	(

			METZGER CIVIL ENGIN
			8245 SHERIDAN DRIVE
			WILLIAMSVILLE, NY 14221
			PH: 716-633-2601
REVISIONS	DATE	BY/CHK	FAX: 716-633-2704
	REVISIONS		

METZGER

ENGINEERING, PLLC

CIVIL ENGINEERING

MUNICIPAL ENGINEERING

LAND PLANNING

SITE DESIGN

CENTER FOR JEWISH LIFE 757 HOPKINS ROAD TOWN OF AMHERST, ERIE COUNTY,

NEW YORK

MAY 16, 2025 DRAWING NO:

© 2025 METZGER CIVIL ENGINEERING, PLLC

DEMOLITION PLAN

SHEET 3

SITE DATA TABLE

ZONED: 0.58 ACRES PARCEL SIZE: MINIMUM LOT AREA: NONE MINIMUM LOT WIDTH: NONE

65' MAXIMUM BUILDING HEIGHT: PROPOSED BUILDING HEIGHT: <65' FRONT YARD SETBACK (FYSB) REQUIRED: 20.0' (FOR BLDG <35') FRONT YARD SETBACK (FYSB) EXISTING: 152.5'

FYSB TO CL HOPKINS ROAD REQUIRED: 90.0' FYSB TO CL HOPKINS ROAD EXISTING:

15.0' (FOR BLDG <30' ADJ. TO NONRES.) SIDE YARD SETBACK REQUIRED: SIDE YARD SETBACK PROVIDED: REAR YARD SETBACK REQUIRED: 30.0' (FOR BLDG <30' ADJ. TO RES.) 18.4'* REAR YARD SETBACK PROVIDED:

* VARIANCES WERE GRANTED BY THE TOWN OF AMHERST ZBA ON MARCH 19, 2024 FOR BOTH SIDE YARDS SETBACKS (5' TO NORTH AND O' TO SOUTH) AS WELL AS THE REAR YARD SETBACK (18')

<u>PARKING</u>:

AREA OF VEHICLE USE AREA: AREA OF INTERIOR GREENSPACE: MINIMUM INTERIOR GREENSPACE REQUIRED: INTERIOR GREENSPACE EXISTING:

VUA FRONT YARD SETBACK REQUIRED: VUA FRONT YARD SETBACK EXISTING: VUA SIDE YARD SETBACK REQUIRED: VUA SIDE YARD SETBACK EXISTING: VUA REAR YARD SETBACK REQUIRED: VUA REAR YARD SETBACK EXISTING:

COMMERCIAL SPACE: CALCULATED NET FLOOR AREA: ADJUSTED NET FLOOR AREA: REQUIRED COMMERCIAL PARKING: TOTAL PARKING PROVIDED:


7,651 SF 453 SF 5.0% 5.9%

> 15.0' 17.7'

10.0' (ADJACENT TO NONRES.) 10.2

25.0' 157'± 11,490± SF

80% (MULTI-STORY, SINGLE TENANT) 9,192± SF 46 SPACES (1 PER 200 SF) 22 SPACES

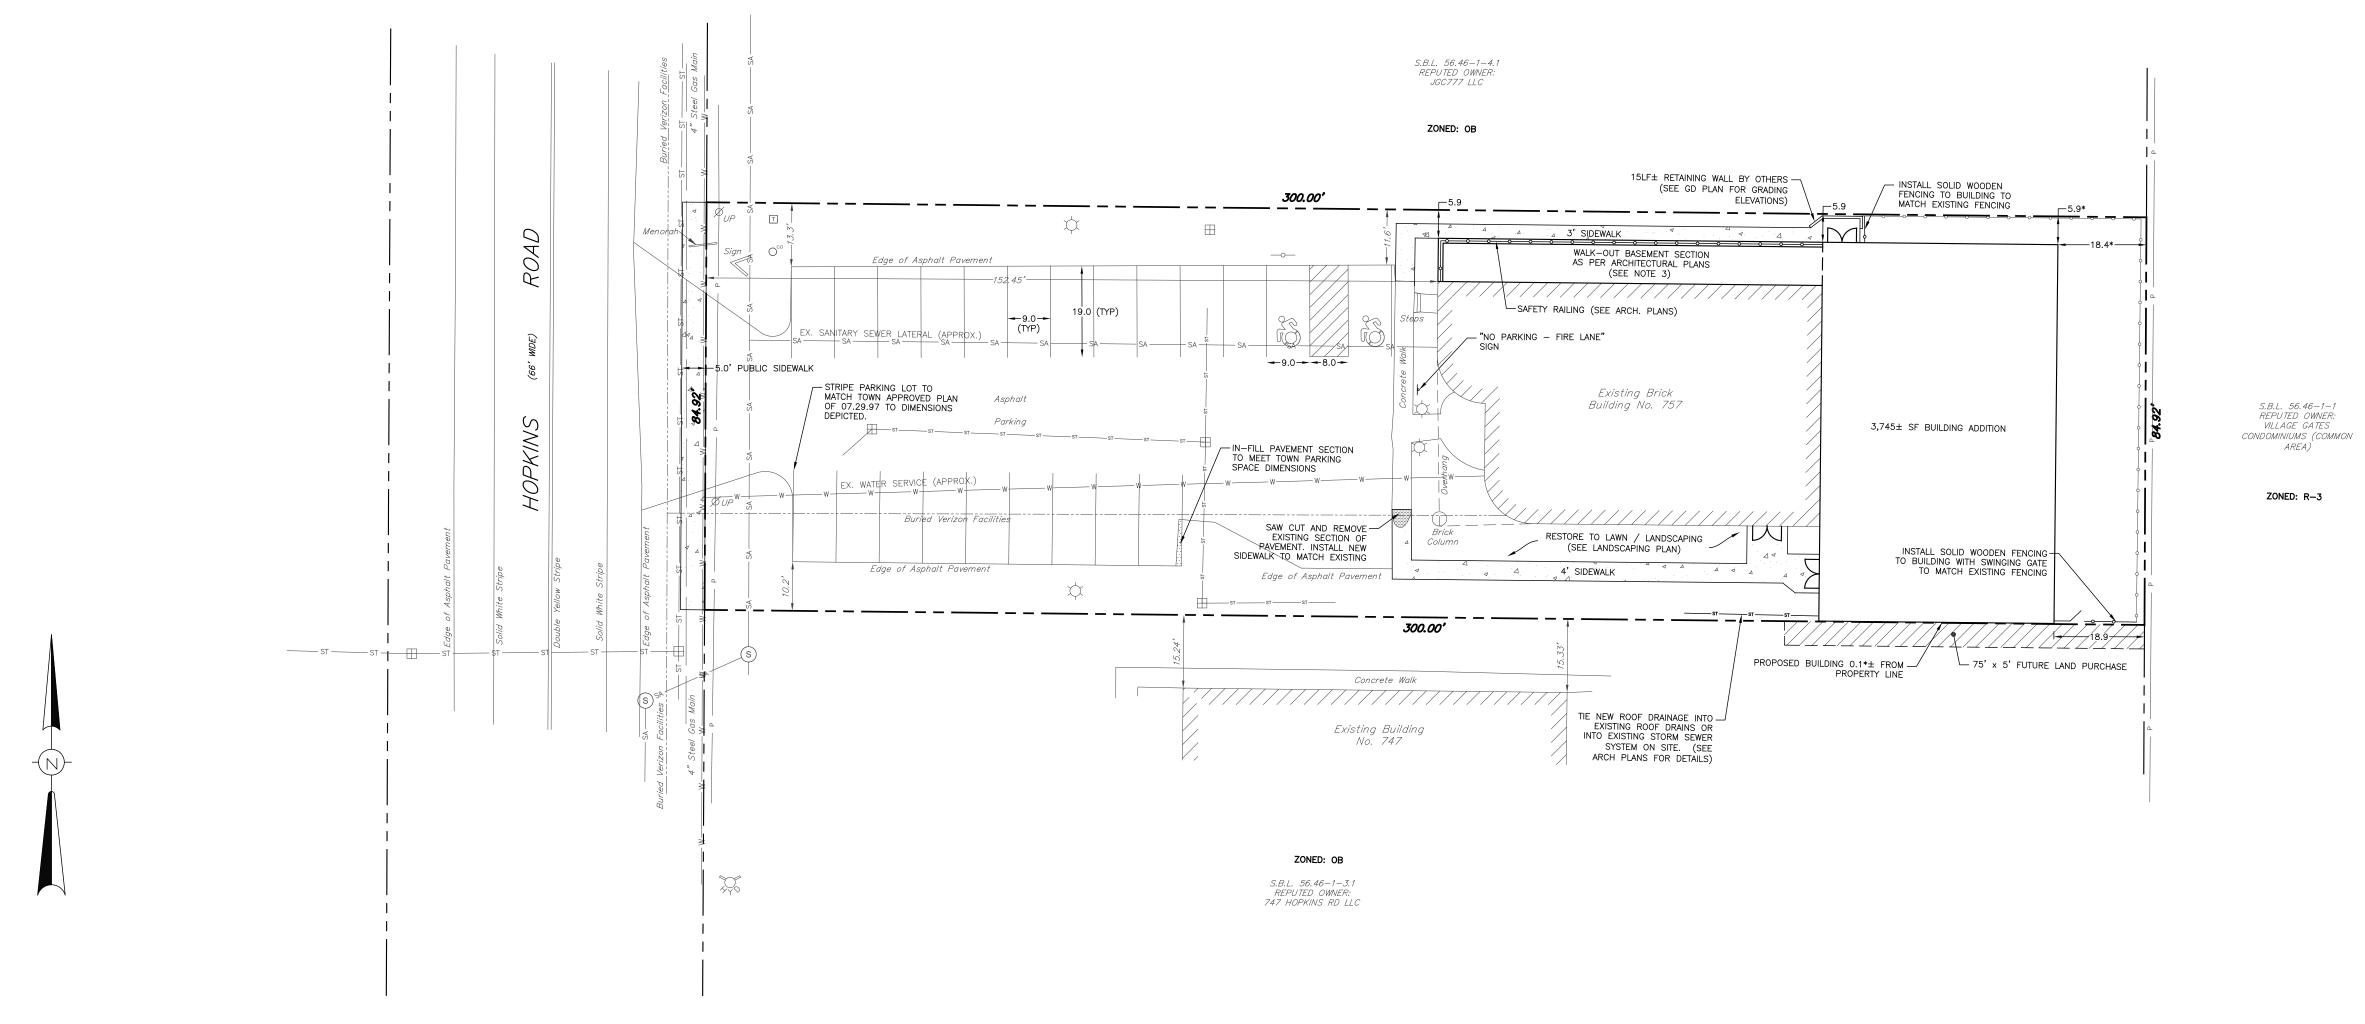

NOTES:

1. NO NEW WATER SERVICE OR SANITARY SEWER UTILITIES ARE PROPOSED FOR THE BUILDING ADDITION. THE NEW ADDITION SHALL CONNECT TO THE EXISTING WATER AND SANITARY SEWER SERVICES CURRENTLY IN PLACE SERVING THE EXISTING BUILDING INTERNALLY. REFER TO THE BUILDING PLANS FOR DETAILS. THE EXISTING WATER AND SANITARY SEWER SERVICES ARE DISPLAYED FOR ILLUSTRATION PURPOSES ONLY.

2. INSTALL ALL MATERIALS TO MANUFACTURER'S RECOMMENDATIONS AND BEST

STANDARDS OF TRADE INVOLVED.

3. SUBSTITUTIONS SHALL BE MADE ONLY WITH OWNER'S AND ENGINEER'S

APPROVAL AND BE OF EQUIVALENT QUALITY TO WHAT IS SPECIFIED. 4. WORK SHALL BE COMPLETED IN STRICT ACCORDANCE WITH ALL LOCAL CODES AND OSHA SAFETY RULES AND REGULATIONS.

5. VERIFY ALL EXISTING CONDITIONS AND DIMENSIONS AT THE SITE. NOTIFY OWNER & ENGINEER OF DISCREPANCIES IN CONDITIONS SHOWN ON DRAWINGS PRIOR TO PROCEEDING WITH THE WORK. ANNOTATED DIMENSIONS SHALL TAKE PRECEDENCE OVER SCALED DIMENSIONS.

6. CONTRACTOR SHALL KEEP JOB FREE OF DEBRIS AND MAKE FINAL CLEANUP TO SATISFACTION OF OWNER.

7. CONTRACTOR SHALL ASCERTAIN LOCATION OF ALL UTILITIES PRIOR TO CONSTRUCTION SO THAT THIS WORK WILL NOT DISTURB EXISTING LINES AND/OR INSTALLATIONS. COORDINATE ALL WORK WITH THE APPLICABLE UTILITY COMPANIES.

8. CONTRACTORS SHALL OBTAIN AND PAY FOR ALL REQUIRED PERMITS NECESSARY TO PERFORM THE WORK.

NOTES:	
1) THESE PLANS HAVE BEEN DEVELOPED FROM THE BOUNDARY AND TOPOGRAPHY SURVEYS	
COMPLETED BY TRUE NORTH LAND SURVEYING, PLLC DATED FEBRUARY 18, 2025.	
THIS IS NOT A PROPERTY SURVEY.	

DESIGNED BY: JCM CHECKED BY: JCM MJM				METZGER CIVIL ENGIN
CAD FILE: M2514 WOTF:				8245 SHERIDAN DRIVE
JNAUTHORIZED ALTERATION OR				WILLIAMSVILLE, NY 14221
ADDITION TO THIS DRAWING IS A HOLATION OF SECTION 7209,	TOWN COMMENTS	07.30.25	JCM	PH: 716-633-2601
PROVISION 2 OF THE NEW YORK STATE EDUCATION LAW	REVISIONS	DATE	BY/CHK	FAX: 716-633-2704
	_		<u> </u>	

ENGINEERING, PLLC

CIVIL ENGINEERING LAND PLANNING

MUNICIPAL ENGINEERING

SITE DESIGN

CENTER FOR JEWISH LIFE 757 HOPKINS ROAD TOWN OF AMHERST, ERIE COUNTY,


SITE PLAN

DRAWING NO: NEW YORK

SHEET 4

MAY 16, 2025

(C) 2025 METZGER CIVIL ENGINEERING, PLLC

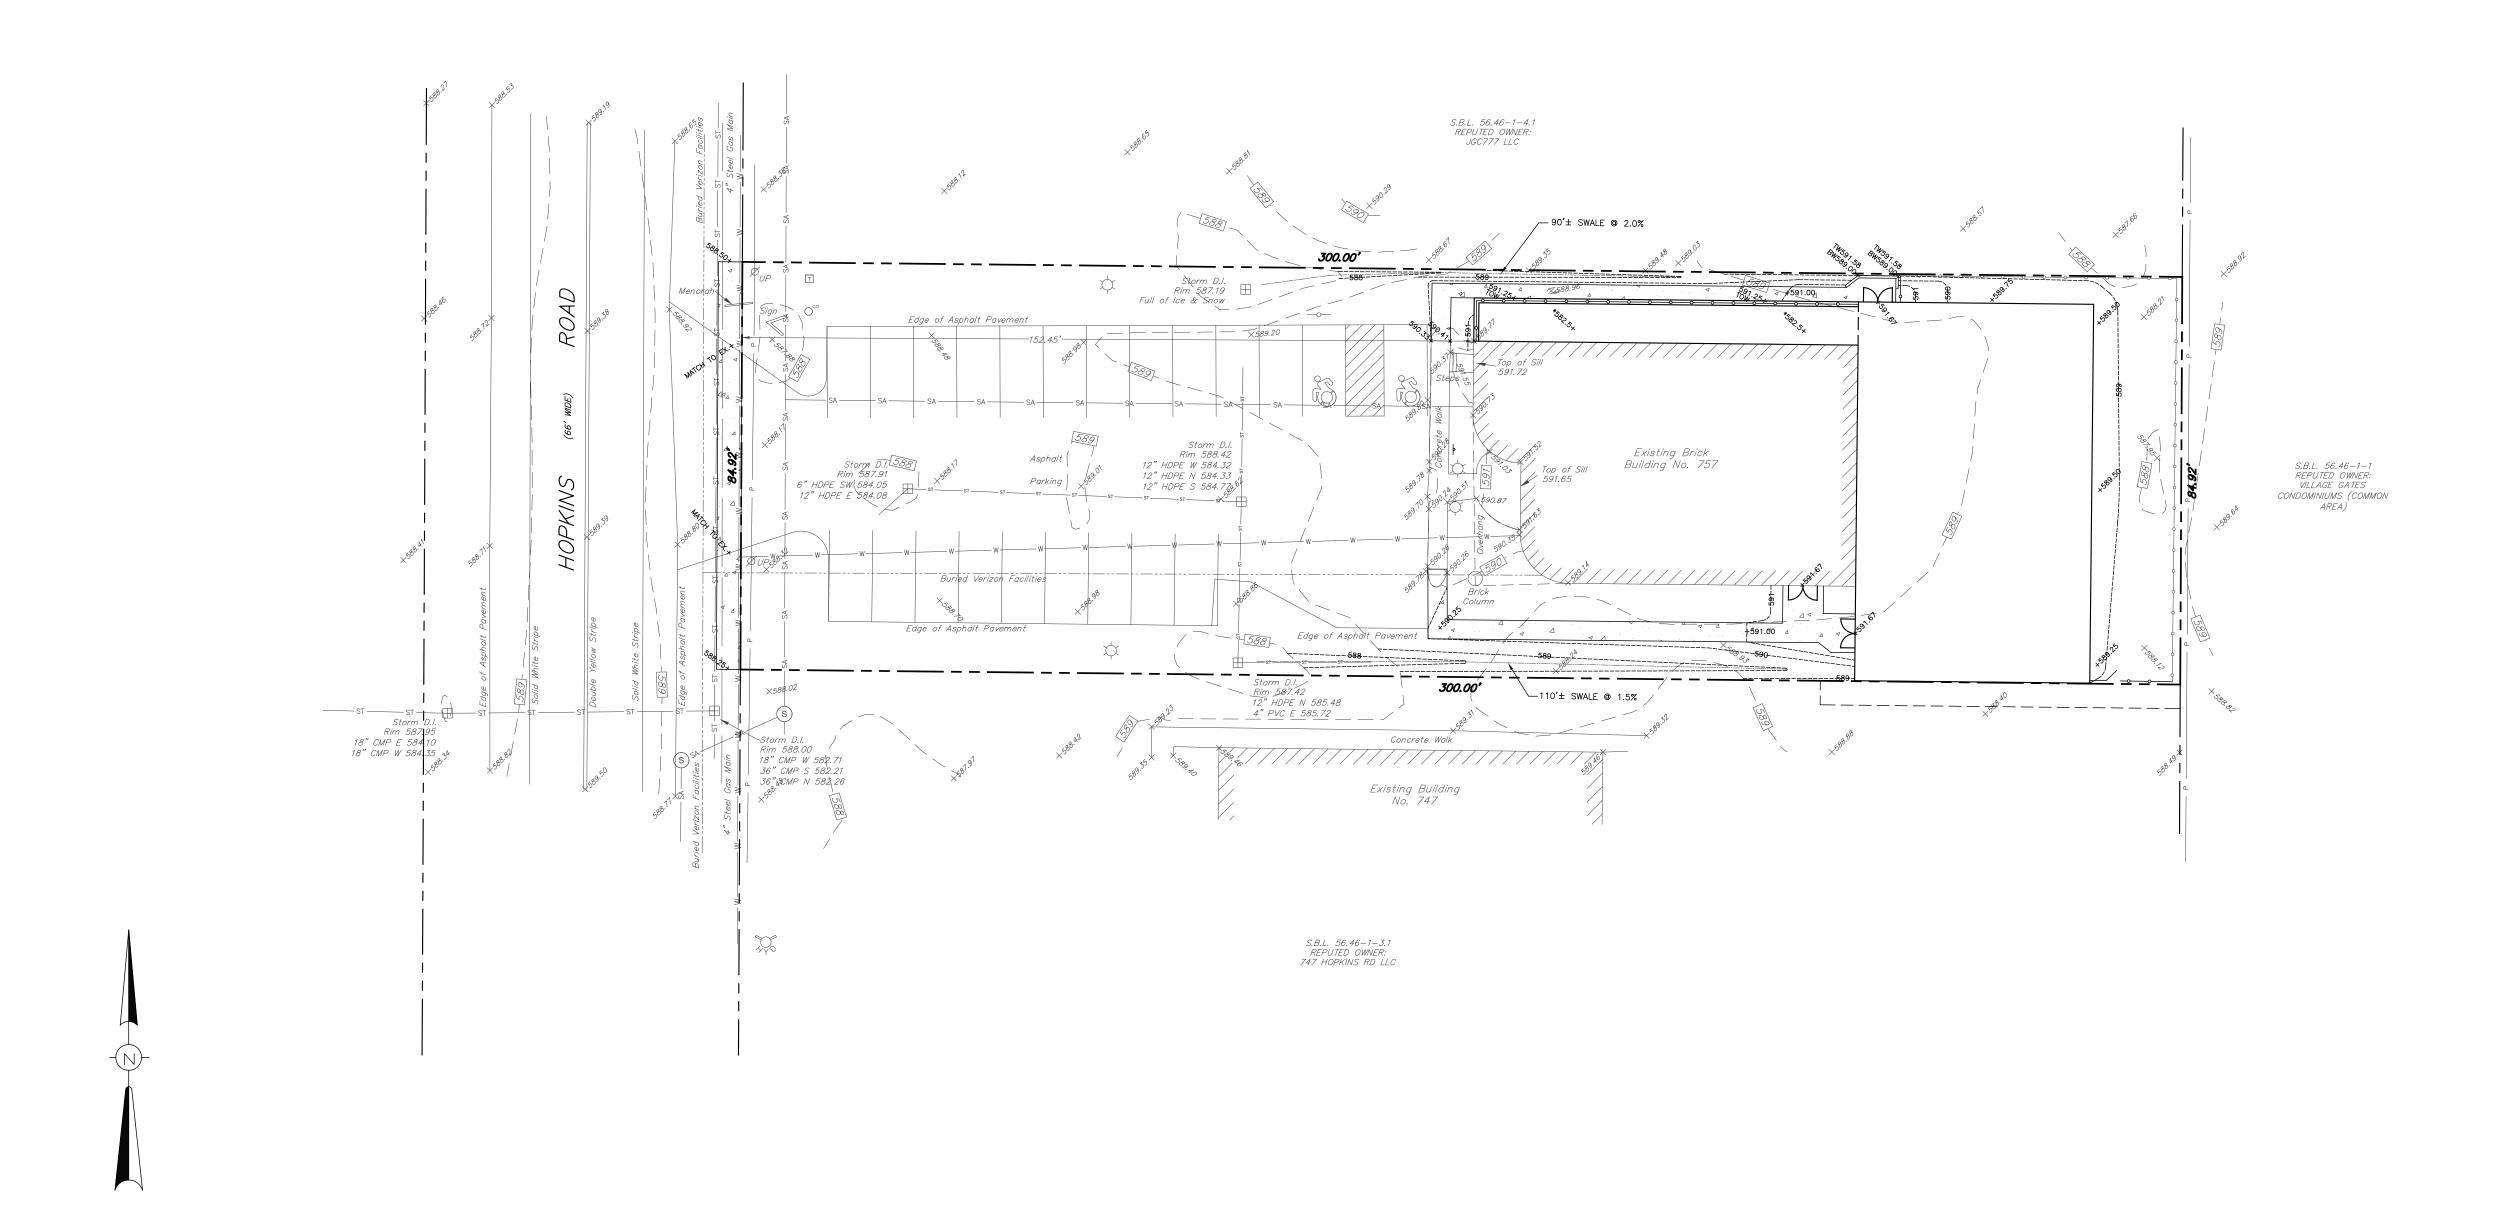

1. ALL ROOF LEADERS FOR THE BUILDING ADDITION SHALL BE TIED INTO THE EXISTING ROOF DRAINAGE SYSTEM; OR THE EXISTING CATCH BASINS; OR CONNECT TO THE STORM PIPING VIA INSERTA TEES.

2. PRIOR TO TOPSOILING AND SEEDING, ALL AREAS OF CUT OR FILL ARE TO "DE-COMPACTED" USING EQUIPMENT DRAWN IMPLEMENTS MAKING A NARROW SLIT OR A ROLLER WITH MANY SPIKES MAKING INDENTATIONS IN THE SOIL.

3. CONTRACTOR TO VERIFY WALKOUT BASEMENT ELEVATION, WHICH SHALL MATCH THE EXISTING

BASEMENT ELEVATION. 4. EXPOSED WALKOUT BASEMENT SHALL SLOPE TO THE CENTER OF THE AREA WITH A SUMP. SUMP SHALL BE EQUIPPED WITH A PUMP TO DISCHARGE ACCUMULATING STORMWATER INTO EXISTING STORM DRAINAGE SYSTEM. MANUFACTURER TO SPECIFY PUMP.

NOTES:
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THIS IS NOT A PROPERTY SURVEY.

DRAWN BY: CHECKED BY: MJM CAD FILE:				METZGER CIVIL ENGIN
M2514				8245 SHERIDAN DRIVE
NOTE: UNAUTHORIZED ALTERATION OR				WILLIAMSVILLE, NY 14221
ADDITION TO THIS DRAWING IS A VIOLATION OF SECTION 7209,	TOWN COMMENTS	07.30.25	JCM	PH: 716-633-2601
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MUNICIPAL ENGINEERING

METZGER

ENGINEERING, PLLC

CIVIL ENGINEERING

LAND PLANNING


SITE DESIGN

OF NE		
EL V. MC O	CENTER	FOR JEWISH
	757	HOPKINS ROA
P.	TOWN OF AMHERST,	ERIE COUNTY,

MAY 16, 2025 DRAWING NO: NEW YORK

GRADING & DRAINAGE PLAN

GD-1SHEET 5

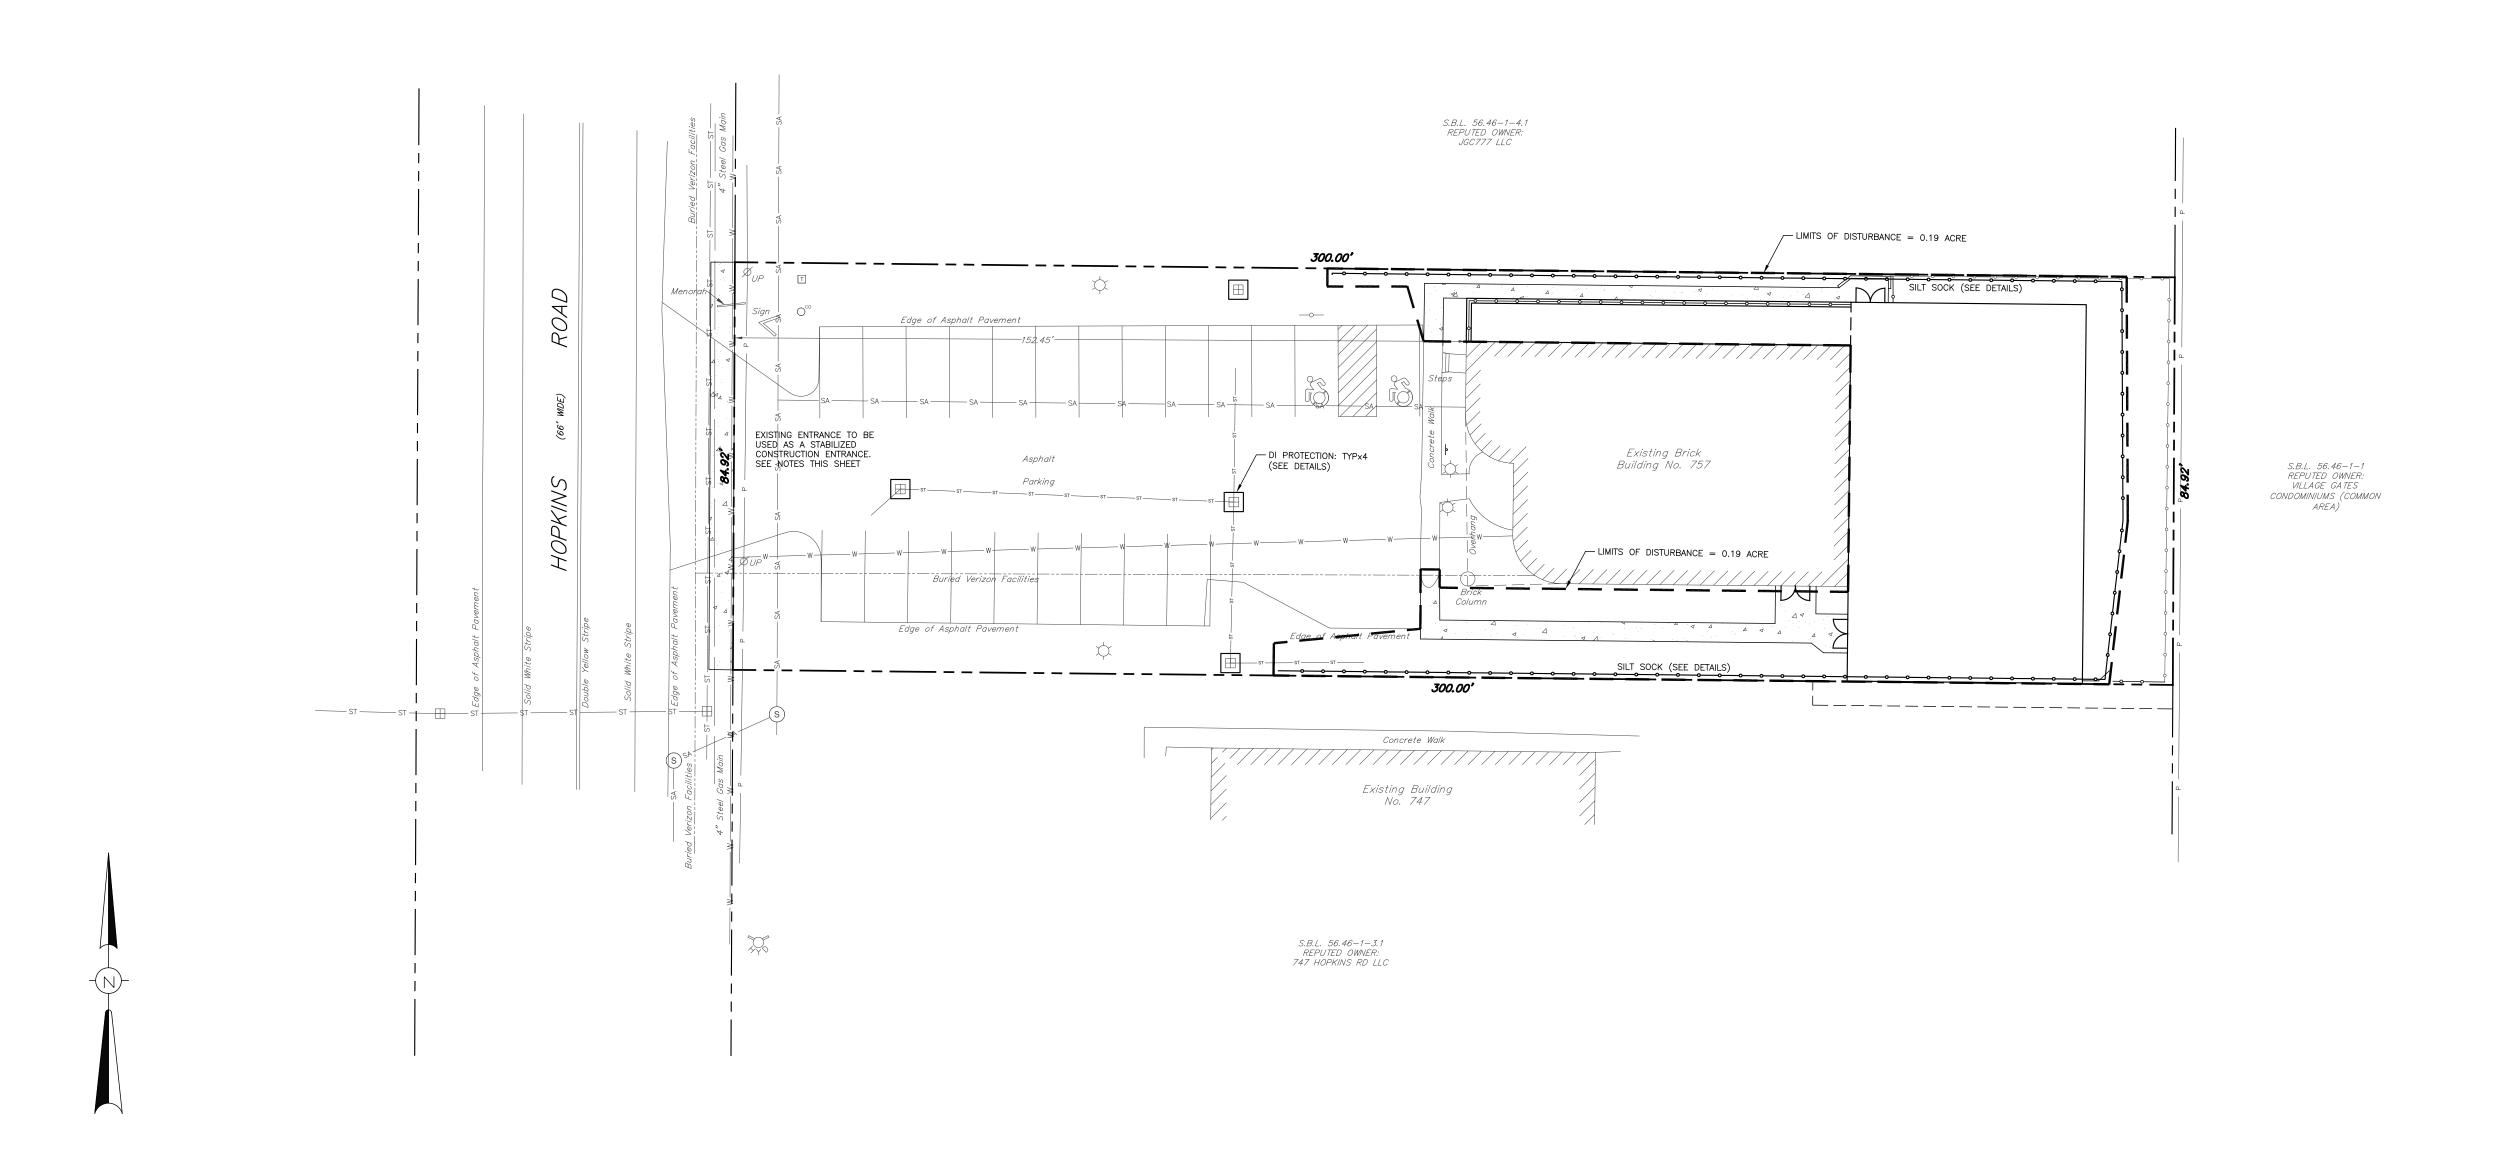

EROSION AND SEDIMENT CONTROL NOTES:

- 1. ALL DISTURBED AREAS AND SITE STOCKPILES ARE TO HAVE TEMPORARY
- VEGETATIVE COVER ESTABLISHED WITHIN 14 DAYS, IF IDLE.

 2. AFTER EACH RAINFALL EVENT OR WHENEVER WARRANTED, THE CONTRACTOR MUST INSPECT AND IF NECESSARY, REPAIR ALL EROSION CONTROL DEVICES.
- 3. THE CONTRACTOR SHALL USE ALL MEASURES APPROPRIATE TO LIMIT THE AMOUNT OF SEDIMENTS, DIRT AND MUD FROM TRACKING ONTO PUBLIC ROADWAYS. CONTINUOUS SWEEPING MAY BE NECESSARY.
- 4. AFTER "FINAL STABILIZATION" HAS BEEN ACHIEVED, INCLUDING THE ESTABLISHMENT OF COMPETENT VEGETATION, THE CONTRACTOR IS TO REMOVE ALL TEMPORARY EROSION AND SEDIMENT CONTROL DEVICES.

NOTES:
1) THESE PLANS HAVE BEEN DEVELOPED FROM THE BOUNDARY AND TOPOGRAPHY SURVEYS COMPLETED BY TRUE NORTH LAND SURVEYING, PLLC DATED FEBRUARY 18, 2025.
THIS IS NOT A PROPERTY SURVEY.

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DRAWN BY:	JCM				CIVIL
CHECKED BY:	MJM				FNGIN
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	ALTERATION OR				WILLIAMSVILLE, NY 14221
VIOLATION OF S		TOWN COMMENTS	07.30.25	JCM	PH: 716-633-2601
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NEW CONTROL OF NEW CO

ENGINEERING, PLLC

CIVIL ENGINEERING

MUNICIPAL ENGINEERING

LAND PLANNING

SITE DESIGN

	CENTER	FOR	JEWISH	LIFE
	757	HOPK	INS ROA	D
TOWN (OF AMHERST,	ER	NE COUNTY,	

SCALE: 1" = 20'

DATE: MAY 16, 2025

JOB NO: M2514

DRAWING NO:

EROSION & SEDIMENT CONTROL PLAN

ESC-1

SCREENING NOTE 2: Low Impact Screening. When the proposed development is considered to have a low impact on the existing 7-2-4 (4): Screening Adjacent to Residential Zoning. SCREENING NOTE 1 adjacent zoning according to the table in § 1-1-1B, one of the following methods for buffering and screening shall When adjacent to the following districts: R-R, S-A, R-1, R-2, R-3, CR-3A, TR-3, R-4, MFR-4A, MFR-5, be provided within the required minimum rear and side yards for the VUA's (for yard dimensions, refer to the MFR-6, MFR-7 PRD, PDD, PRD, or NCD, any building or structure in the MFR-6, MFR-7, OB, GB, NB, CS, CONIFER DECIDUOUS MS, SC,RD, ST, GI, AG, CF, R-R, S-A or RC districts must provide the following landscape buffering and Dimensional Standards for each zoning district). screening within the required side and/or rear yard(s): Buffering and screening may consist of one low impact landscape screen evenly distributed within the required An earthen berm with a minimum height of three (3) feet (measured at the top of a1:3± grade) or an yard area (refer to low impact screen table below). opaque wood or vinyl fence, brick, stone or ornamental concrete masonry unit wall with a minimum WANT TO SEE STANKING TO SE SE SE SE SE SE SE S height of 5 feet and the following plant materials: a minimum of one evergreen tree per each 10 linear feet of property line adjacent to single-family residential zoning, one small deciduous or ornamental tree per each 15 linear feet of property line adjacent to residential zoning and one large deciduous tree per each 40 linear feet of property line adjacent to single-family residential zoning. REINFORCED NEW RUBBER HOSE 1/2" I.D. _ DOUBLE STRAND #12 GAUGE GALV. ANNEALED TWISTED STEEL WIRE _ CEDAR STAKES - 3 PER TREE __ 3" SHREDDED BARK MULCH — MIN. 4" DEEP SAUCER S.B.L. 56.46-1-4.1 REPUTED OWNER: JGC777 LLC / FINISHED GRADE REMOVE BURLAP FROM TOP - HALF OF ROOT BALL SEE SCREENING NOTE 2 SOIL MIX: 3 PARTS TOPSOIL 1 PART PEAT MOSS, 1/3 PART - EXISTING 6"Ø FLOWERING CRABAPPLE MILORGANITE (DOOD) COMPACTED SUBGRADE PLANTING DETAIL Step 8 EXISTING TAXUS SEE SCREENING NOTE 1 EXISTING EUONYMOUS — Existing Brick Building No. 757 EXISTING MUGO PINE -/EXISTING 6' HIGH SOLID FENCING — 3" SHREDDED BARK MULCH - MIN. 4" DEEP SAUCER 300.00* —EXISTING 11"Ø FLOWERING PEAR FINISHED GRADE EXISTING 5"Ø
FLOWERING CRABAPPLE
EXISTING 11"Ø
FLOWERING PEAR 4-BM EXISTING 6"Ø FLOWERING PEAR <u> 5−HS</u> -REMOVE BURLAP FROM TOP HALF OF ROOT BALL SEE SCREENING NOTE 2 -SOIL MIX: 3 PARTS TOPSOIL Existing Building No. 747 1 PART PEAT MOSS OR COMPOST 1/3 PART MILORGANITE FERTILIZER - COMPACTED SUBGRADE SHRUB PLANTING DETAIL BALLED AND BURLAP S.B.L. 56.46—1—3.1 REPUTED OWNER: 747 HOPKINS RD LLC PLANT LIST KEY QTY BOTANICAL NAME COMMON NAME <u>SIZE</u> <u>NOTES</u> $2\frac{1}{2}$ " - 3" CAL B&B; GROWS TO 40' HIGH, 35' WIDE 2 ACER RUBRUM 'SUN VALLEY' SUN VALLEY RED MAPLE PRINCETON SENTRY MAINDENHAIR TREE $2\frac{1}{2}$ " - 3" CAL B&B; GROWS TO 65' HIGH, 25' WIDE 2 GINKO BILOBA 'PRINCETON SENTRY' ORNAMENTAL TREES 6 MALUS 'ADIRONDACK' ADIRONDACK CRABAPPLE $1\frac{3}{4}$ " - 2" CAL B&B; GROWS TO 18' HIGH, 10' WIDE 3 MALUS 'ROYAL RAINDROPS' ROYAL RAINDROPS CRABAPPLE $1\frac{3}{4}$ " - 2" CAL B&B; GROWS TO 20' HIGH, 15' WIDE SPRINTER BOXWOOD 10 BUXUS MICROPHYLLA 'BULTHOUSE' 24" HIGH NO. 3 CONT.; GROWS 3-4' TALL AND WIDE 32 DIERVILLA 'G2X88544' KODIAK ORANGE DIERVILLA 24" HIGH NO. 5 CONT.; GROWS 3-4' TALL AND WIDE 6 HEPTACODIUM MICONIOIDES 'SMNHMRP' TEMPLE OF BLOOM (TREE FORM) 36" HIGH NO. 5 CONT.; GROWS 6-10' TALL AND WIDE 25 HYDRANGEA SERRATE 'SMNHSDD' TUFF STUFF AH-HA HYDRANGEA 24" HIGH NO. 3 CONT.; GROWS 2-3' TALL AND WIDE 48 POTENTILLA FRUITICOSA 'GOLDFINGER' GOLDFINGER POTENTILLA 24" HIGH NO. 3 CONT.; GROWS TO 3' TALL AND 4' WIDE 10 SPIRAEA X BUMALDA 'GOLDFLAME' 24" HIGH GOLDFLAME SPIREA NO. 5 CONT.; GROWS 3-4' TALL AND WIDE <u>EVERGREEN TREES</u> TP 8 THUJA PLICATA 'GROVEPLI' SPRING GROVE WESTERN ARBORVITAE 5' HIGH MIN. B&B; FULL TO GROUND; GROWS TO 25' HIGH AND 12' WIDE 1. ALL PLANTING BEDS AND TREE SAUCERS SHALL RECEIVE A MINIMUM 3-INCH DEPTH OF DARK SHREDDED HARDWOOD BARK MULCH. 2. DURING CONSTRUCTION THE CONTRACTOR SHALL TAKE ALL REASONABLE MEASURES TO PROTECT EXISTING TREES WHICH ARE TO BE PRESERVED FROM ALL POSSIBLE TYPES OF ROOT, TRUNK, AND LIMB DAMAGE; INCLUDING BUT NOT LIMITED TO, RETAINING WALLS WHICH PREVENT FILLING ON TOP OF ROOTS OR EXCAVATING TREE ROOTS. **METZGER** CENTER FOR JEWISH LIFE 1) THESE PLANS HAVE BEEN DEVELOPED FROM THE BOUNDARY AND TOPOGRAPHY SURVEYS *CIVIL MAY 16, 2025 757 HOPKINS ROAD COMPLETED BY TRUE NORTH LAND SURVEYING, ENGINEERING, PLLC PLLC DATED FEBRUARY 18, 2025. DRAWING NO: NEW YORK TOWN OF AMHERST, ERIE COUNTY, THIS IS NOT A PROPERTY SURVEY. M2514 CIVIL ENGINEERING

UNAUTHORIZED ALTERATION OR

TOWN COMMENTS

ADDITION TO THIS DRAWING IS

VIOLATION OF SECTION 7209,

PROVISION 2 OF THE NEW YORK STATE EDUCATION LAW

8245 SHERIDAN DRIVE

PH: 716-633-2601

FAX: 716-633-2704

07.30.25 JCM

DATE BY/CHK

WILLIAMSVILLE, NY 14221

LAND PLANNING

MUNICIPAL ENGINEERING


SITE DESIGN

LP-1

SHEET 7


LANDSCAPE PLAN

(C) 2025 METZGER CIVIL ENGINEERING, PLLC

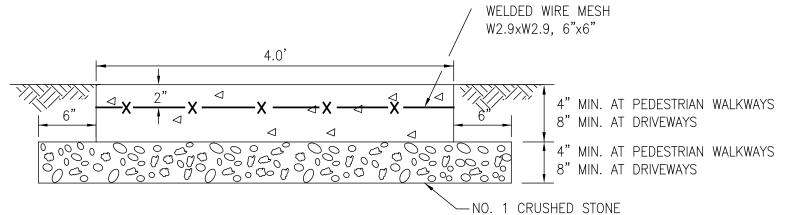



- 1. CONCRETE SHALL BE NYSDOT CLASS A, 3,500 PSI, AIR ENTRAINED, MAX. SLUMP 4"
- 2. WELDED WIRE MESH (WWM) SHALL BE W2.9xW2.9, 6"x6".
- 3. INSTALL TOOLED CONTROL JOINTS @ 4' INTERVALS. 4. INSTALL CONSTRUCTION JOINTS AT 20' SPACING MINIMUM.
- 5. PROVIDE LIGHT BROOM FINISH WITH $\frac{1}{4}$ " R. TOOLED EDGES. 6. ALL CONCRETE PLACED AS PART OF THIS CONTRACT SHALL BE SEALED AS SOON
- AS POSSIBLE AFTER INSTALLATION.

SIDEWALK DETAIL

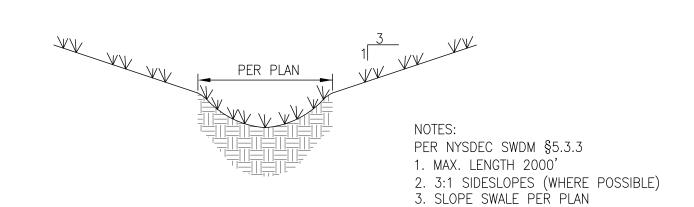

VEGETATIVE SWALE N.T.S.

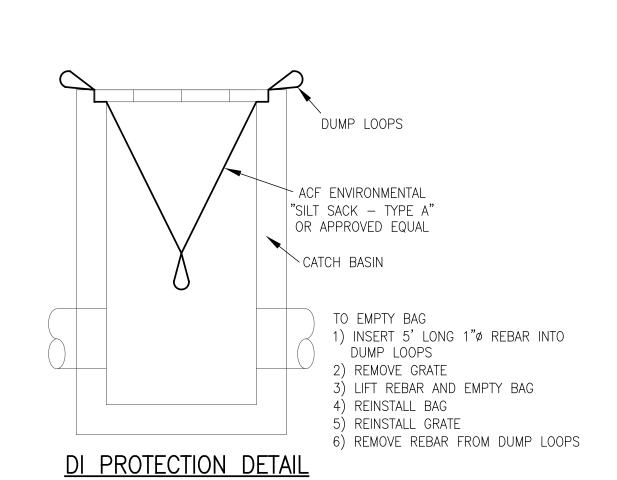

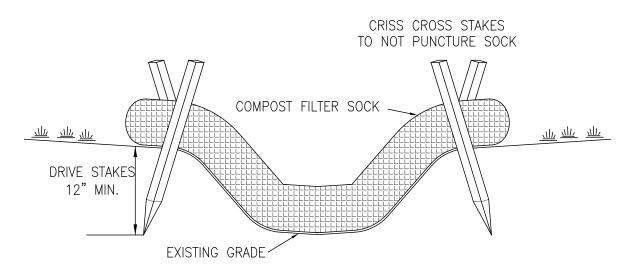

NOTES:


1. COMPOST FILTER SOCK MUST CONFORM TO NYS STANDARDS AND SPECIFICATIONS FOR EROSION AND SEDIMENT CONTROL (FILTREXX SILTSOXX OR APPROVED EQUAL). 2. INSTALL 3' LONG 2"x2" HARDWOOD STAKES AT 10' INTERVALS OR AS SPECIFIED BY THE SOCK MANUFACTURER.

3. WOODEN STAKES TO BE INSTALLED IN A CRISS CROSS PATTERN SO AS NOT TO PUNCTURE THE SOCK. 4. WOODEN STAKES TO BE DRIVEN AT LEAST 12" INTO GROUND.

5. ABUTTING ENDS MUST BE OVERLAPPED TO PROVIDE CONTINUOUS PROTECTION. 6. ALL SOCK SHALL BE 12".


MINIMUM	SOCK	SPACING
SLOPE %	12 S00	INCH CK
0-2% 2-5% 5-10%	250 225 125	,)

COMPOST FILTER SILT SOCK

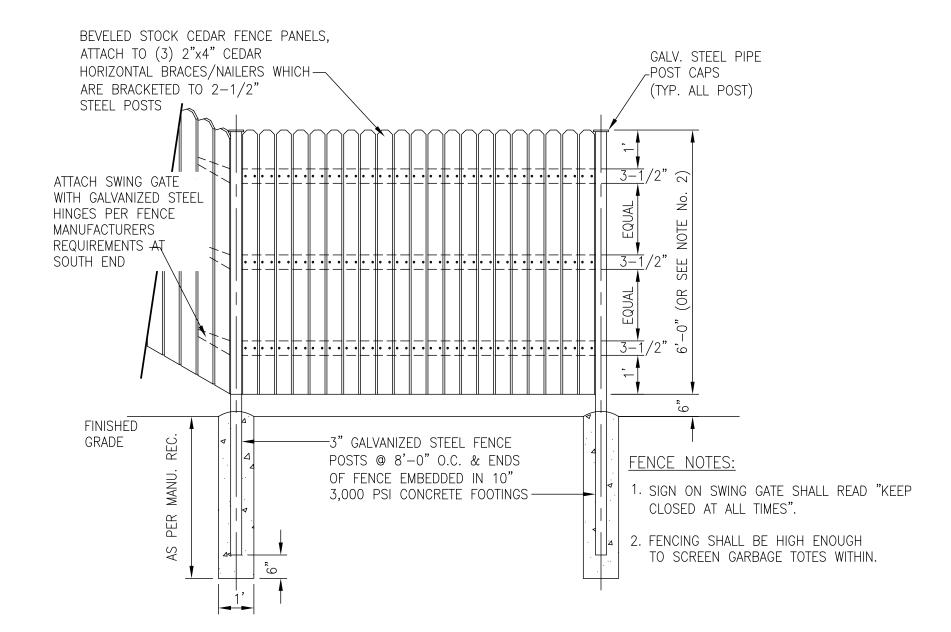


STOCKADE FENCE DETAIL

N.T.S.

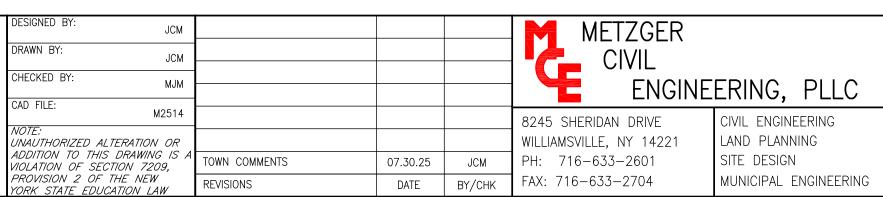

DATE BY/CHK

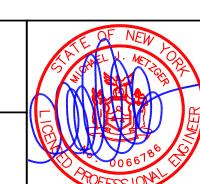

		CENTER	FOR	JEW	/ISH	LIFE
		757	HOPK	INS	ROA	D
TOW	/N OF	AMHERST,	ERIE COUNTY,			

SITE DETAILS

AS SHOWN MAY 16, 2025 DRAWING NO: NEW YORK

DT-1SHEET 8

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