


TOPOGRAPHIC SURVEY  
OF LOT 54, TOWNSHIP 13, RANGE 7  
HOLLAND LAND COMPANY'S SURVEY  
AMHERST, ERIE COUNTY, NEW YORK


OWN OF AMHERST, ERIE COUNTY, NEW YORK

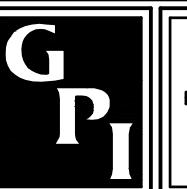

The logo consists of a rectangular frame with a double-line border. Inside, at the top, the company name "GPI ENGINEERING, LANDSCAPE ARCHITECTURE & SURVEYING, LLP" is written in a bold, black, serif font. Below the name, the services "ENGINEERING • SURVEYING • LANDSCAPE ARCHITECTURE" are listed in a smaller, bold, black, sans-serif font. At the bottom left, the phone number "(716) 633-4844" is displayed, and at the bottom right, the fax number "FAX 633-4940".

Job No. WNY-2300060.33 Date: JUNE 7, 2023  
Scale: 1" = 80' TAX No. 16.00-2-10

## Solar Development

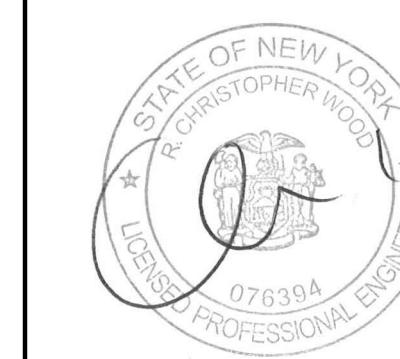1050 New Road  
Amherst, NY



DRAWING NAME:  
Demo & Erosion  
Control Plan

Date: 09/18/2023  
Drawn By: C. Wood  
Scale: As Noted

DRAWING NO.

C-001

Project No.: 23.4086

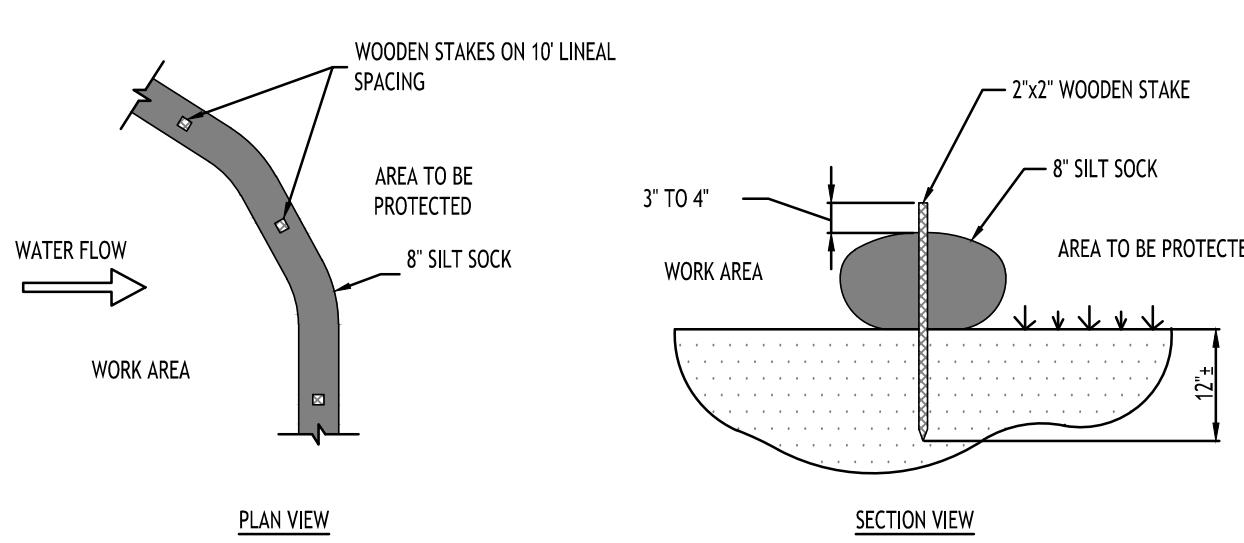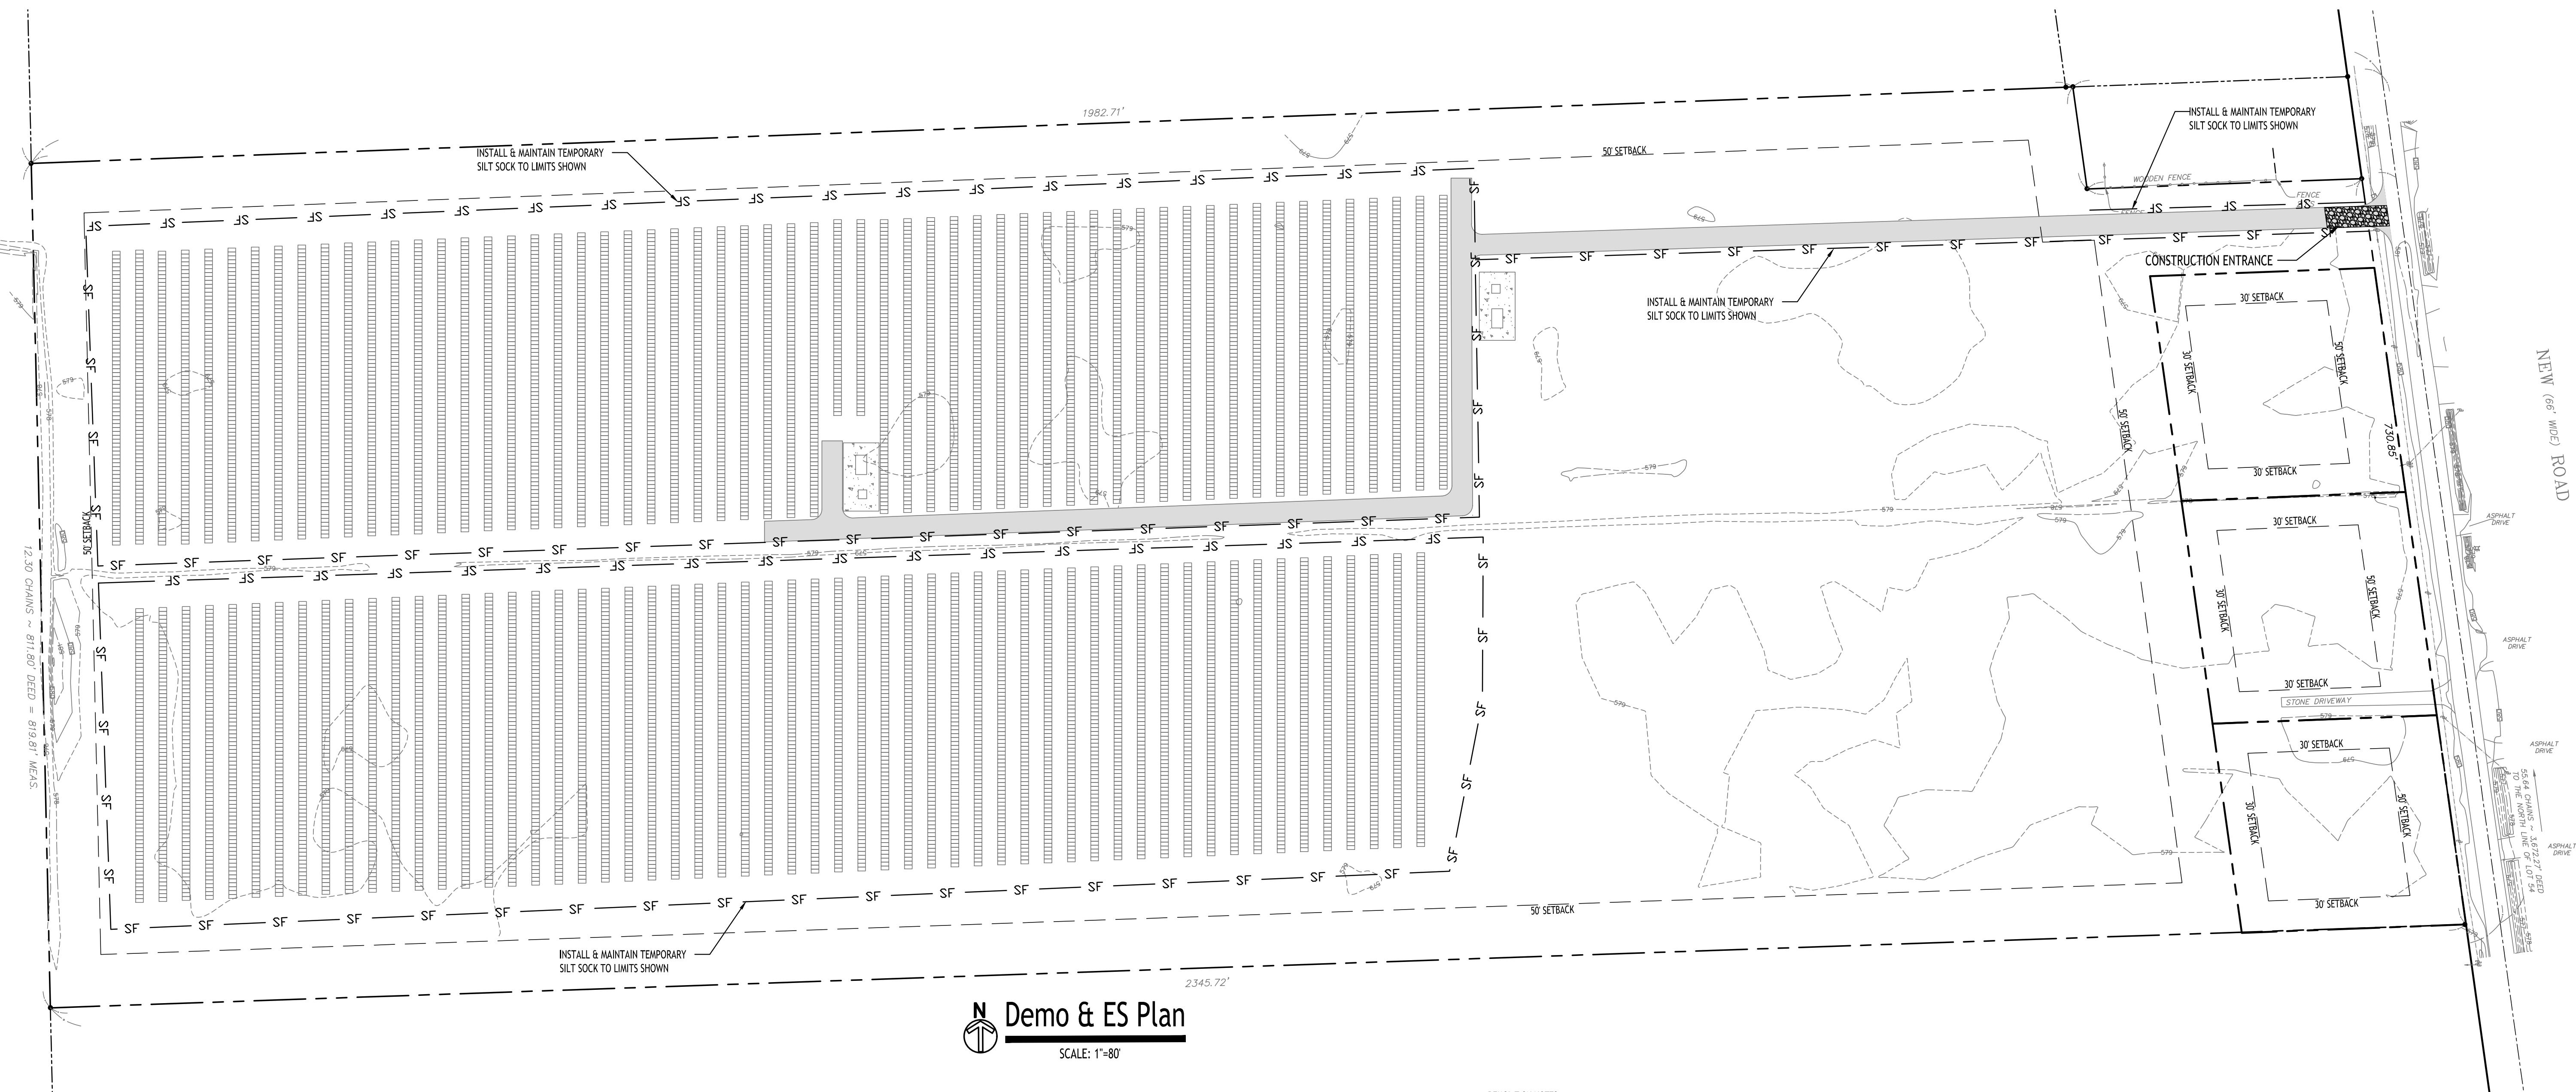

**NOTES:**  
CONTRACTOR SHALL INSPECT AND MAINTAIN SILT SOCK AS NEEDED DURING THE DURATION OF CONSTRUCTION PROJECT.

CONTRACTOR SHALL REMOVE SEDIMENT COLLECTED AT THE BASE OF THE SILT SOCK WHEN IT HAS REACHED 1/3 OF THE EXPOSED HEIGHT OF THE SILT SOCK. ALTERNATIVELY, RATHER THAN CREATE A SOIL DISTURBING ACTIVITY, THE ENGINEER MAY CALL FOR ADDITIONAL SILT SOCK TO BE ADDED AT AREAS OF HIGH SEDIMENTATION, PLACED IMMEDIATELY ON TOP OF THE EXISTING SEDIMENT-LADEN SILT SOCK.

**SILT SOCK DETAIL**

NOT TO SCALE

- CONSTRUCTION SPECIFICATIONS**
- STONE SIZE - USE 2" STONE, OR RECLAIMED OR RECYCLED CONCRETE EQUIVALENT.
  - LENGTH - NOT LESS THAN 50 FEET (EXCEPT ON A SINGLE RESIDENCE LOT WHERE A 30 FOOT MINIMUM LENGTH WOULD APPLY).
  - THICKNESS - NOT LESS THAN SIX (6) INCHES.
  - WIDTH - TWELVE (12) FOOT MINIMUM, BUT NOT LESS THAN THE FULL WIDTH AT POINTS WHERE INGRESS OR EGREG OCCURS. TWENTY-FOUR (24) FOOT IF SINGLE ENTRANCE TO SITE.
  - FILTER CLOTH - WILL BE PLACED OVER THE ENTIRE AREA PRIOR TO PLACING OF STONE.
  - SURFACE WATER - ALL SURFACE WATER FLOWING OR DIVERTED TOWARD CONSTRUCTION ENTRANCES SHALL BE PIPED ACROSS THE ENTRANCE. IF PIPING IS IMPRACTICAL, A MOUNTABLE BERM WITH 5:1 SLOPES WILL BE PERMITTED.
  - Maintenance - THE ENTRANCE SHALL BE MAINTAINED IN A CONDITION WHICH WILL PREVENT TRACKING OR FLOWING OF SEDIMENT INTO PUBLIC RIGHTS-OF-WAY. ALL SEDIMENT SPILLED, DROPPED, WASHED OR TRACTED INTO PUBLIC RIGHTS-OF-WAY MUST BE REMOVED IMMEDIATELY.
  - WHEN WASHING IS REQUIRED, IT SHALL BE DONE ON A AREA STABILIZED WITH STONE AND WHICH DRAINS INTO AN APPROVED SEDIMENT TRAPPING DEVICE.
  - PERIODIC INSPECTION AND NEEDED MAINTENANCE SHALL BE PROVIDED AFTER EACH RAIN.

**STABILIZED CONSTRUCTION ENTRANCE DETAIL**

NOT TO SCALE

- SEQUENCE OF CONSTRUCTION**
- OBTAINT ALL NECESSARY PERMITS PRIOR TO START OF CONSTRUCTION
  - INSTALL PERIMETER SILT SOCK IN THE LOCATIONS SHOWN ON THE DEMOLITION AND EROSION CONTROL PLAN SHEET.
  - CONSTRUCT TEMPORARY CONSTRUCTION EXIT AT LOCATION SHOWN ON THE DEMOLITION & EROSION CONTROL PLAN SHEET. CLEAR & GRUB SITE WITHIN PROPOSED LIMITS.
  - COMMENCE TOPSOIL STRIPPING & GRADING.
  - DISTURBED AREAS OF THE SITE WHERE CONSTRUCTION ACTIVITY HAS CEASED FOR MORE THAN 14 DAYS SHALL BE TEMPORARILY SEEDED AND WATERED.
  - REMOVE SILT SOCK AND INLET PROTECTION ONLY AFTER ALL EXPOSED SURFACES ARE STABILIZED.
- EROSION CONTROL NOTES**
- THE FOLLOWING EROSION CONTROL PROCEDURES SHALL BE ADHERED TO BY THE CONTRACTOR:
- INSTALL TEMPORARY SILT SOCK BARRIERS AS DIRECTED BY THE OWNER AND AT ALL EXISTING STORMWATER CATCH BASINS WITHIN THE WORK AREA TO PREVENT SEDIMENT MIGRATION. ALL SILT SOCK BARRIERS SHALL BE INSTALLED IN ACCORDANCE WITH THE DETAILS SHOWN ON THE PLANS.
  - TOPSOIL SHALL BE STRIPPED AND STOCKPILED ON SITE FOR RE-USE AS DIRECTED BY THE OWNER. ALL LOCAL ORDINANCES REGARDING THE SALE OF TOPSOIL MUST BE FOLLOWED. TOPSOIL MAY NOT BE REMOVED WITHOUT A PERMIT.
  - ALL SILT SOCK BARRIERS SHALL BE REPLACED WHEREVER THEY BECOME CLOGGED OR INOPERABLE.
  - THE CONTRACTOR SHALL BE RESPONSIBLE FOR MAINTENANCE AND REMOVAL OF TEMPORARY SEDIMENTATION CONTROLS.
  - THE CONTRACTOR MUST CONTROL DUST DURING CONSTRUCTION. DURING EARTHWORK OPERATIONS, WATER-SPRAYING EQUIPMENT SHALL BE PROVIDED BY THE CONTRACTOR, AND SPREAD WATER AS NECESSARY AND AS DIRECTED BY THE OWNER IN ORDER TO CONTROL DUST.
  - DIRT OR DEBRIS LEFT ON LOCAL PUBLIC ROADS AS A RESULT OF THIS CONSTRUCTION PROJECT SHALL BE REMOVED AND ROAD SURFACES CLEANED BY THE CONTRACTOR ON A DAILY BASIS.
  - ALL DISTURBED AREAS (EXCEPT AREAS TO BE PAVED OR BUILT UPON) SHALL BE TOPSOILED TO A MINIMUM 4" DEPTH AND SEDED IMMEDIATELY AFTER FINISH GRADE TAKES PLACE AND AS SOON AS PHYSICALLY POSSIBLE.
  - THE CONTRACTOR IS RESPONSIBLE FOR THE MAINTENANCE OF DOWNSTREAM STORM SEWERS, DITCHES, AND CULVERTS. SILT BUILDUP FOUND TO BE A RESULT OF THIS SITE CONSTRUCTION WORK SHALL BE REMOVED FROM DOWNSTREAM CULVERTS BY THE CONTRACTOR AT NO ADDITIONAL EXPENSE TO THE OWNER OR THE TOWN/CITY.
  - ALL SOIL EROSION AND SEDIMENT CONTROL DEVICES AND MATERIALS SHALL BE IN PLACE PRIOR TO BEGINNING EARTHWORK OPERATIONS AND SHALL BE MAINTAINED UNTIL THE NEW SLOPES ARE STABILIZED WITH SEEDING AND/OR SLOPE PROTECTION, AS DIRECTED BY THE ENGINEER.
  - INSTALL TEMPORARY SILT SOCK AROUND THE BASE OF STOCKPILES.
  - THE ENGINEER OF RECORD FOR THIS PROJECT CERTIFIES THAT THESE DESIGN PLANS MEET THE REQUIREMENTS AND ARE IN COMPLIANCE WITH THE NEW YORK STORMWATER MANAGEMENT DESIGN MANUAL AND NYSDC PHASE II STORMWATER REGULATION REQUIREMENTS.

**DEMOLITION NOTES:**

- CONTRACTOR SHALL TAKE PRECAUTIONS TO PROTECT THOSE ITEMS TO REMAIN, SUCH AS TREES, PROPERTY CORNER PINS, UTILITY POLES, VALVES, HYDRANTS, CURBS, MANHOLES OR CATCH BASINS.
- TEMPORARY SILT SOCK TO BE INSTALLED AS DIRECTED BY THE OWNERS FIELD REPRESENTATIVE. MAINTAIN UNTIL SITE IS STABILIZED.
- CONTRACTOR SHALL INSTALL STABILIZED CONSTRUCTION ENTRANCE WHERE ACCESSING THE SITE FROM PAVED ROADWAYS.
- AS NECESSARY, CONTRACTOR SHALL INSTALL TEMPORARY TRAFFIC CONTROL DEVICES IN ACCORDANCE WITH NYS M.U.T.C.D. STANDARDS PRIOR TO STARTING WORK.
- AS NECESSARY, COVERED DUMPSTERS SHALL BE PROVIDED ON-SITE AS REQUIRED FOR CONSTRUCTION WASTE.
- ANY VEGETATION WITHIN CONSTRUCTION LIMITS IS TO BE REMOVED.

**EROSION CONTROL NOTES**

THE FOLLOWING EROSION CONTROL PROCEDURES SHALL BE ADHERED TO BY THE CONTRACTOR:

- INSTALL TEMPORARY SILT SOCK BARRIERS AS DIRECTED BY THE OWNER AND AT ALL EXISTING STORMWATER CATCH BASINS WITHIN THE WORK AREA TO PREVENT SEDIMENT MIGRATION. ALL SILT SOCK BARRIERS SHALL BE INSTALLED IN ACCORDANCE WITH THE DETAILS SHOWN ON THE PLANS.
- TOPSOIL SHALL BE STRIPPED AND STOCKPILED ON SITE FOR RE-USE AS DIRECTED BY THE OWNER. ALL LOCAL ORDINANCES REGARDING THE SALE OF TOPSOIL MUST BE FOLLOWED. TOPSOIL MAY NOT BE REMOVED WITHOUT A PERMIT.
- ALL SILT SOCK BARRIERS SHALL BE REPLACED WHEREVER THEY BECOME CLOGGED OR INOPERABLE.
- THE CONTRACTOR SHALL BE RESPONSIBLE FOR MAINTENANCE AND REMOVAL OF TEMPORARY SEDIMENTATION CONTROLS.
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- DIRT OR DEBRIS LEFT ON LOCAL PUBLIC ROADS AS A RESULT OF THIS CONSTRUCTION PROJECT SHALL BE REMOVED AND ROAD SURFACES CLEANED BY THE CONTRACTOR ON A DAILY BASIS.
- ALL DISTURBED AREAS (EXCEPT AREAS TO BE PAVED OR BUILT UPON) SHALL BE TOPSOILED TO A MINIMUM 4" DEPTH AND SEDED IMMEDIATELY AFTER FINISH GRADE TAKES PLACE AND AS SOON AS PHYSICALLY POSSIBLE.
- THE CONTRACTOR IS RESPONSIBLE FOR THE MAINTENANCE OF DOWNSTREAM STORM SEWERS, DITCHES, AND CULVERTS. SILT BUILDUP FOUND TO BE A RESULT OF THIS SITE CONSTRUCTION WORK SHALL BE REMOVED FROM DOWNSTREAM CULVERTS BY THE CONTRACTOR AT NO ADDITIONAL EXPENSE TO THE OWNER OR THE TOWN/CITY.
- ALL SOIL EROSION AND SEDIMENT CONTROL DEVICES AND MATERIALS SHALL BE IN PLACE PRIOR TO BEGINNING EARTHWORK OPERATIONS AND SHALL BE MAINTAINED UNTIL THE NEW SLOPES ARE STABILIZED WITH SEEDING AND/OR SLOPE PROTECTION, AS DIRECTED BY THE ENGINEER.
- INSTALL TEMPORARY SILT SOCK AROUND THE BASE OF STOCKPILES.
- THE ENGINEER OF RECORD FOR THIS PROJECT CERTIFIES THAT THESE DESIGN PLANS MEET THE REQUIREMENTS AND ARE IN COMPLIANCE WITH THE NEW YORK STORMWATER MANAGEMENT DESIGN MANUAL AND NYSDC PHASE II STORMWATER REGULATION REQUIREMENTS.

NOTE: BOUNDARY AND TOPOGRAPHIC INFORMATION PROVIDED BY OTHERS,  
CARMINAWOOD DESIGN ASSUMES NO RESPONSIBILITY FOR ITS ACCURACY.

80 0 80 160ft.

**TOWN OF AMHERST APPROVAL BOX:**

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REVISIONS:  
No. Description Date

Date: 09/18/2023  
Drawn By: C. Wood  
Scale: As Noted

DRAWING NO.

C-001

Project No.: 23.4086

# CARMINA WOOD DESIGN

Buffalo | Utica | Greensboro

## Solar Development

1050 New Road  
Amherst, NY

REVISIONS:  
No. Description Date





DRAWING NAME:  
Site Plan

Date: 09/18/2023  
Drawn By: C. Wood  
Scale: As Noted

DRAWING NO.

**C-100**

Project No: 23.4086

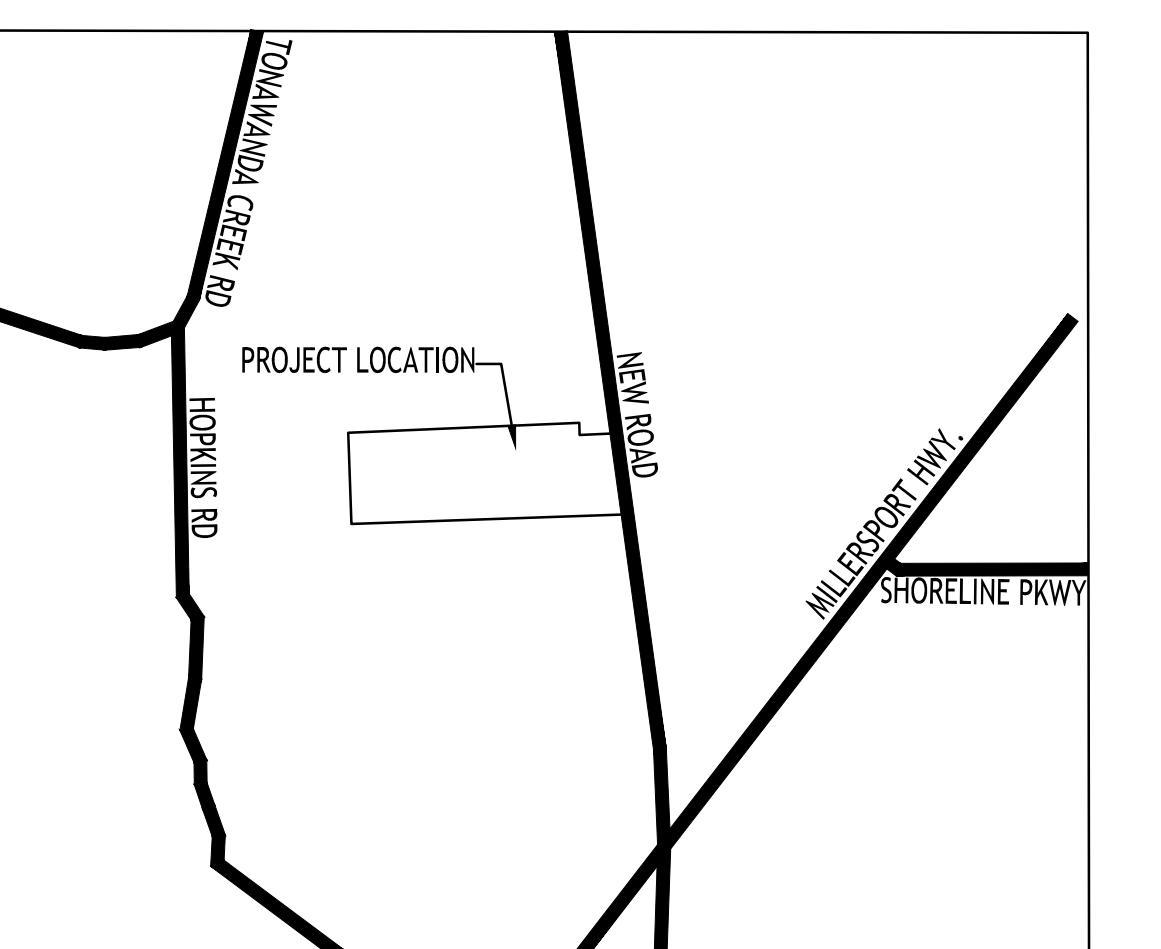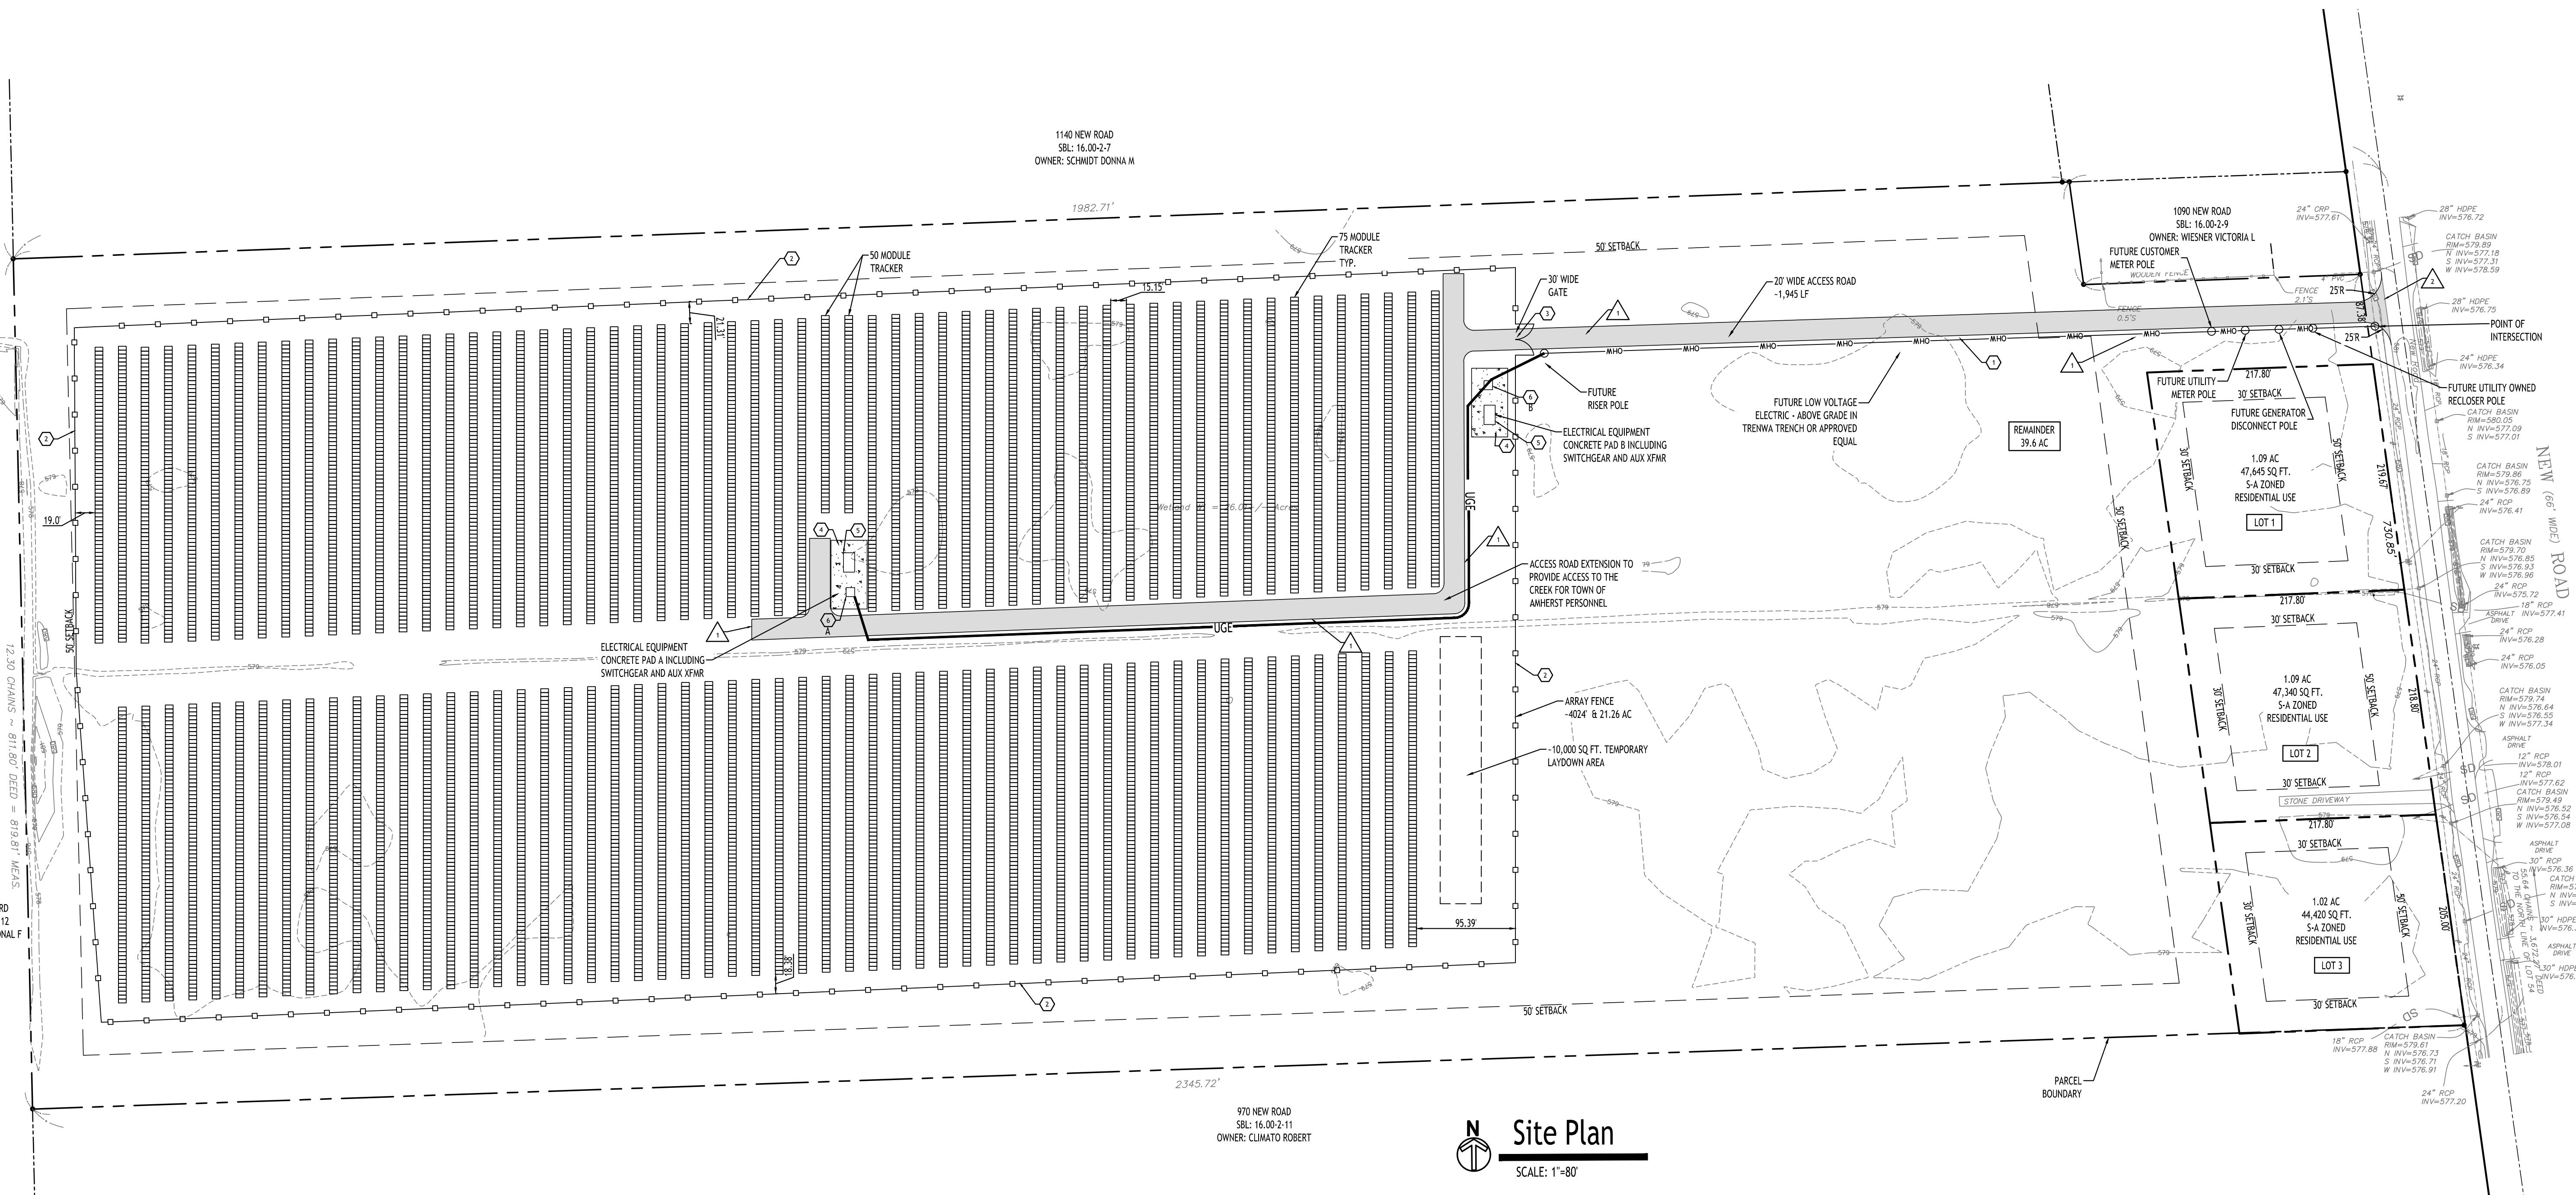

### SITE LEGEND

PROPERTY LINE



PROPOSED CONCRETE PAD



PROPOSED STONE ACCESS ROAD

NOTE: BOUNDARY AND TOPOGRAPHIC INFORMATION PROVIDED BY OTHERS,  
CARMINA WOOD DESIGN ASSUMES NO RESPONSIBILITY FOR ITS ACCURACY.



### DETAIL LEGEND

- SEE SITE DETAIL SHEET
- 1 STONE ACCESS ROAD
  - 2 7 CHAIN LINK FENCE TYP.
  - 3 7 CHAIN LINK GATE TYP.
  - 4 ELECTRICAL EQUIPMENT CONCRETE PAD
  - 5 SWITCHGEAR AND AUX XFM
  - 6 TRANSFORMER

### NOTE LEGEND

- 1 EDGE OF STONE
- 2 MATCH EX. ROADWAY


### TOWN OF AMHERST APPROVAL BOX:

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## Solar Development



1050 New Road  
Amherst, NYREVISIONS:  
No. Description Date

Sealed: 09/18/2023

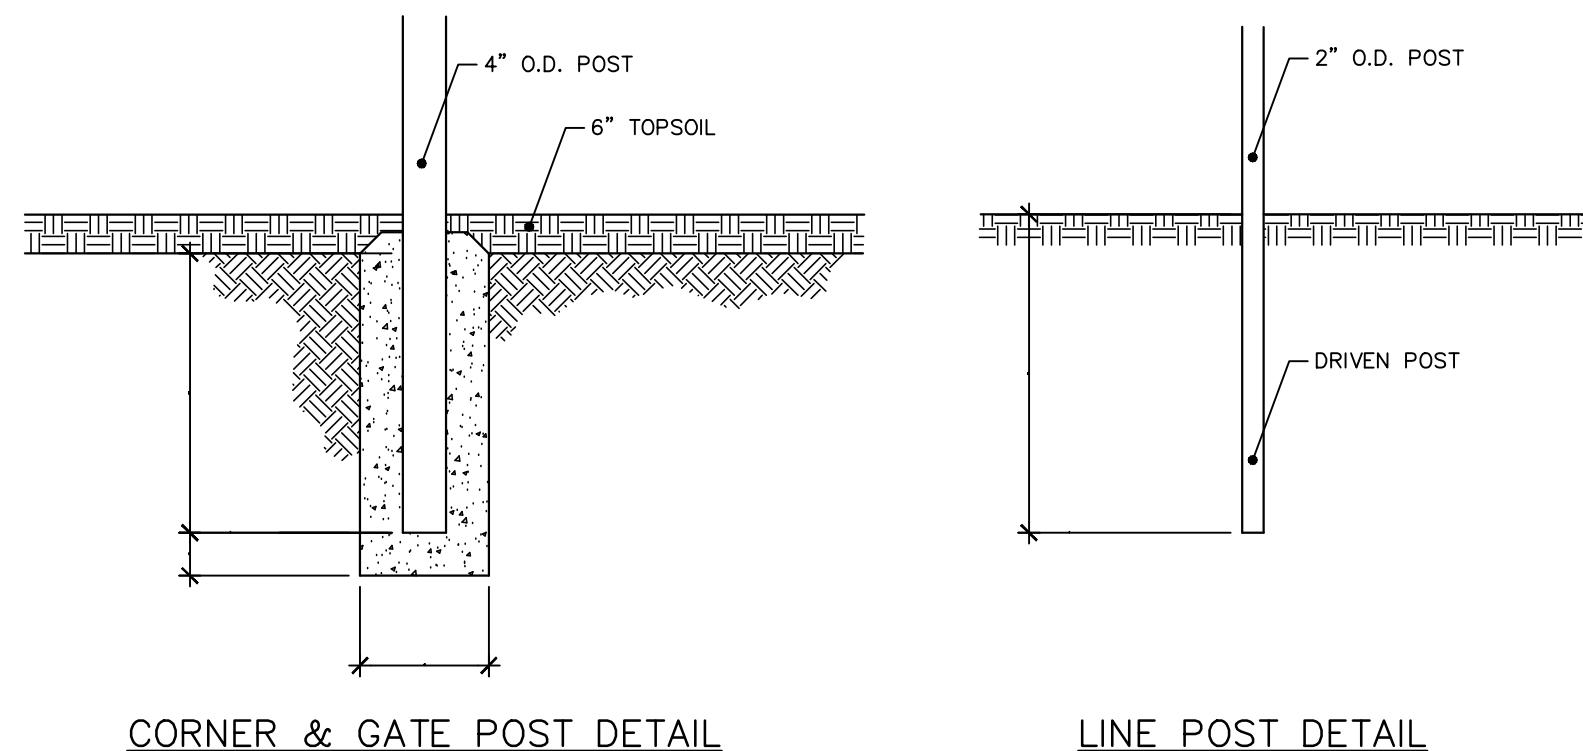

CORNER &amp; GATE POST DETAIL

LINE POST DETAIL

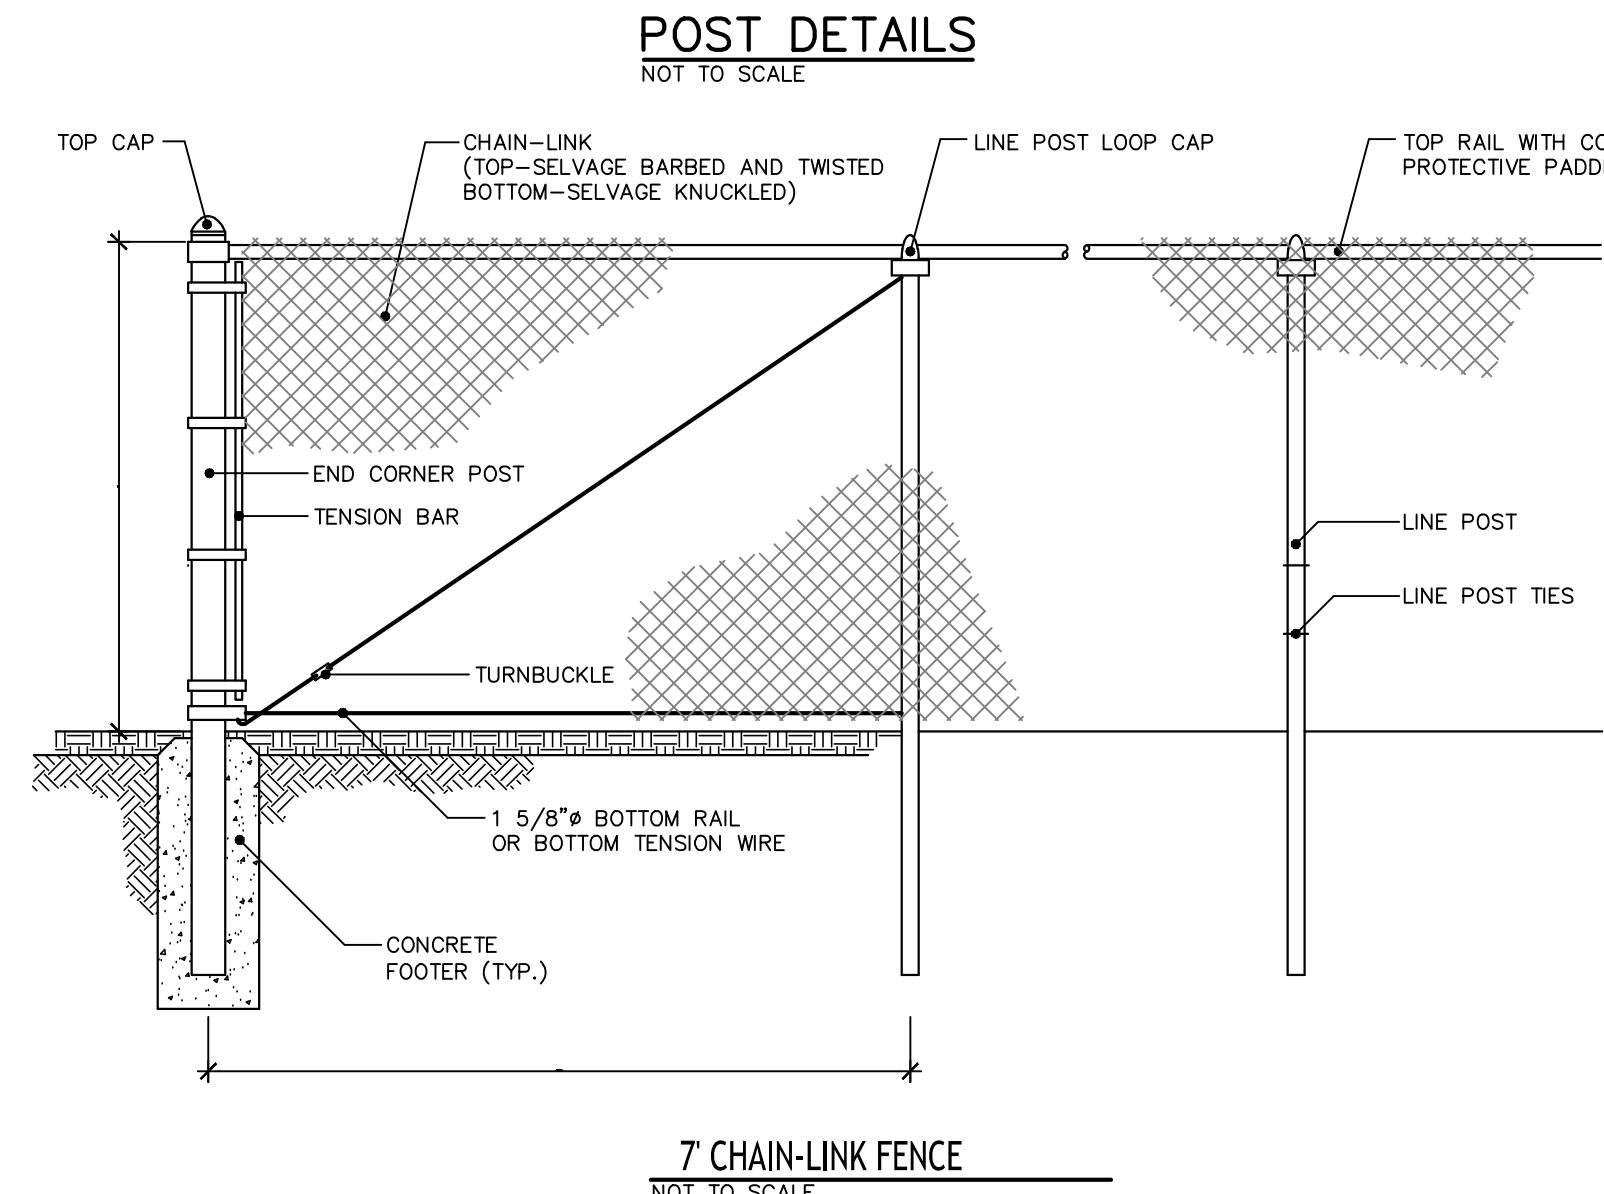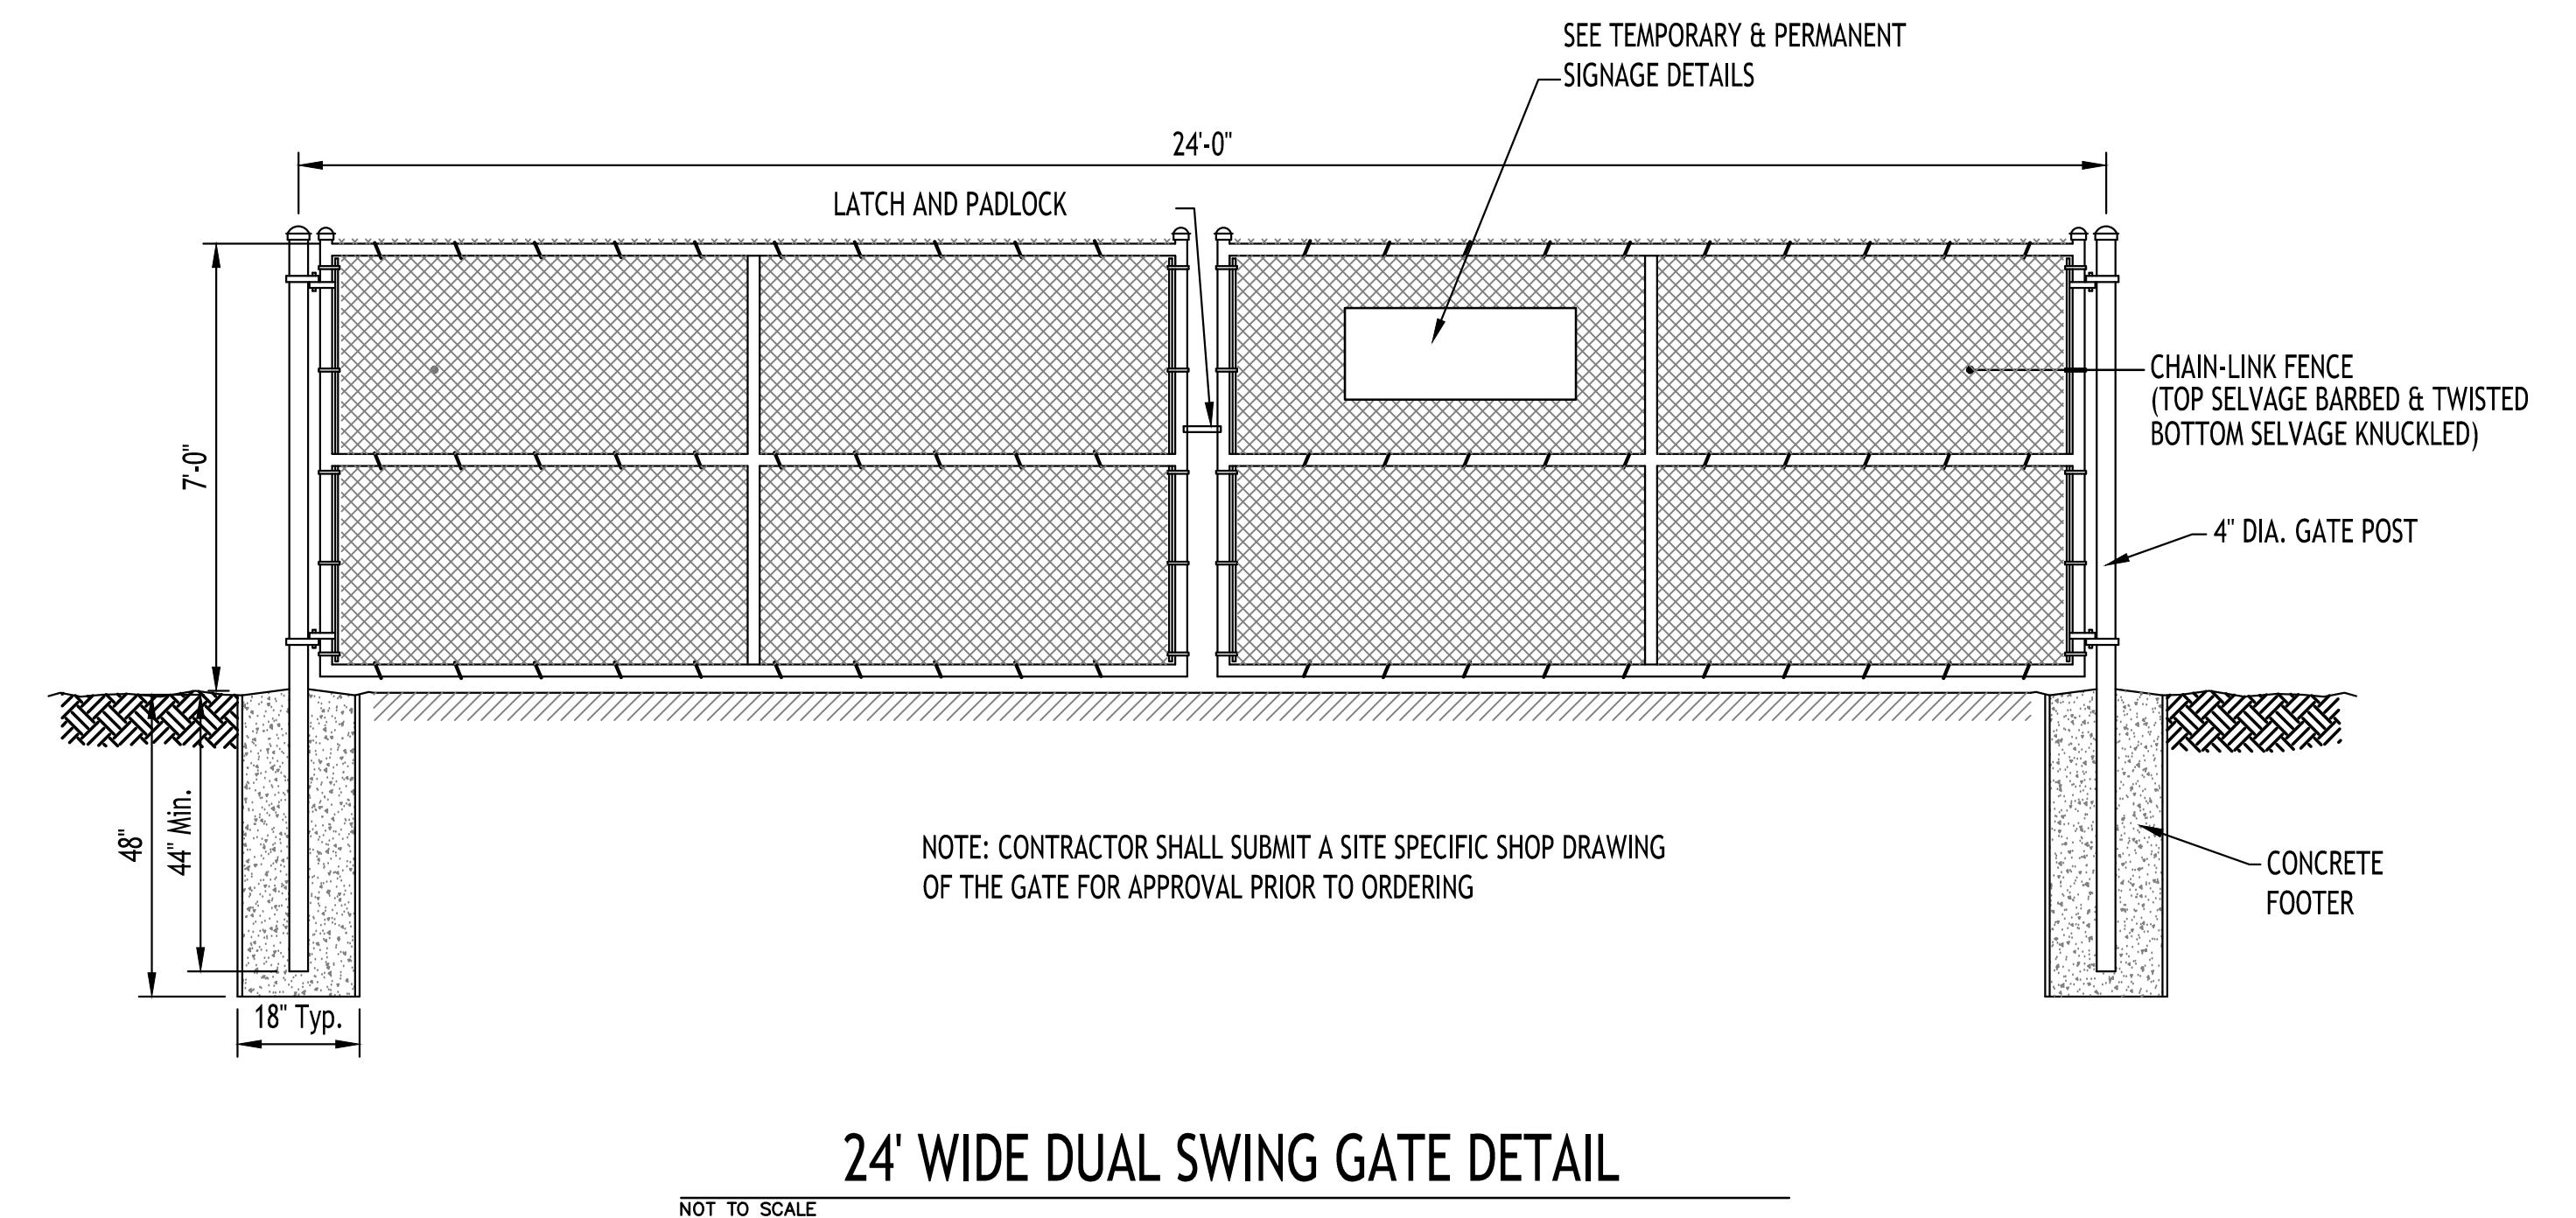7' CHAIN-LINK FENCE  
NOT TO SCALE

24' WIDE DUAL SWING GATE DETAIL

## NOTES:

1. TOPSOIL SHALL BE STRIPPED, VEGETATION/ROOTS REMOVED AND SUITABLE SUBGRADE PREPARED PRIOR TO INSTALLING THE STONE ROAD SECTION


2. AREAS ADJACENT TO THE STONE ACCESS ROAD SHALL BE GRADED AWAY. WATER SHALL NOT FLOW ACROSS THE ACCESS ROAD. IN AREAS WHERE THIS IS UNAVOIDABLE, A SWALE(S) SHALL BE INSTALLED ALONG THE EDGE OF THE ROAD TO DIVERT WATER.

3. STONE ACCESS ROAD IS INTENDED FOR INTERMITTENT USE FOLLOWING COMMISSIONING OF THE ARRAY FOR ROUTINE MAINTENANCE AND DURING CONSTRUCTION


4. FOLLOWING CONSTRUCTION, STONE ACCESS ROAD SHALL BE REPAVED WHERE REQUIRED. THIS INCLUDES ADDING ADDITIONAL CLEAN WEAR SURFACE MATERIAL

5. SUBGRADE SHALL BE PROOF ROLLED PRIOR TO INSTALLATION OF THE SECTION. UNACCEPTABLE SPOTS SHALL BE UNDERCUT, FILLED WITH SUBBASE MATERIAL AND COMPACTED PRIOR TO INSTALLING THE SECTION

6. ANY WEAR SURFACE OR CRUSHED STONE INFILL MATERIAL WHICH BECOMES CONTAMINATED WITH SILT OR MUD DURING CONSTRUCTION SHALL BE REMOVED AND REPLACED PRIOR TO COMMISSIONING

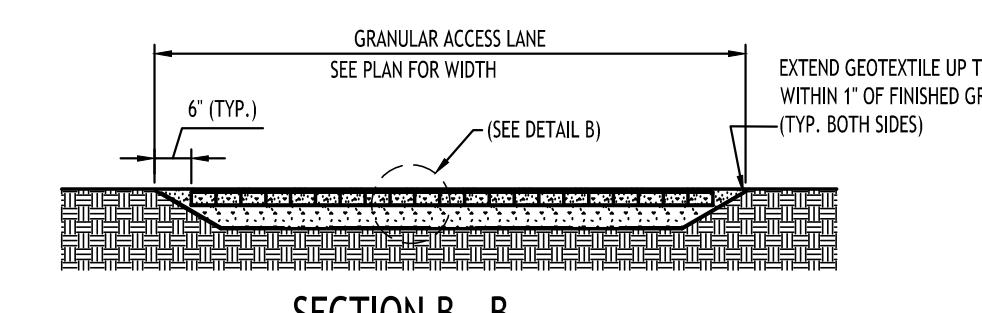

SECTION B - B

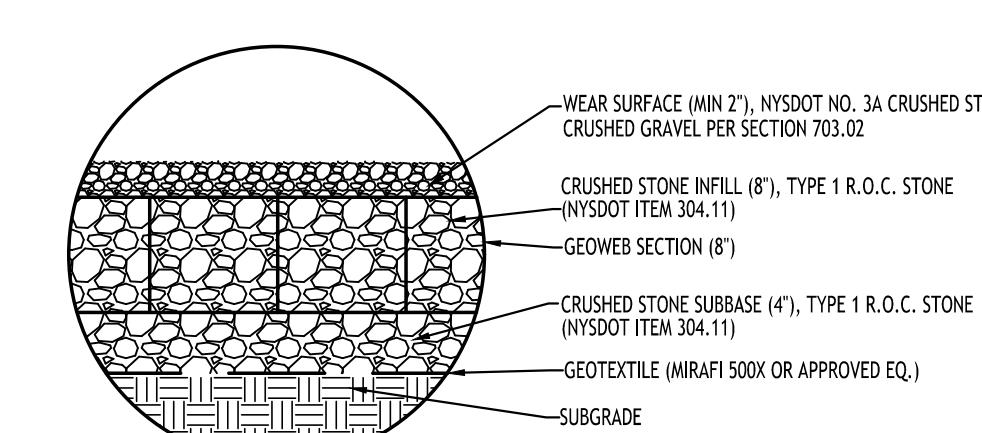

DETAIL B

STONE ACCESS ROAD

MANUFACTURER:  
PRESTO PRODUCTS CO.  
670 NORTH PERKINS STREET  
APPLETON, WI 54914  
920-738-1328  
WWW.PRESTOGEO.COM

TOWN OF AMHERST APPROVAL BOX:

DRAWING NAME:  
Site DetailsDate: 09/18/2023  
Drawn By: C. Wood  
Scale: As Noted

DRAWING NO.

Project No.: 23.4086  
C-101

## Site Details

## Solar Development

1050 New Road  
Amherst, NY

DRAWING NAME:  
Line of Sight  
Analysis  
Plan

Date: 09/18/2023  
Drawn By: C. Wood  
Scale: As Noted


DRAWING NO.

C-102

Project No.: 23.4086

TOWN OF AMHERST APPROVAL BOX:

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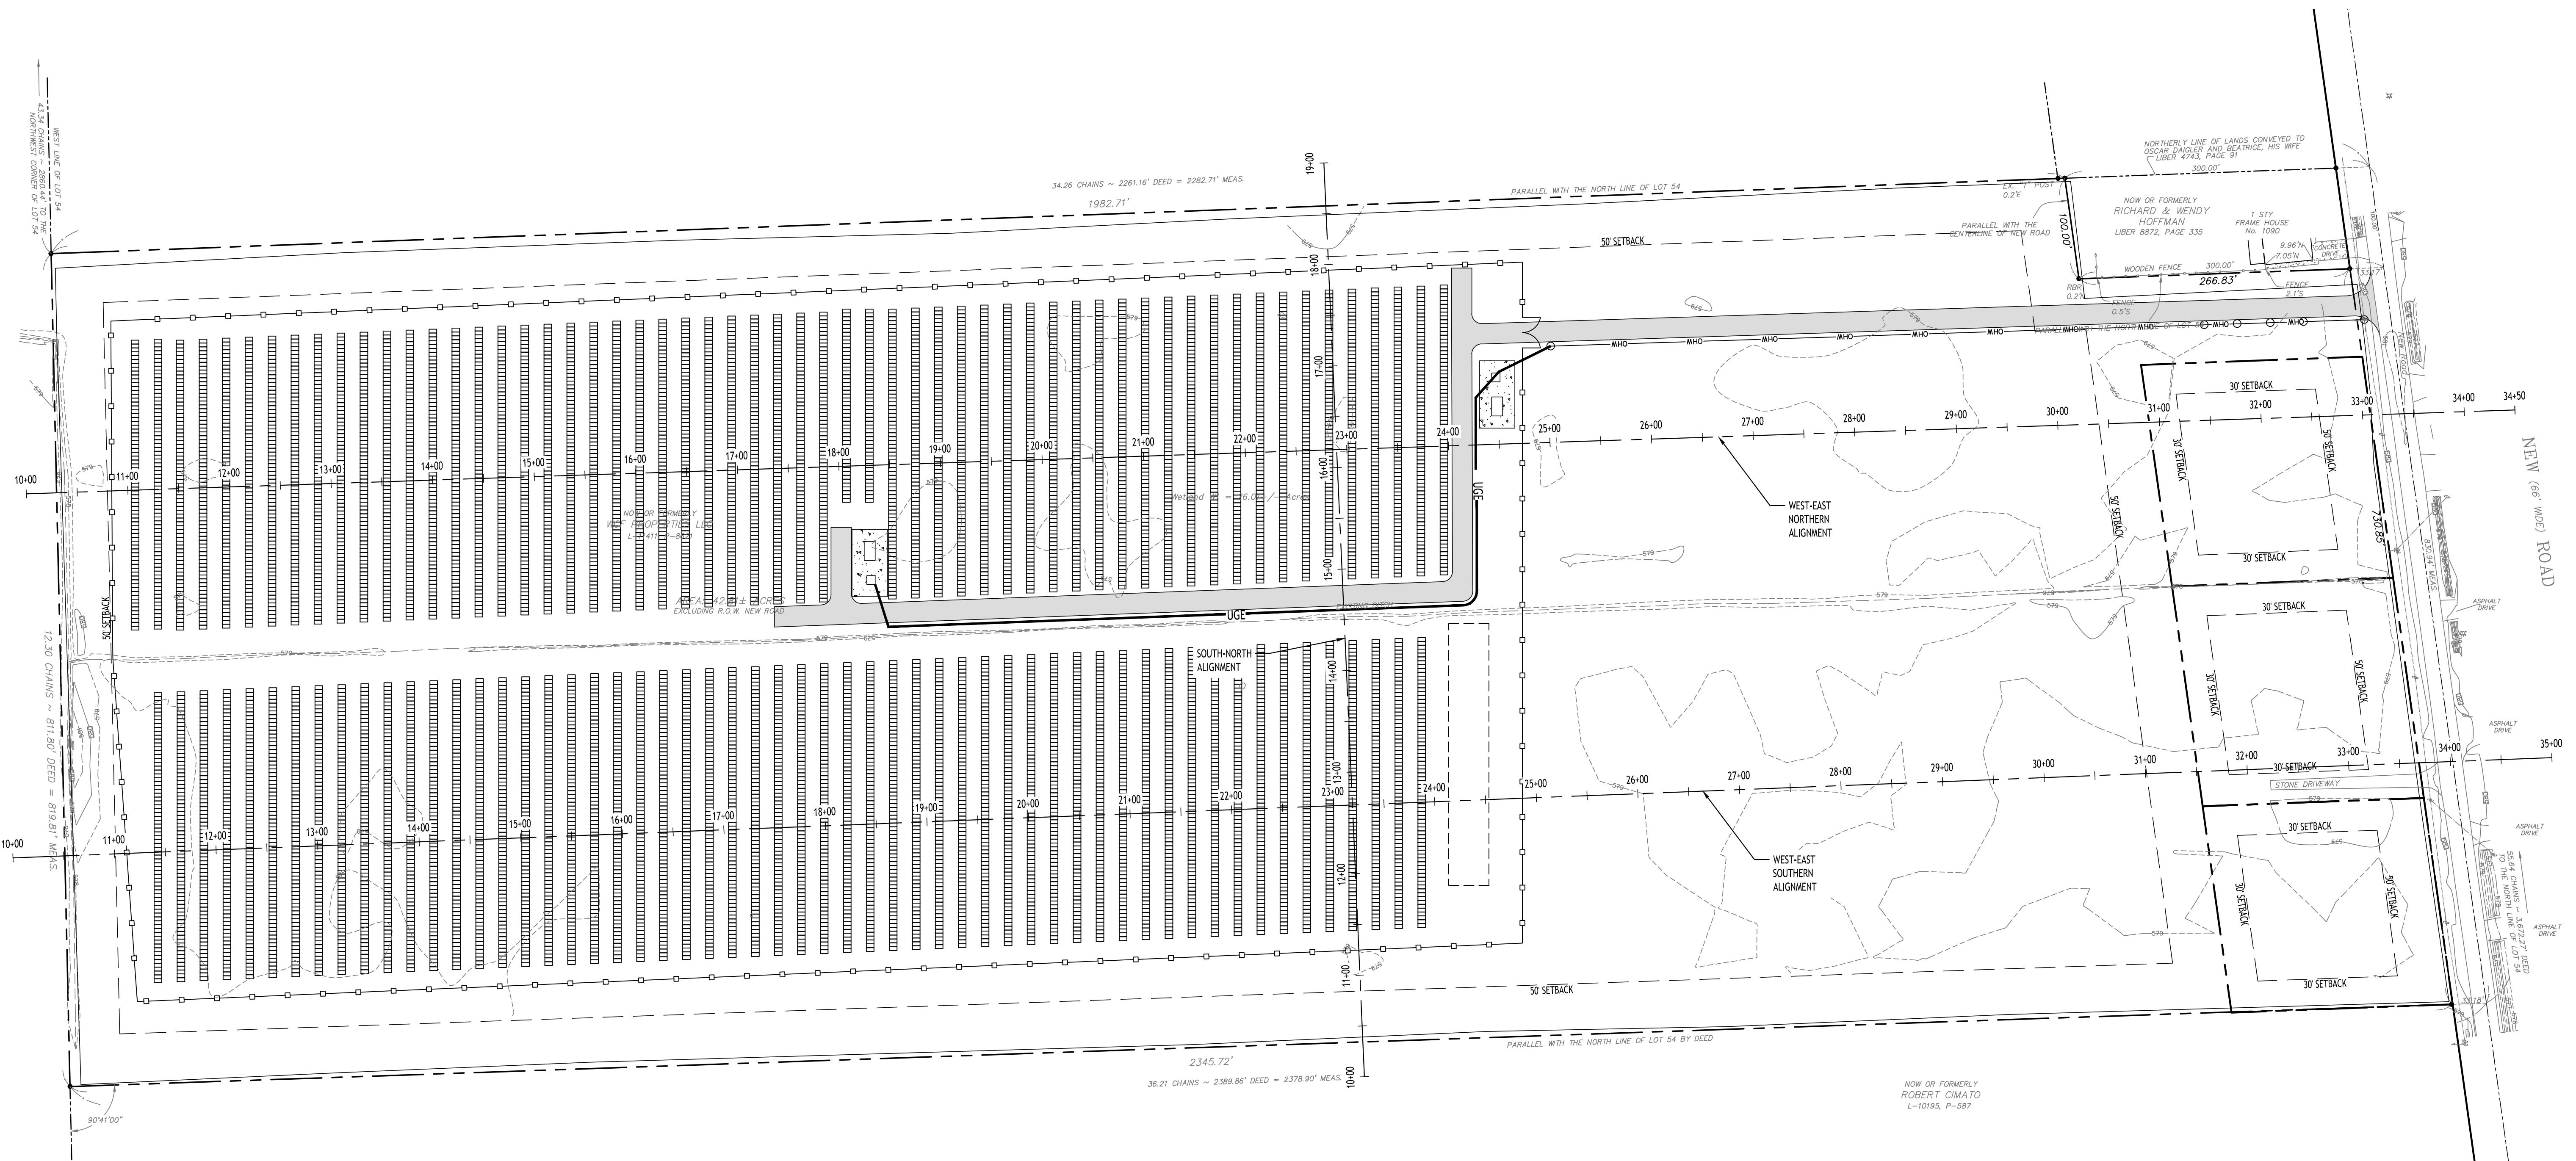
N Line of Sight Analysis Plan



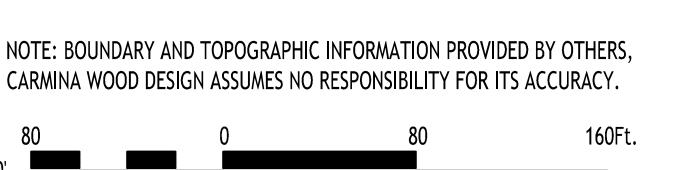
SCALE: 1"-80'

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## TOWN OF AMHERST APPROVAL BOX:

DRAWING NAME:	
Line of Sight Analysis Profiles	
Date:	09/18/2023
Drawn By:	C. Wood
Scale:	As Noted
DRAWING NO.	
C-103	
Project No.: 23.4086	

REVISIONS:  
No. Description Date

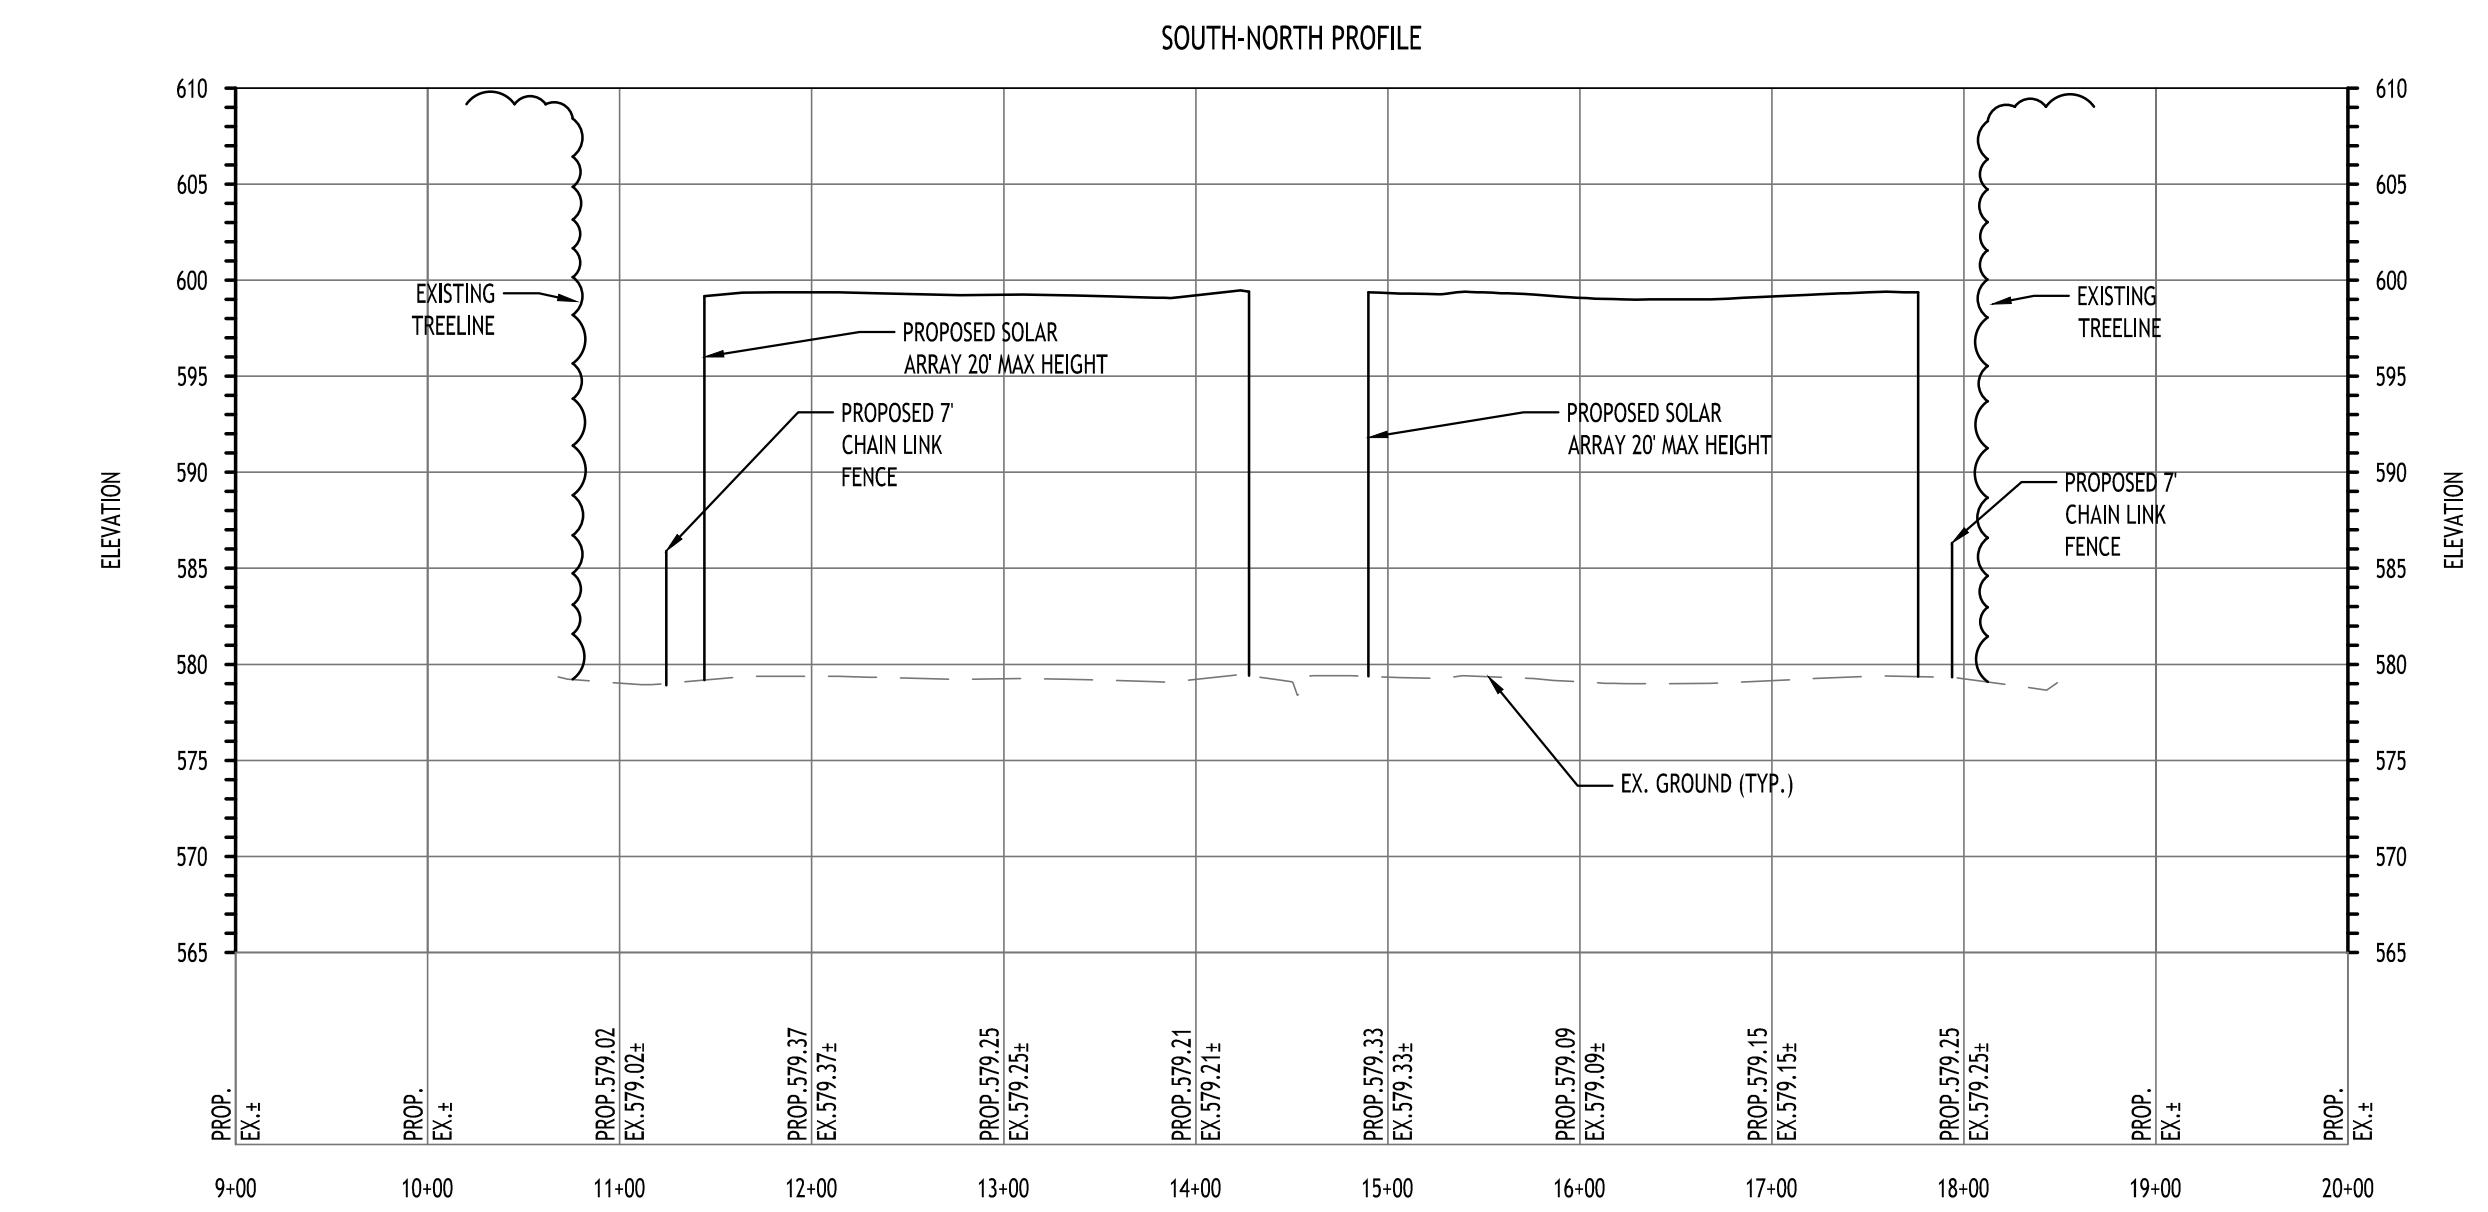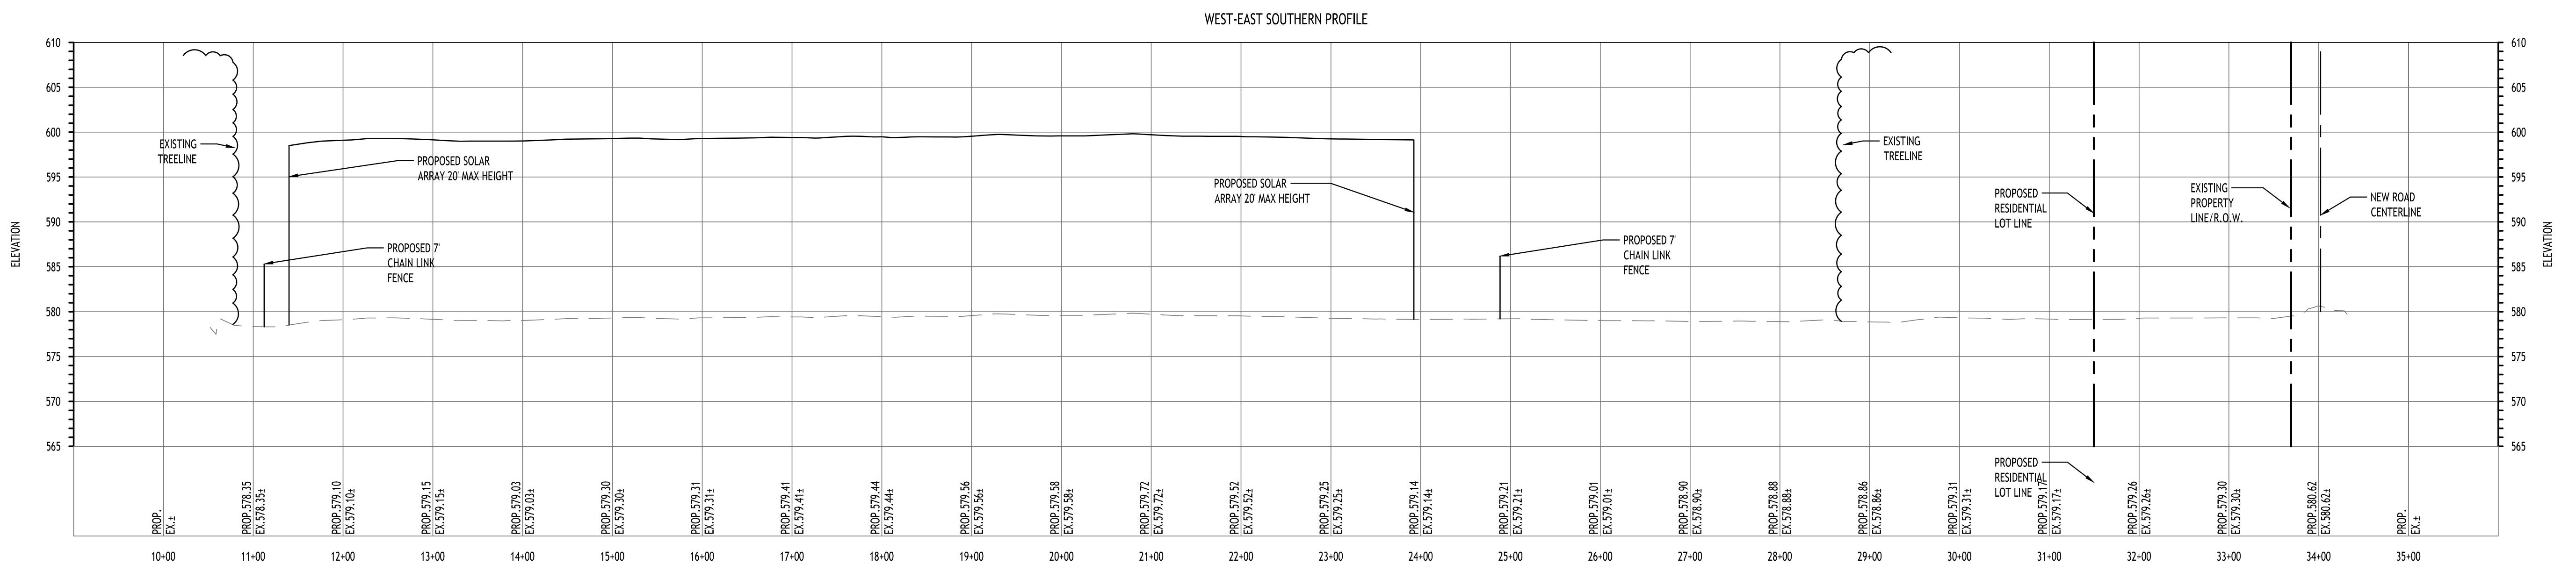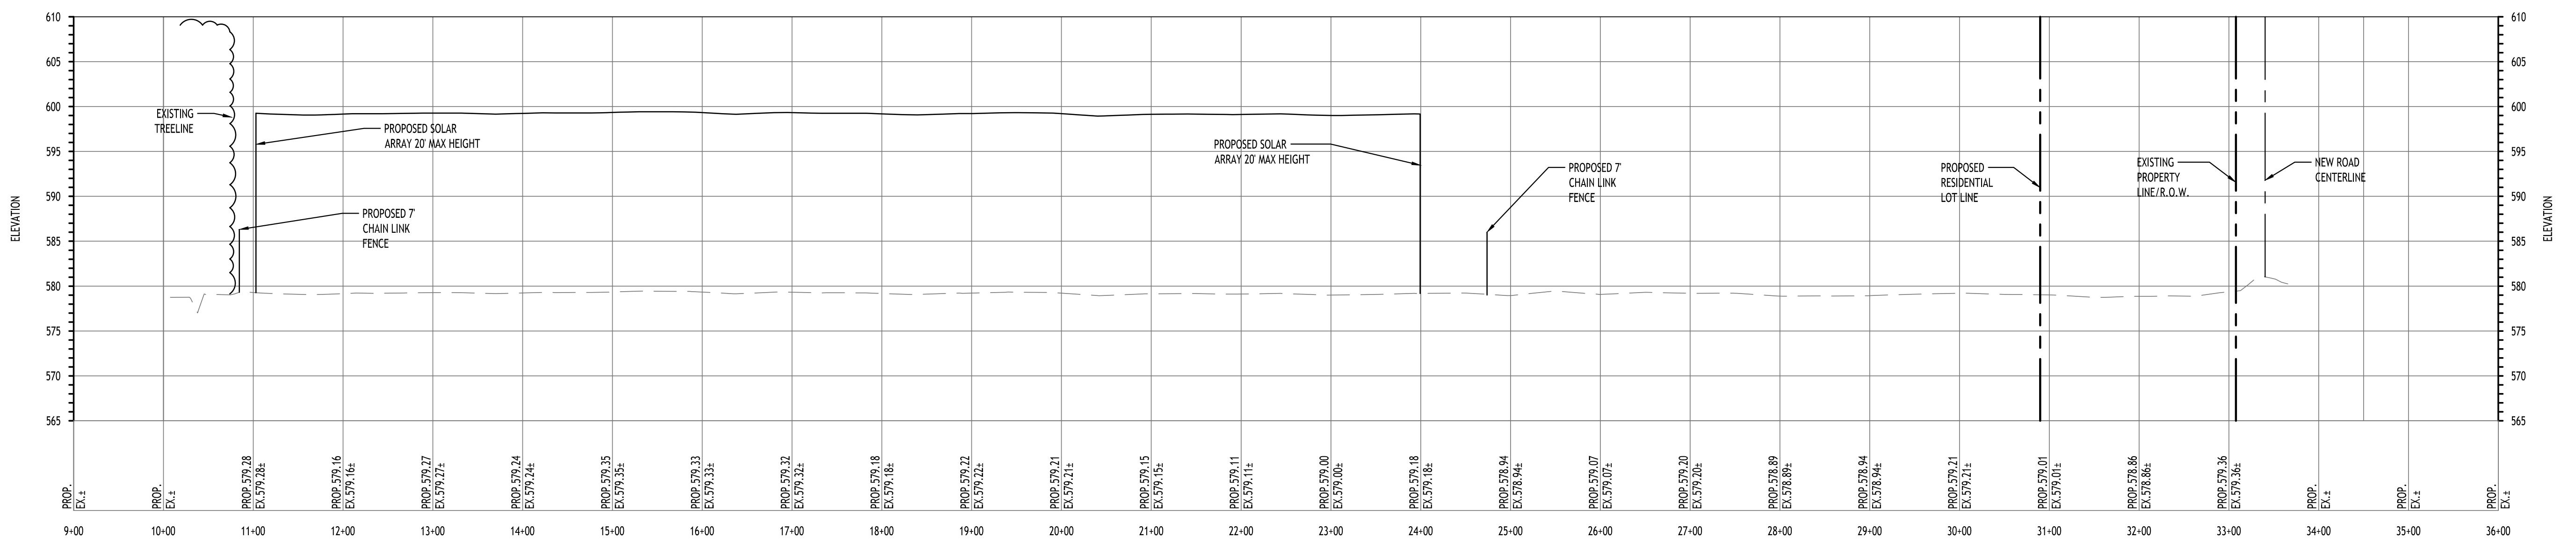

NOTE: BOUNDARY AND TOPOGRAPHIC INFORMATION PROVIDED BY OTHERS, CARMINA WOOD DESIGN, P.C. ASSUMES NO RESPONSIBILITY FOR ITS ACCURACY.

HORIZ. 100' 0' 100' 200Ft.  
VERT. 10' 0' 10' 20Ft.