Proposed Warehouse Building Amherst, New York

AGENCIES

ENGINEERING DEPARTMENT

NAME/TITLE: JEFFERY BURROUGHS, P.E. — TOWN ENGINEER COMPANY/DEPT: TOWN OF AMHERST ENGINEERING DEPARTMENT ADDRESS: 1100 NORTH FOREST ROAD

WILLIAMSVILLE, NEW YORK 14221

TELEPHONE 716-631-7154

PLANNING & ZONING DEPARTMENT

NAME/TITLE: DANIEL HOWARD — PLANNING DIRECTOR
COMPANY/DEPT: TOWN OF AMHERST PLANNING DEPARTMENT

ADDRESS: 5583 MAIN STREET

WILLIAMSVILLE, NEW YORK 14221

TELEPHONE 716-631-7051

BUILDING DEPT.

NAME/TITLE: BERKE, MARK S. — COMMISSIONER OF BUILDING

COMPANY/DEPT .: TOWN OF AMHERST BUILDING DEPT.

5583 MAIN ST.

ADDRESS: AMHERST, NEW YORK 14221

TELEPHONE 716-631-7080

ECDOH NAME/TITLE:

COMPANY/DEPT:. ERIE COUNTY DEPARTMENT OF HEALTH ADDRESS: 503 KENSINGTON AVE

503 KENSINGTON AVE BUFFALO, NEW YORK 14214

TELEPHONE 716-961-6854

<u>NYSDEC</u>

NAME/TITLE: COMPANY/DEPT:

PANY/DEPT: NEW YORK STATE DEPT. OF ENVIRONMENTAL

ADDRESS: CONSERVATION 700 DELAWARE AVE.

BUFFALO, NEW YORK 14209

TELEPHONE 716-851-7070

UTILITIES

NATURAL GAS

COMPANY/DEPT:.

NATIONAL FUEL GAS CORP. 6363 MAIN STREET WILLIAMSVILLE, NEW YORK 14221

TELEPHONE 716-857-7000

TELEPHONE COMPANY

COMPANY/DEPT:
ADDRESS:

VERIZON 65 FRANKLIN STREET BUFFALO, NEW YORK 14203

TELEPHONE 716-840-8748

CABLE COMPANY COMPANY/DEPT:

ADDRESS:

ADDRESS:

TIME WARNER 789 CHURCH ROAD WEST SENECA, NEW YORK

TELEPHONE 716-558-8615

ELECTRIC COMPANY COMPANY/DEPT:

NATIONAL GRID 144 KENSINGTON AVENUE BUFFALO, NEW YORK 14214

TELEPHONE 716-236-2738

<u>WATER</u>

COMPANY/DEPT:. ERIE 3030

ERIE COUNTY WATER AUTHORITY 3030 UNION ROAD CHEEKTOWAGA, NEW YORK 14227

TELEPHONE 716-684-1510

DIG SAFELY NEW YORK

TELEPHONE 1-800-962-7962

DESIGN CONSULTANTS

PROJECT SURVEYOR

NAME/TITLE: COMPANY/DEPT:. ADDRESS:

GPI ENGINEERING, LANDSCAPE, ARCHITECTURE & SURVEYING, LLP 4950 GENESEE STREET, SUITE 100 BUFFALO, NEW YORK 14225

TELEPHONE 716-633-4844

OWNER/DEVELOPER

NAME: STEPHENS PLUMBING
ADDRESS 5500 MILLERSPORT HIGHWAY

EAST AMHERST, NY 14051

CONTACT: KEVIN STEPHENS TELEPHONE 716-512-9451





CARMINAWOOD DESIGN

November 2024
Rev. July 2025

COVER SHEET

LAND SURVEY (PREPARED BY GPI ENGINEERING)

C-001 EROSION CONTROL PLAN

C-002 EROSION CONTROL DETAILS

C-100 SITE PLAN

C-101 SITE DETAILS

C-200 GRADING PLAN

C-300 STORM DRAINAGE PLAN

DRAWING TITLE

C-301 BASIN DETAILS
C-302 STORM DRAINAGE DETAILS
C-400 UTILITY PLAN
C-401 UTILITY DETAILS
C-402 UTILITY DETAILS
C-403 UTILITY DETAILS
C-404 UTILITY DETAILS
L-100 LANDSCAPE PLAN
L-101 LANDSCAPE DETAILS
LP-100 LIGHTING PLAN
LP-101 LIGHTING DETAILS


-100 FIRE TRUCK TURN PLA


REVISIONS:

No. Description Date

1 Rev. Per Town Comments 03/21/2025
Rev. Per Town Comments 07/07/2025

Proposed Warehouse Building Amherst, New York

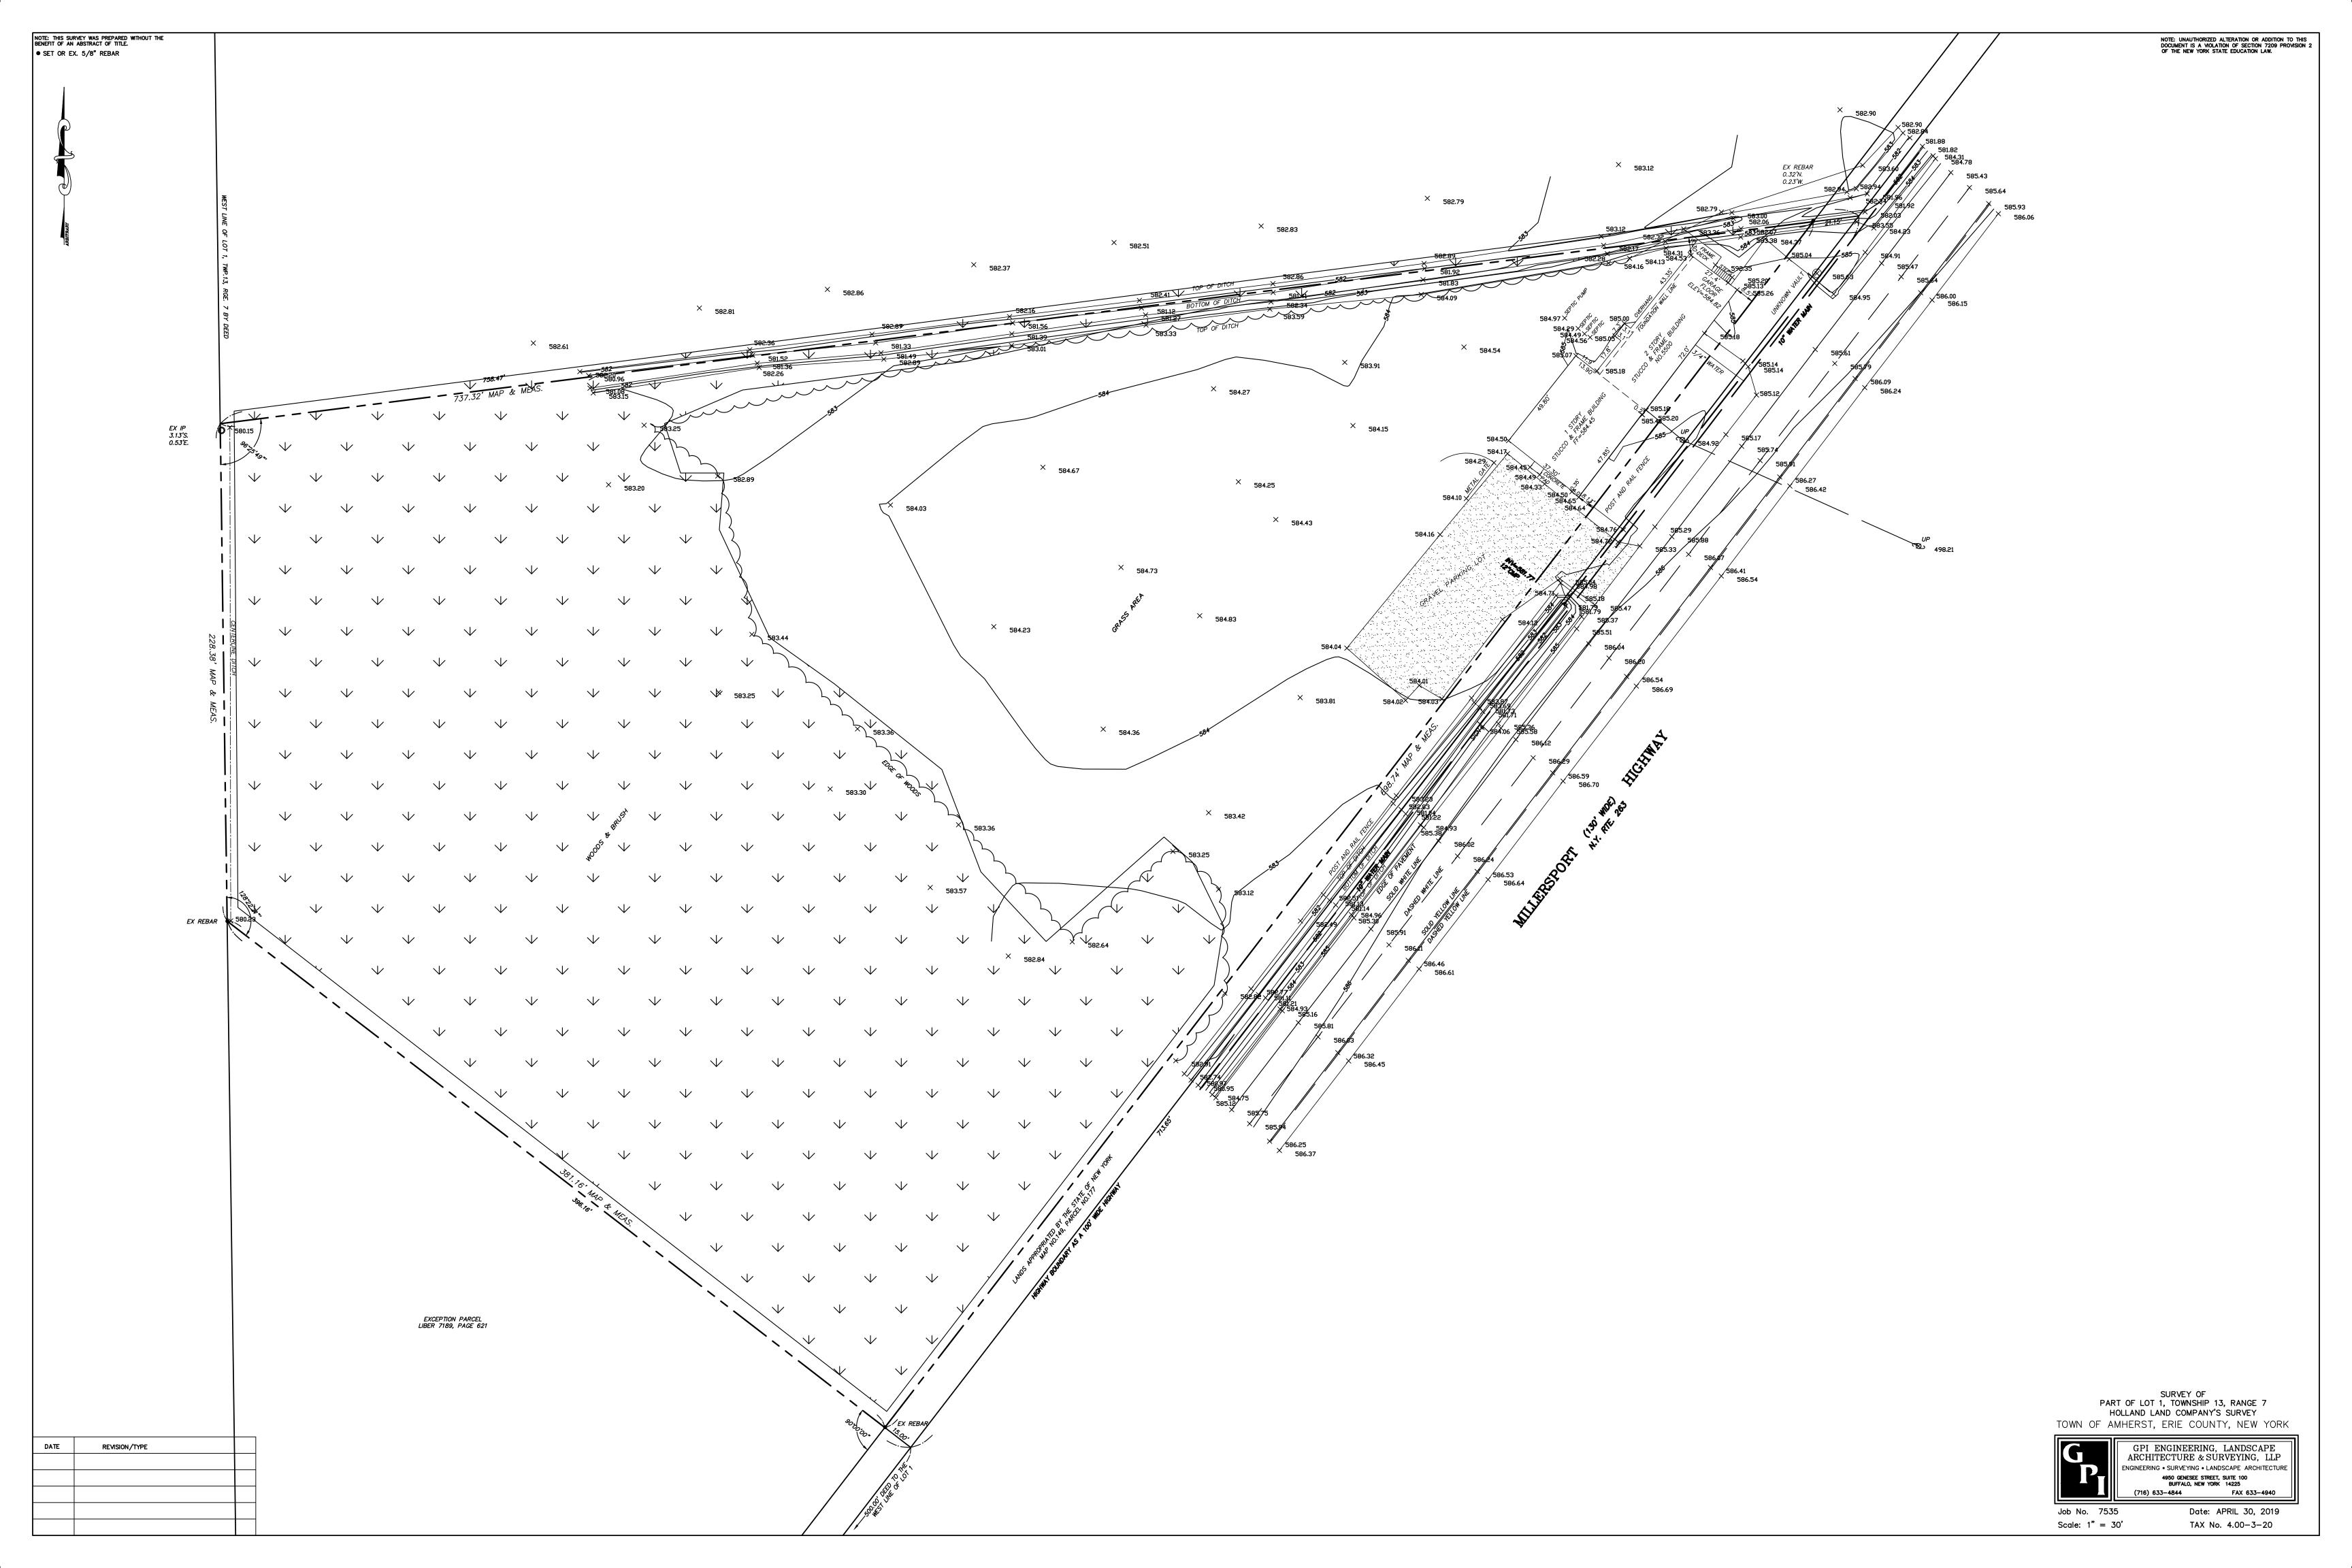

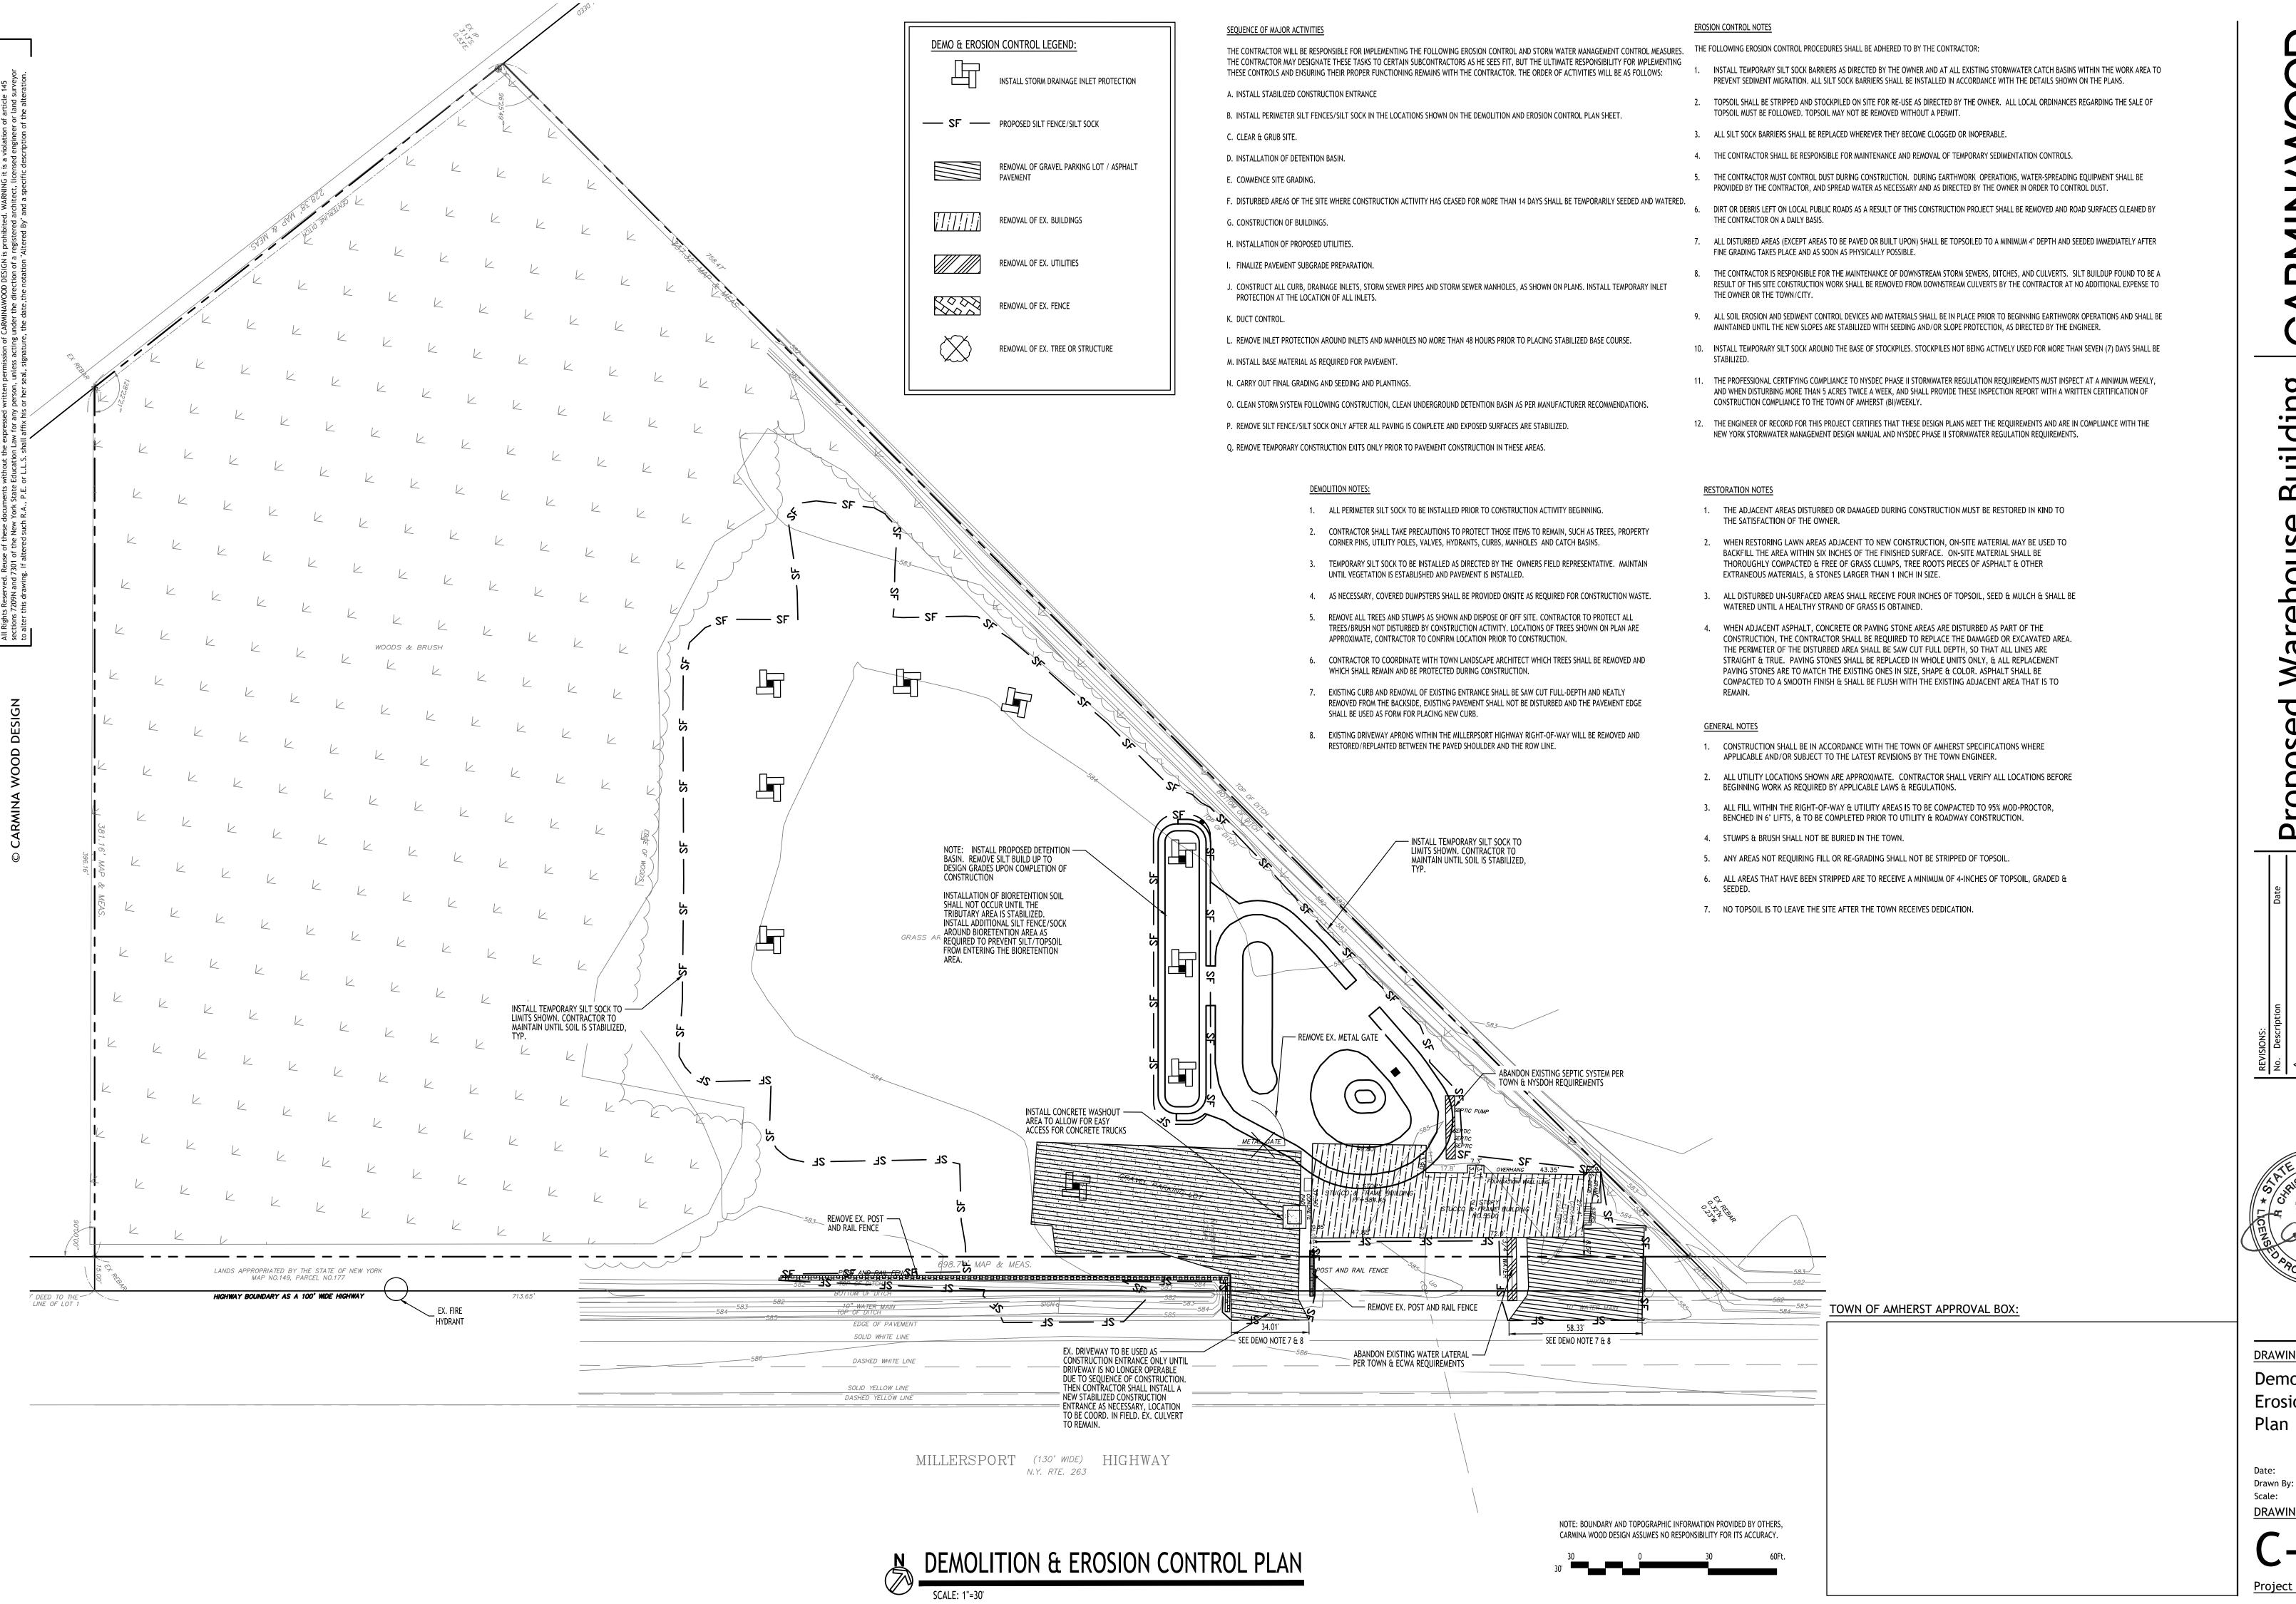


 $\mathbf{\Omega}$

DRAWING NAME: Demolition & **Erosion Control** Plan

DRAWING NO.

C. Wood As Noted

11/19/24

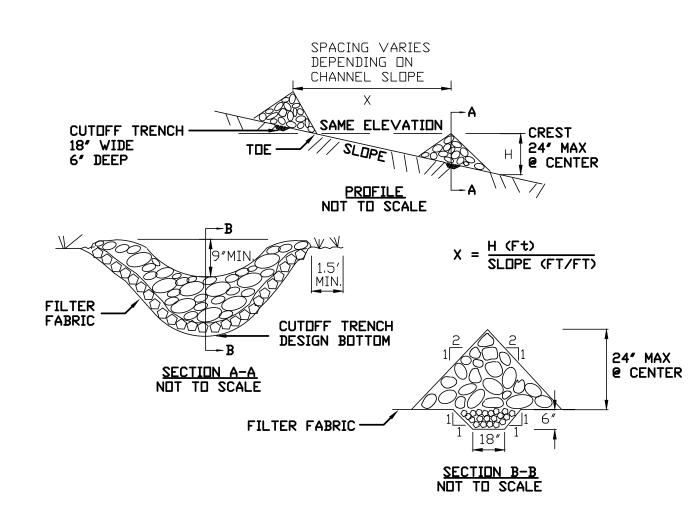

CONSTRUCTION SPECIFICATIONS

- 1. STONE WILL BE PLACED ON A FILTER FABRIC FOUNDATION TO THE LINES, GRADES AND LOCATIONS SHOWN IN THE PLAN.
- 2. SET SPACING OF CHECK DAMS TO ASSUME THAT THE ELEVATIONS OF THE CREST OF THE DOWNSTREAM DAM IS AT THE SAME ELEVATION OF THE TOE OF THE
- 3. EXTEND THE STONE A MINIMUM OF 1.5 FEET BEYOND THE DITCH BANKS TO PREVENT CUTTING AROUND THE DAM.
- 4. PROTECT THE CHANNEL DOWNSTREAM OF THE LOWEST CHECK DAM FROM SCOUR

STONE CHECK DAM DETAIL

NOT TO SCALE

AND EROSION WITH STONE OR LINER AS APPROPRIATE. 5. ENSURE THAT CHANNEL APPURTENANCES SUCH AS CULVERT ENTRANCES BELOW CHECK DAMS ARE NOT SUBJECT TO DAMAGE OR BLOCKAGE FROM DISPLACED STONE. MAXIMUM DRAINAGE AREA 2 ACRES.

EXCAVATED AREA (AS REQUIRED) EXCAVATED DEPTH MIN. 1' TO A MAX. 2' BELOW TOP OF INLET. WEEP HOLES GRAVEL SUPPORTED BY HARDWARE FOR CLOTH TO ALLOW DRAINAGE AND DEWATERING RESTRICT SEDIMENT MOVEMENT.

CONSTRUCTION SPECIFICATIONS

- 1. CLEAR THE AREA OF ALL DEBRIS THAT WILL HINDER EXCAVATION.
- 2. GRADE APPROACH TO THE INLET UNIFORMLY AROUND THE BASIN.
- 3. WEEP HOLES SHALL BE PROTECTED BY GRAVEL
- 4. UPON STABILIZATION OF CONTRIBUTING DRAINAGE AREA, SEAL WEEP HOLES, FILL BASIN WITH STABLE SOIL TO FINAL GRADE, COMPACT IT PROPERLY AND STABILIZE WITH PERMANENT SEEDING. MAXIMUM DRAINAGE AREA 1 ACRE




CONSTRUCTION SPECIFICATIONS

- 1. FILTER FABRIC SHALL HAVE AN EOS OF 40-85. BURLAP MAY BE USED FOR SHORT TERM APPLICATIONS.
- 2. CUT FABRIC FROM A CONTINUOUS ROLL TO ELIMINATE JOINTS. IF JOINTS ARE NEEDED THEY WILL BE OVERLAPPED TO
- 3. STAKE MATERIALS WILL BE STANDARD 2" x 4" WOOD OR EQUIVALENT. METAL WITH A MINIMUM LENGTH OF 3 FEET.
- 4. SPACE STAKES EVENLY AROUND INLET 3 FEET APART AND DRIVE A MINIMUM 18 INCHES DEEP. SPANS GREATER THAN 3 FEET MAY BE BRIDGED WITH THE USE OF WIRE MESH BEHIND THE FILTER FABRIC FOR SUPPORT.
- FABRIC SHALL BE EMBEDDED 1 FOOT MINIMUM BELOW GROUND AND BACKFILLED. IT SHALL BE SECURELY FASTENED TO THE STAKES AND FRAME.
- 6. A 2" x 4" WOOD FRAME SHALL BE COMPLETED AROUND THE CREST OF THE FABRIC FOR OVER FLOW STABILITY.


INLET PROTECTION DETAIL 2 NOT TO SCALE


NOTE: INSTALL ONE OF THE INLET PROTECTION OPTIONS SHOWN PRIOR TO CONSTRUCTION

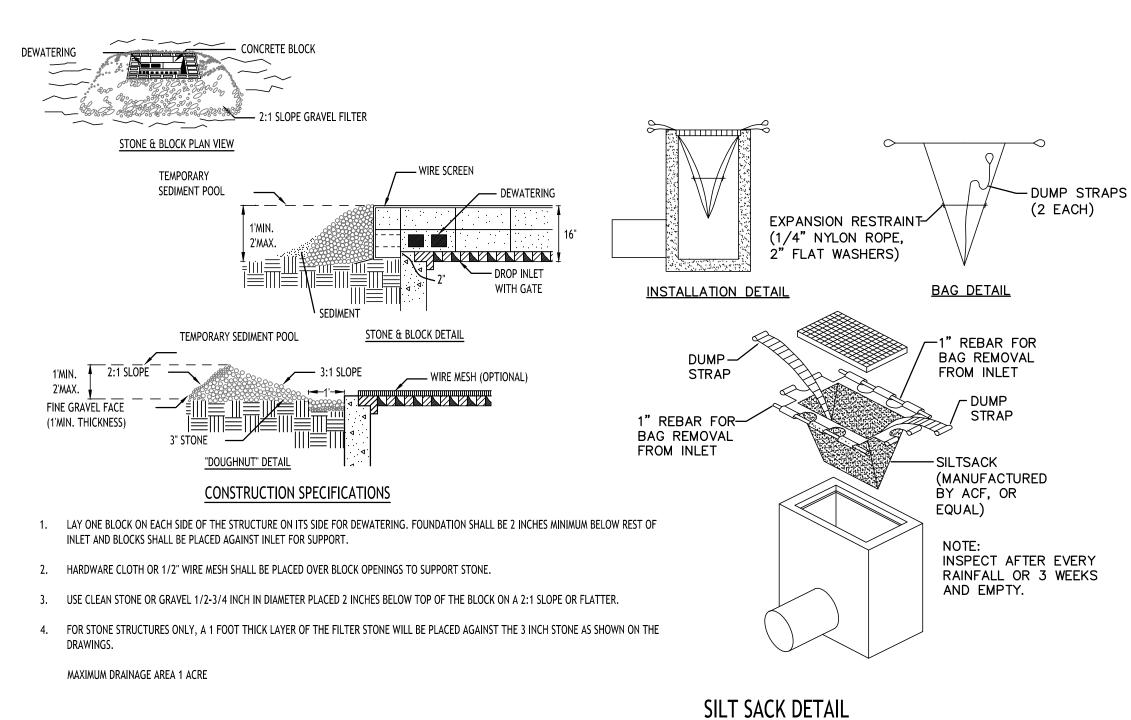

INLET PROTECTION DETAIL 3

NOT TO SCALE

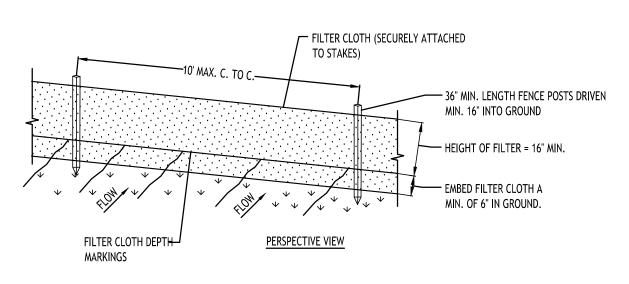


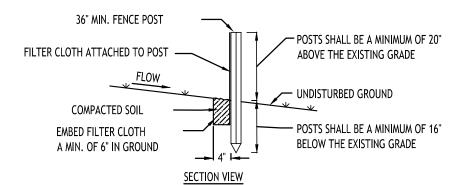

CONSTRUCTION SPECIFICATIONS

- WOVEN FENCE TO BE FASTENED SECURELY TO FENCE POSTS WITH WIRE TIES OR STAPLES. POSTS SHALL BE STEEL EITHER "T" OR "U" TYPE OR HARDWOOD.
- 2. WHEN TWO SECTIONS OF FILTER CLOTH ADJOIN EACH OTHER THEY SHALL BE OVER-LAPPED BY SIX INCHES AND FOLDED. FILTER CLOTH SHALL BE EITHER FILTER X, MIRAFI 100X, STABILINKA T140N, OR APPROVED EQUIVALENT.
- 3. MAINTENANCE SHALL BE PERFORMED AS NEEDED AND MATERIAL REMOVED WHEN "BULGES" DEVELOP IN THE SILT FENCE.


SILT FENCE DETAIL NOT TO SCALE

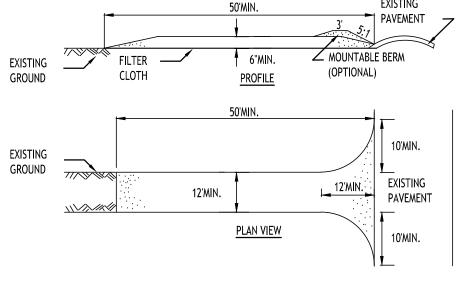


CONSTRUCTION SPECIFICATIONS

- 1. STONE SIZE USE 2" STONE, OR RECLAIMED OR RECYCLED CONCRETE EQUIVALENT.
- 2. LENGTH NOT LESS THAN 50 FEET (EXCEPT ON A SINGLE RESIDENCE LOT WHERE A 30 FOOT MINIMUM LENGTH WOULD
- 3. THICKNESS NOT LESS THAN SIX (6) INCHES.
- 4. WIDTH TWELVE (12) FOOT MINIMUM, BUT NOT LESS THAN THE FULL WIDTH AT POINTS WHERE INGRESS OR EGRESS OCCURS. TWENTY-FOUR (24) FOOT IF SINGLE ENTRANCE TO SITE.
- 5. FILTER CLOTH WILL BE PLACED OVER THE ENTIRE AREA PRIOR TO PLACING OF STONE.
- 6. SURFACE WATER ALL SURFACE WATER FLOWING OR DIVERTED TOWARD CONSTRUCTION ENTRANCES SHALL BE PIPED ACROSS THE ENTRANCE. IF PIPING IS IMPRACTICAL, A MOUNTABLE BERM WITH 5:1 SLOPES WILL BE PERMITTED.
- MAINTENANCE THE ENTRANCE SHALL BE MAINTAINED IN A CONDITION WHICH WILL PREVENT TRACKING OR FLOWING OF SEDIMENT ONTO PUBLIC RIGHTS-OF-WAY, ALL SEDIMENT SPILLED, DROPPED, WASHED OR TRACTED ONTO PUBLIC RIGHTS-OF-WAY MUST BE REMOVED IMMEDIATELY.
- 8. WHEN WASHING IS REQUIRED, IT SHALL BE DONE ON A AREA STABILIZED WITH STONE AND WHICH DRAINS INTO AN APPROVED SEDIMENT TRAPPING DEVICE.
- 9. PERIODIC INSPECTION AND NEEDED MAINTENANCE SHALL BE PROVIDED AFTER EACH RAIN.

STABILIZED CONSTRUCTION ENTRANCE DETAIL NOT TO SCALE

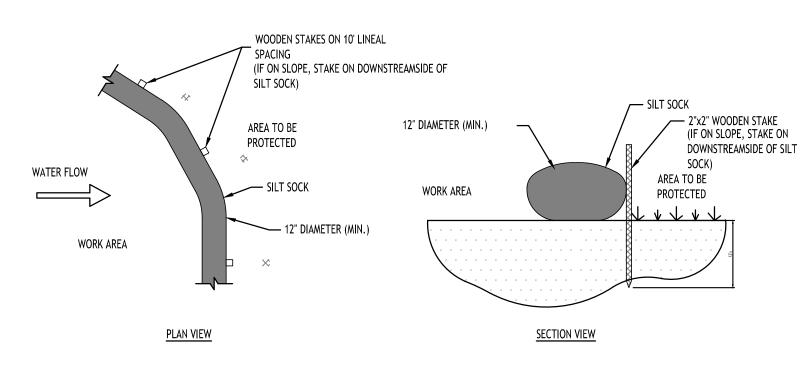

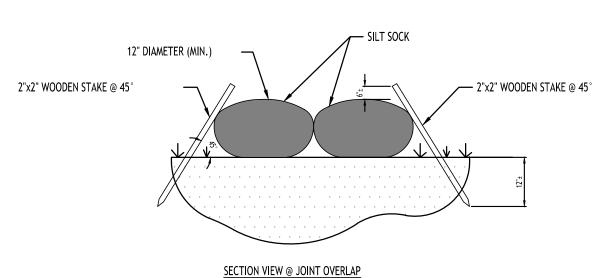


NOTES:

CONTRACTOR SHALL INSPECT AND MAINTAIN SILT SOCK AS NEEDED DURING THE DURATION OF CONSTRUCTION PROJECT.

CONTRACTOR SHALL REMOVE SEDIMENT COLLECTED AT THE BASE OF THE SILT SOCK WHEN IT HAS REACHED ¹/₂ OF THE EXPOSED HEIGHT OF THE SILT SOCK. ALTERNATIVELY, RATHER THAN CREATE A SOIL DISTURBING ACTIVITY, THE ENGINEER MAY CALL FOR ADDITIONAL SILT SOCK TO BE ADDED AT AREAS OF HIGH SEDIMENTATION, PLACED IMMEDIATELY ON TOP OF THE EXISTING SEDIMENT LADEN SILT SOCK.

SILT SOCK SHALL BE OVERLAPPED 12" AT JOINTS AND STAKED ON EACH SIDE OF THE SOCK AT A 45° ANGLE


> SILT SOCK DETAIL NOT TO SCALE

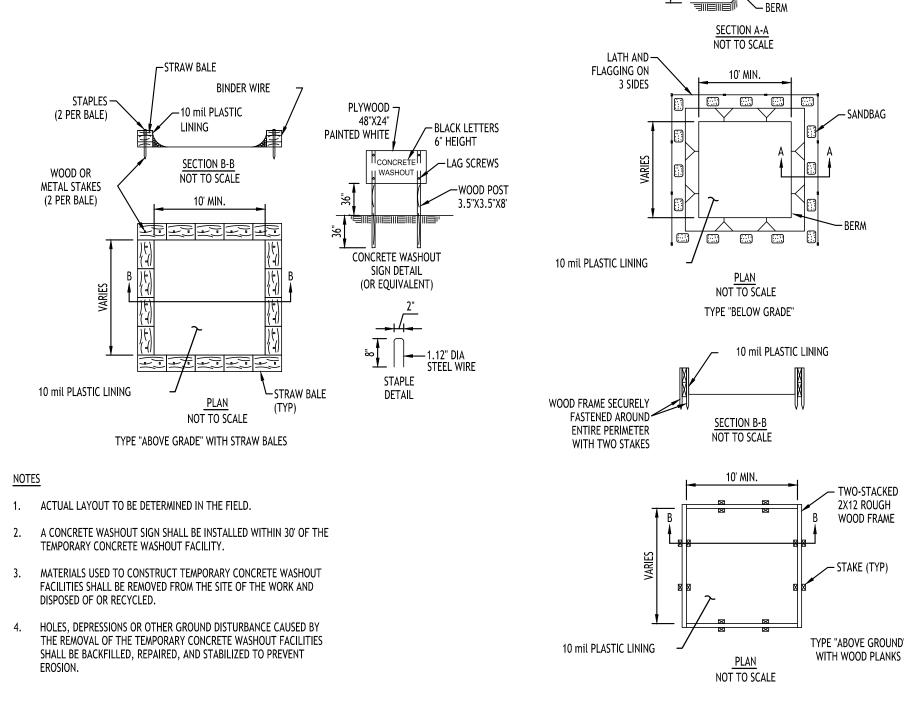

NOT TO SCALE

CONCRETE WASHOUT DETAIL NOT TO SCALE

TOWN OF AMHERST APPROVAL BOX:

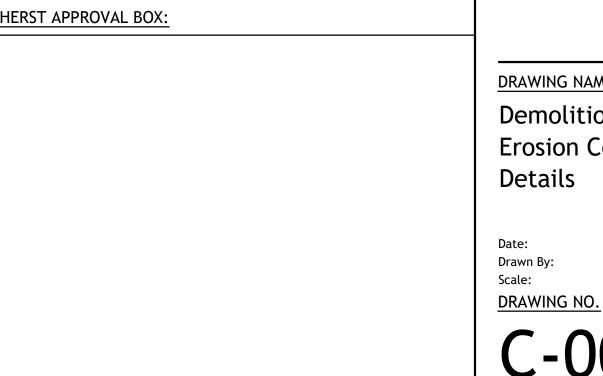

DRAWING NAME: Demolition & **Erosion Control**

D


• —

 $\mathbf{\Omega}$

11/19/24


C. Wood

As Noted

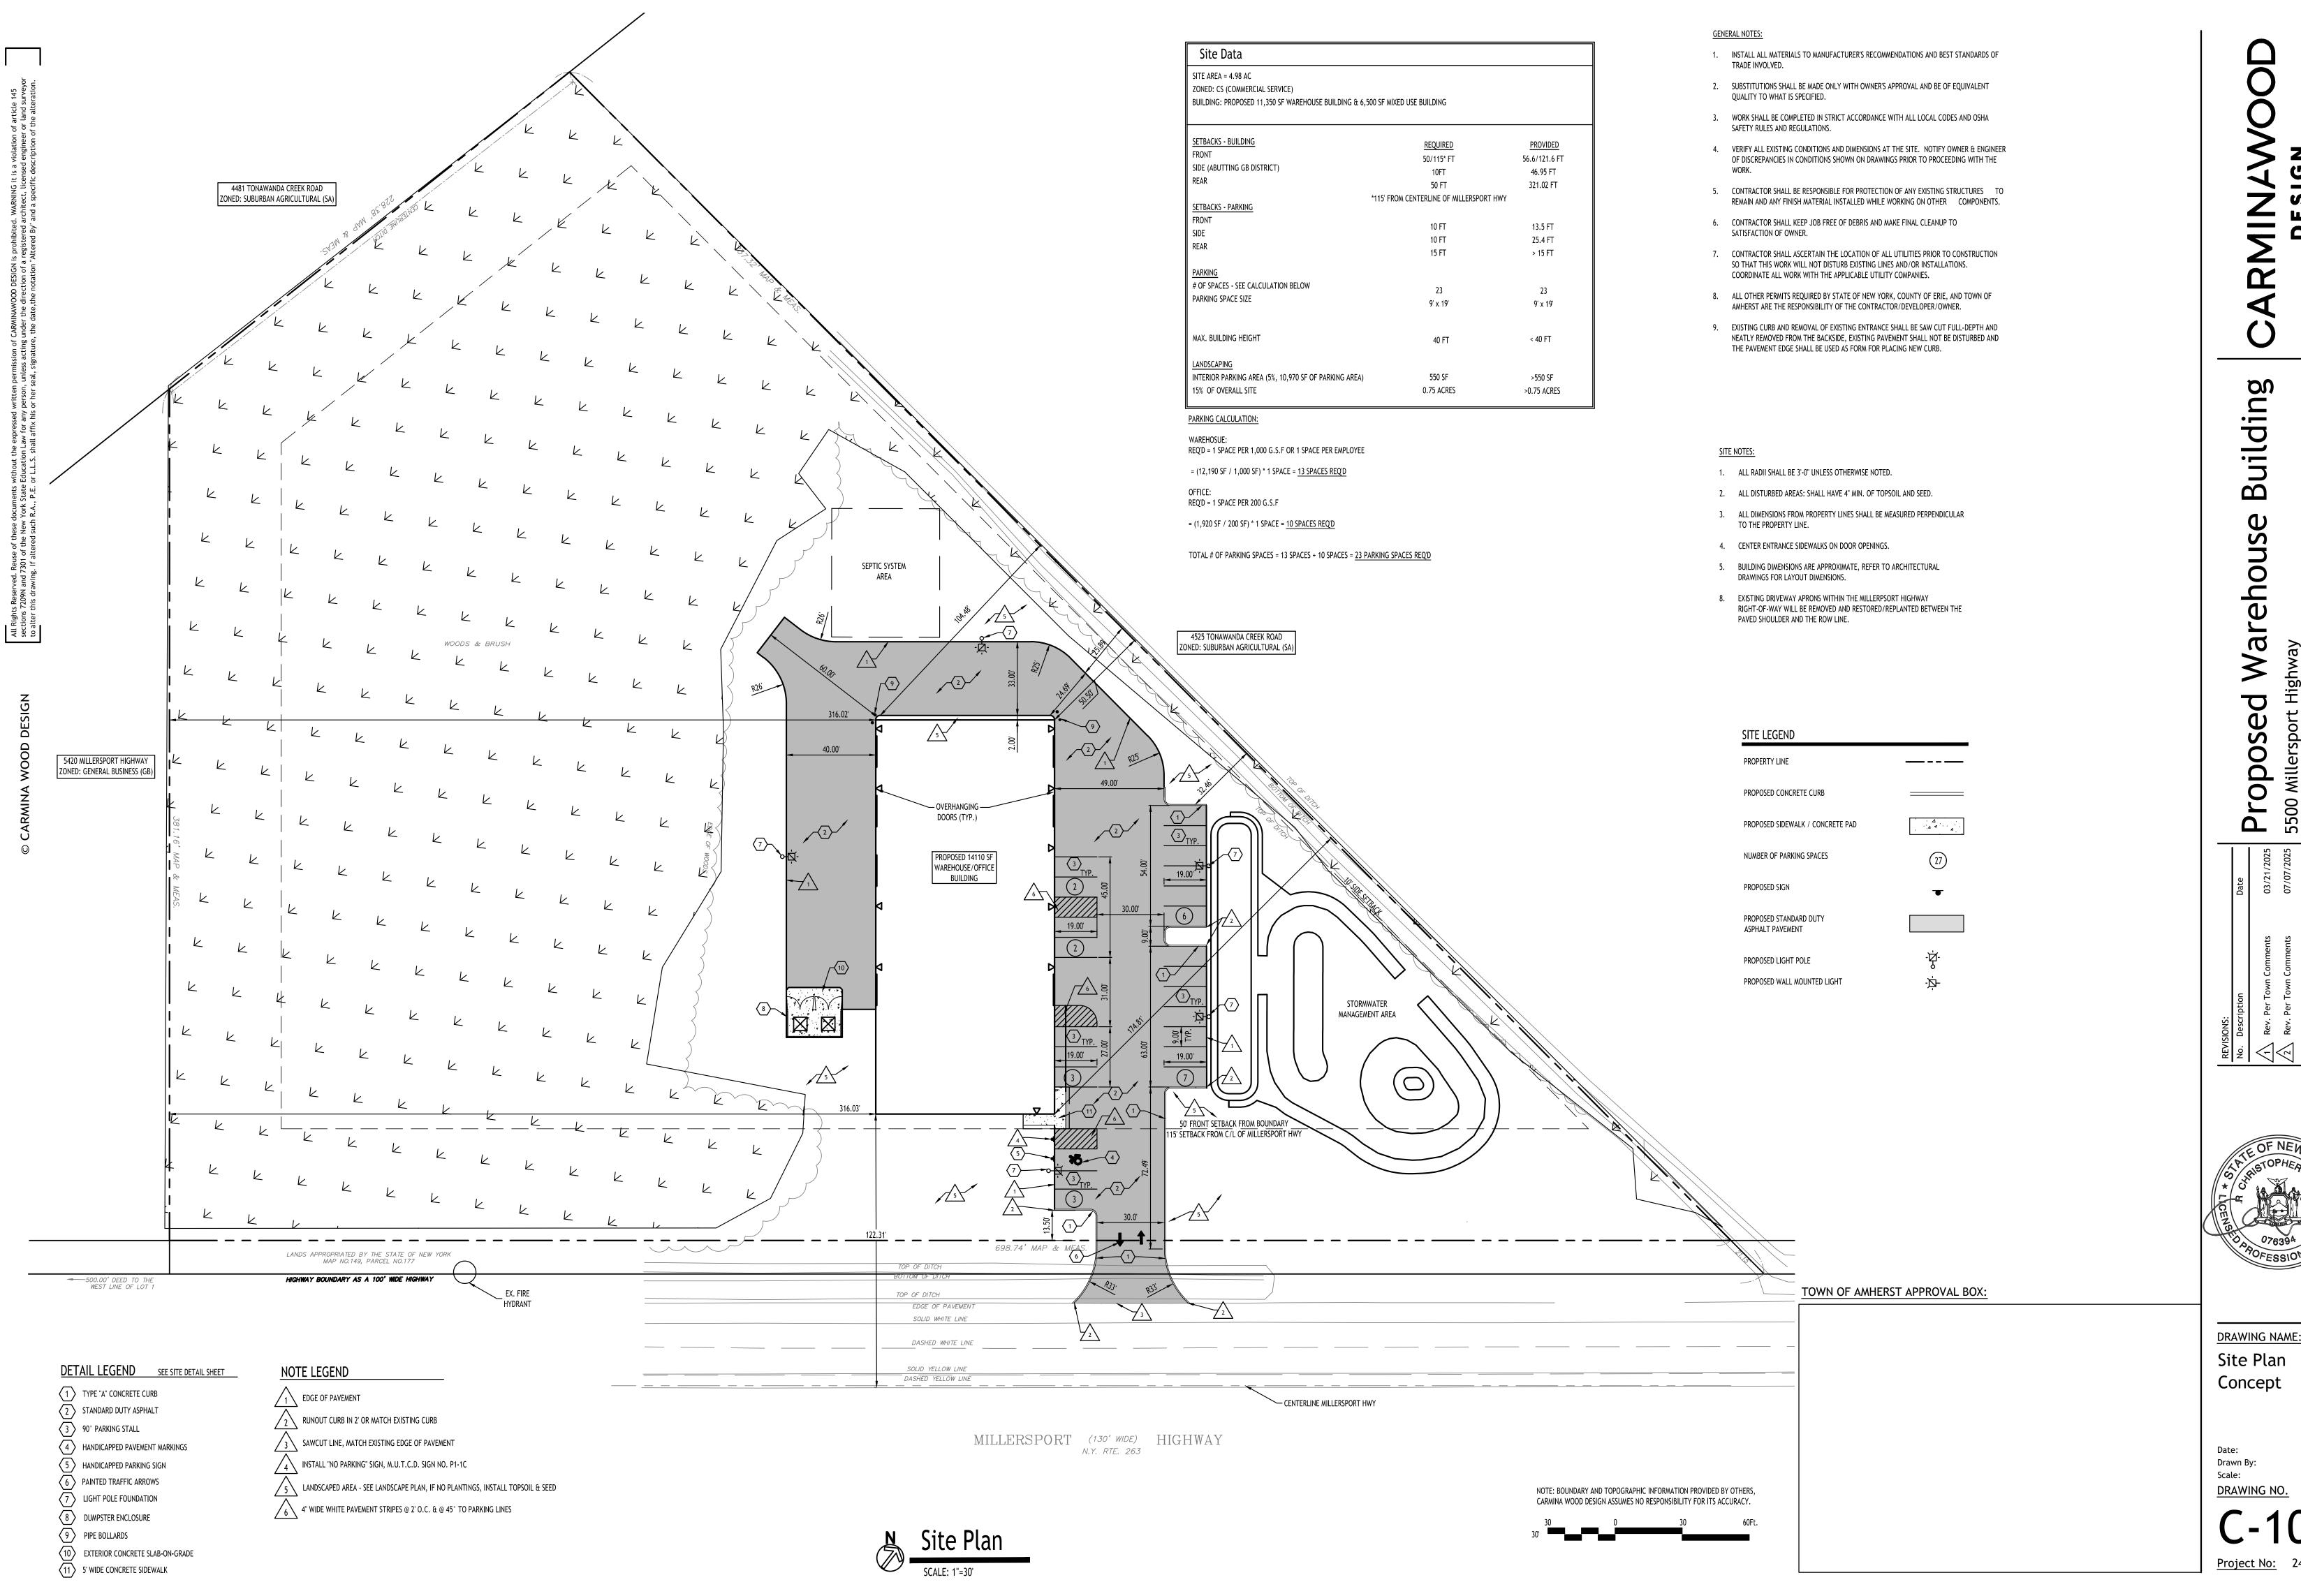

C. Wood

11/19/24

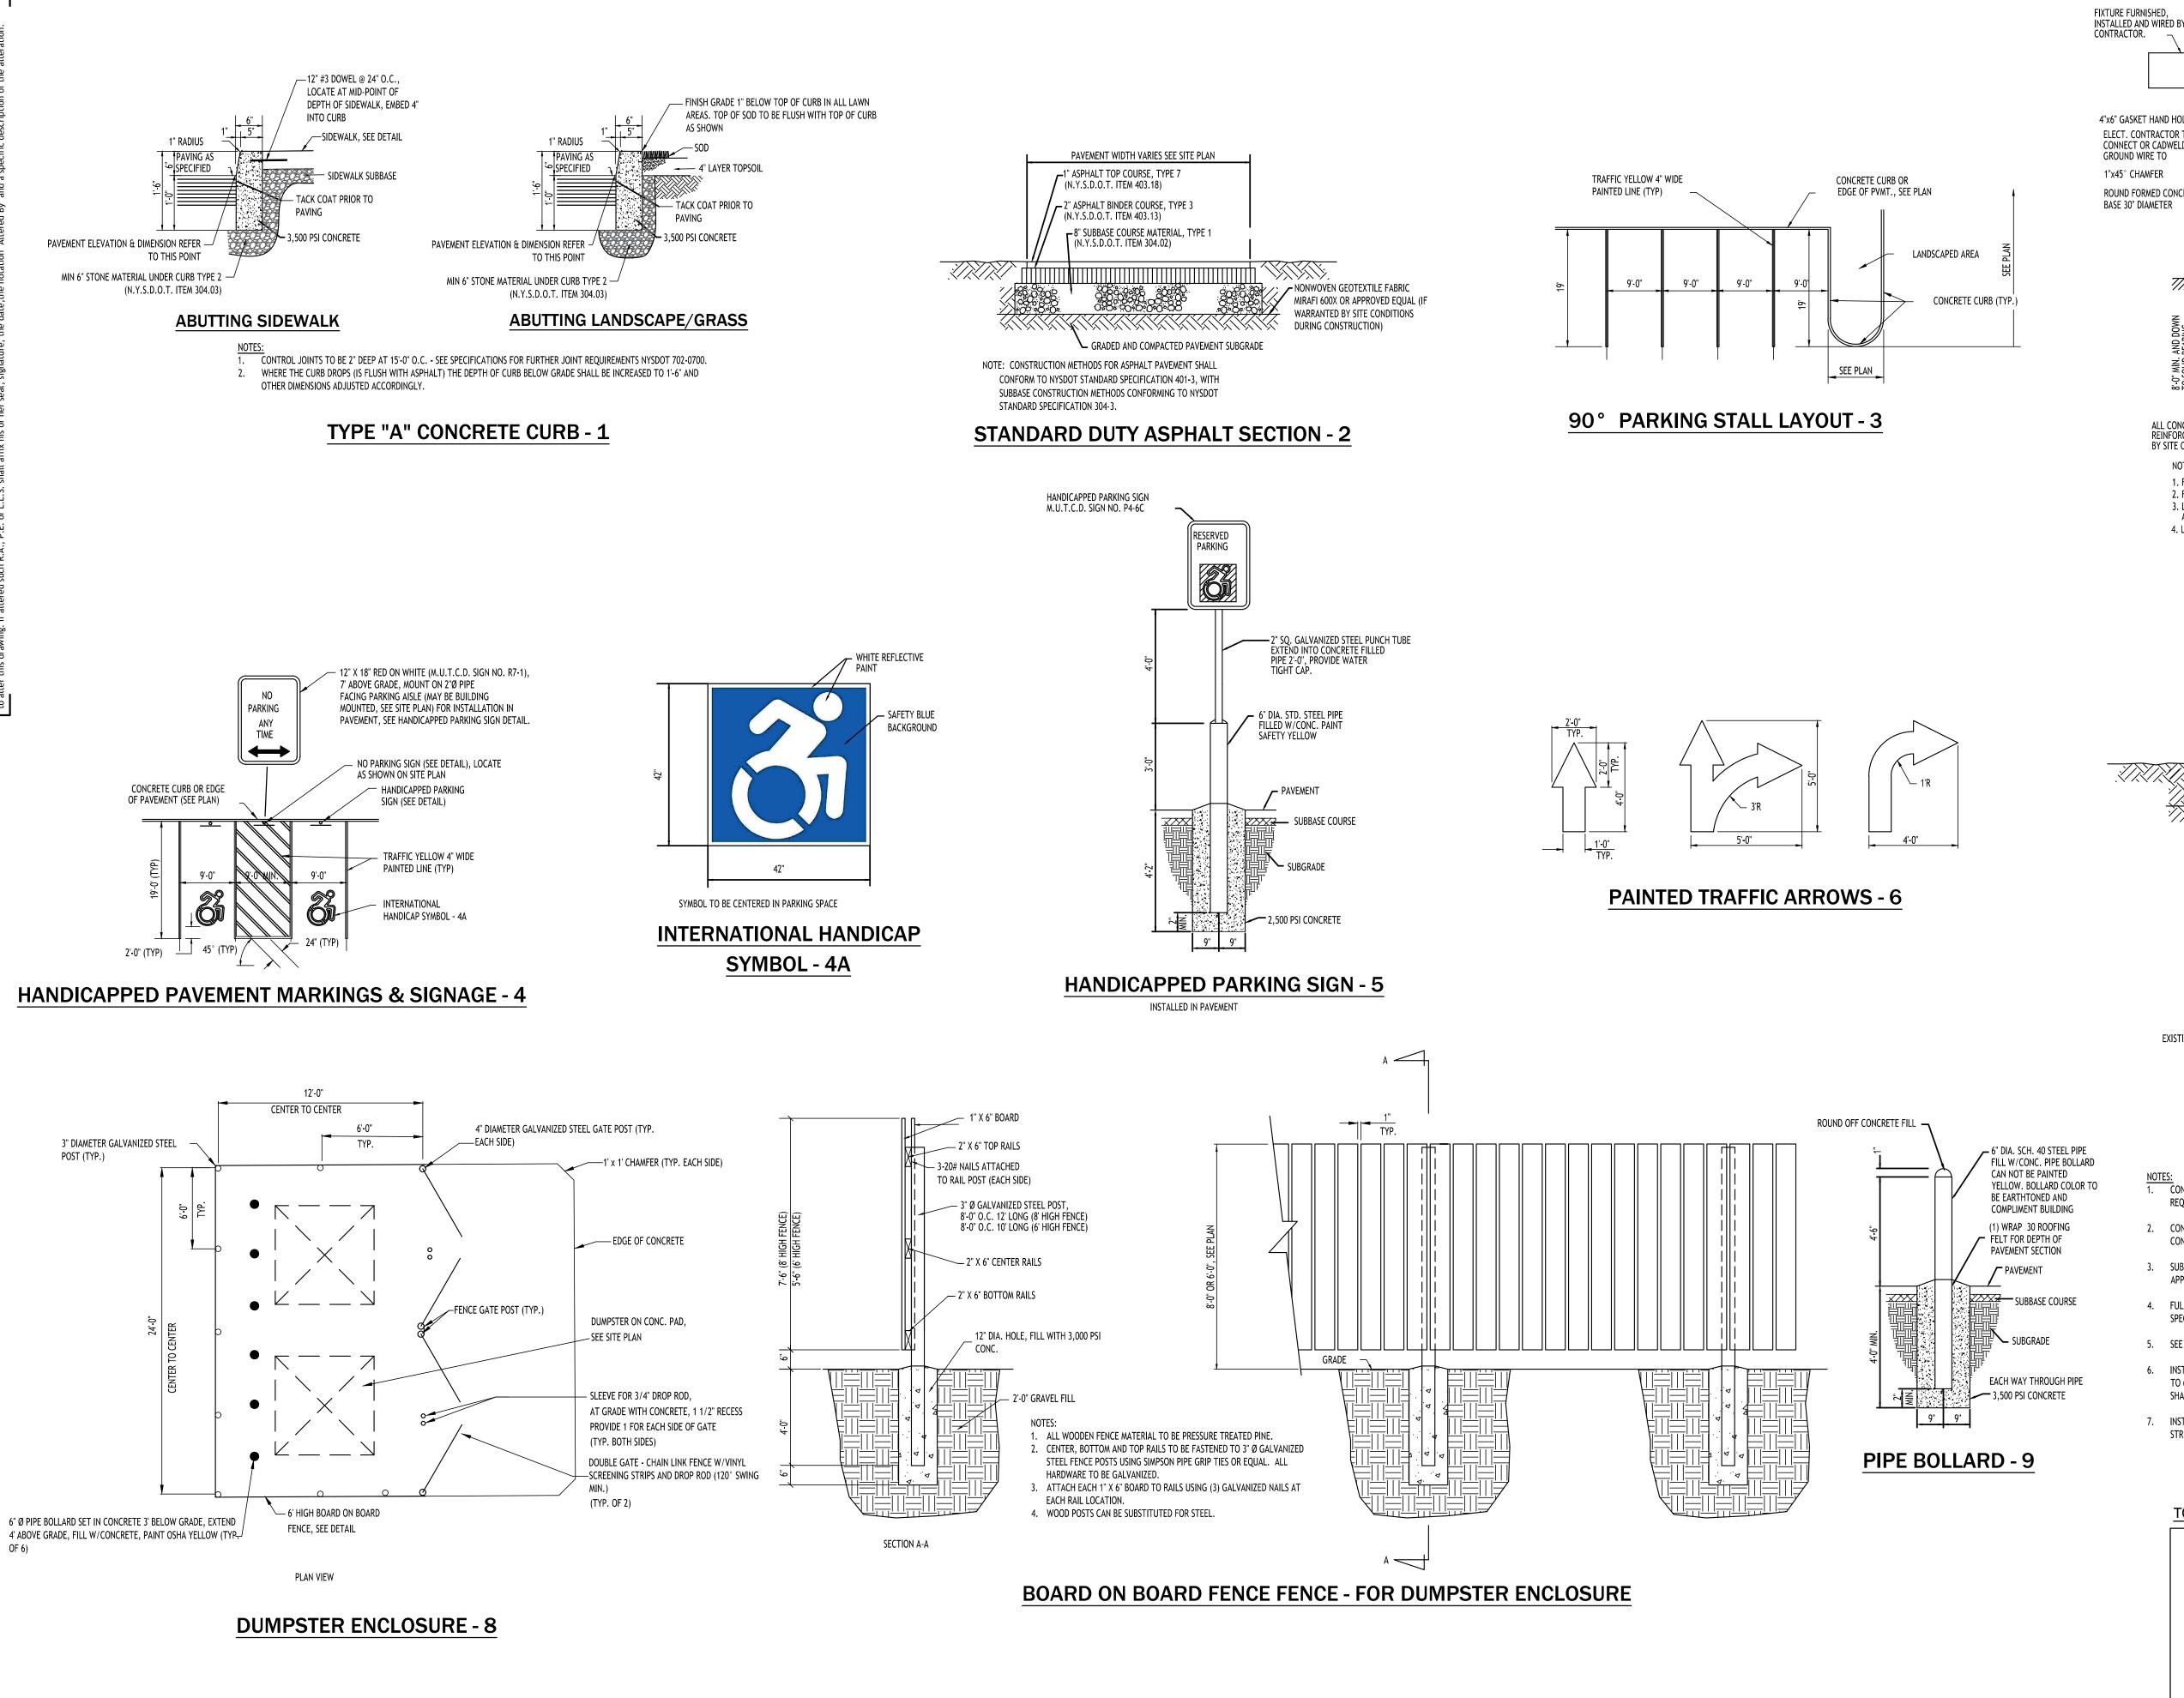


INSTALLED AND WIRED BY ELECTRICAL — ELECTRICAL CONTRACTOR FURNISHED POLE 4"x6" GASKET HAND HOLE ELECT. CONTRACTOR TO CONNECT OR CADWELD _ FURNISHED AND INSTALL IN-LINE BALLAST FUSES IN BUSSMANN "TRON" WEATHERPROOF FUSE HOLDERS #HEB-AD WITH #KTK FUSES (SIZE AS REQUIRED) ROUND FORMED CONCRETE 4 - 40"x1"Ø ANCHOR BOLTS FINISHED GRADE / #6 BARE GROUND WIRE _ 3/4 "x10" COPPER WELD GROUND ROD (LIGHTING PROTECTION) CARLON PLASTIC CONDUIT GALVANIZED STEEL TO CARLON CONDUIT CONNECTOR GALVANIZED CONDUIT "ELL" 4 - #8 VERTICAL REINF. BARS ALL CONCRETE WORK AND REINFORCING SHALL BE ____ BY SITE CONTRACTOR 1. FOR LOCATIONS OF FOUNDATIONS SEE SITE PLAN 2. FOR LIGHT FIXTURE ORDERING INFORMATION SEE SITE LIGHTING PLAN 3. LIGHTING FIXTURES SHALL BE A MAXIMUM OF 25 FEET IN HEIGHT WITHIN PARKING AND SHALL BE A MAXIMUM OF 15 FEET WITHIN NON-VECHICULAR PEDESTRIAN AREAS 4. LIGHT POLE BASE EXPOSURE ABOVE GRADE SHALL BE:

LIGHT POLE FOUNDATION - 7

IN CURBED ISLANDS: 6" ABOVE TOP OF CURB ELEVATION


IN NON-CURBED GRASS AREAS: 6" ABOVE GRADE

IN PAVEMENT: 30" ABOVE GRADE

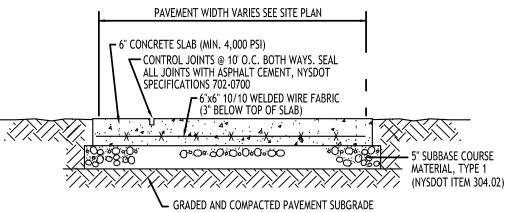

NOTE: CONCRETE PAVEMENT MATERIAL SHALL CONFORM TO NYSDOT STANDARD SPECIFICATION 501 AND CONSTRUCTION METHODS SHALL CONFORM TO NYSDOT STANDARD SPECIFICATION 502-3.

EXTERIOR CONCRETE SLAB-ON-GRADE SECTION - 10

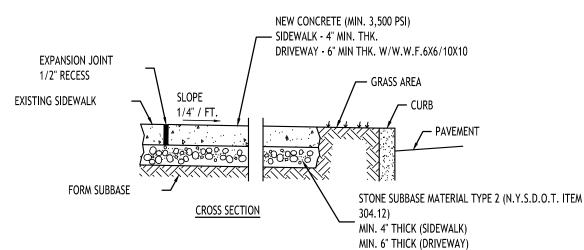

NOTES:

1. CONTROL JOINTS TO BE AT 5'-0" O.C., BOTH WAYS WHERE APPLICABLE. SEE SPECIFICATIONS FOR FURTHER JOINT REQUIREMENTS NYSDOT 702-0700.

2. CONCRETE SIDEWALK AND DRIVEWAY MATERIAL SHALL CONFORM TO NYSDOT STANDARD SPECIFICATION 501 AND CONSTRUCTION METHODS SHALL CONFORM TO NYSDOT STANDARD SPECIFICATION 608-3.

S. SUBBASE GRADE SHALL FOLLOW THE PROPOSED GRADE OF THE SIDEWALK AND SLOPE AWAY FROM BUILDING WHERE APPLICABLE, PROVIDE CONTINUOUS STONE PATH TO CURB UNDERDRAIN WHERE PROVIDED.

4. FULL DEPTH EXPANSION JOINTS SHALL BE INSTALLED EVERY 20' O.C., BOTHWAYS WHERE APPLICABLE. SEE

SPECIFICATIONS FOR FURTHER JOINT REQUIREMENTS NYSDOT 702-0700.


5. SEE CURB DETAIL FOR DOWLING REQUIREMENTS WHERE ABUTTING CURB.

6. INSTALL 6" LONG #3 DOWELS @ 12" O.C. WHERE SIDEWALK ABUTS A BUILDING WALL AT AN ENTRANCE, THICKEN SIDEWALK TO 6" AT BUILDING WALL AND INSTALL DOWEL CENTERED IN THE 6" DEPTH. DOWELS AND THICKENING OF SIDEWALK SHALL EXTEND 18" EITHER SIDE OF ENTRANCE.

7. INSTALL 1/2" PREMOLDED EXPANSION JOINT WITH BACKER ROD & SEALANT WHERE SIDEWALK ABUTS BUILDING OR OTHER STRUCTURE.

CONCRETE SIDEWALK - 11

TOWN OF AMHERST APPROVAL BOX:

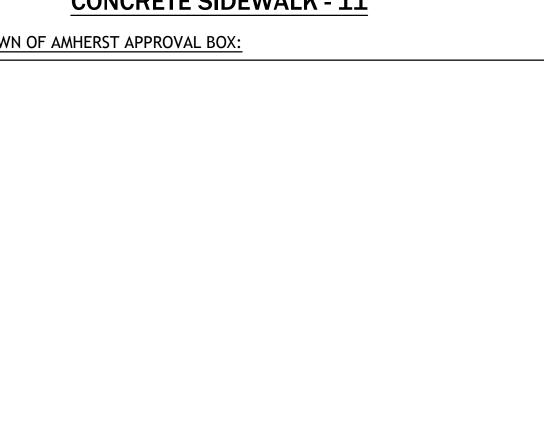

Ë $\mathbf{\Omega}$



DRAWING NAME: Site Details

Drawn By: DRAWING NO.


Date:


Scale:

11/19/24

C. Wood

As Noted

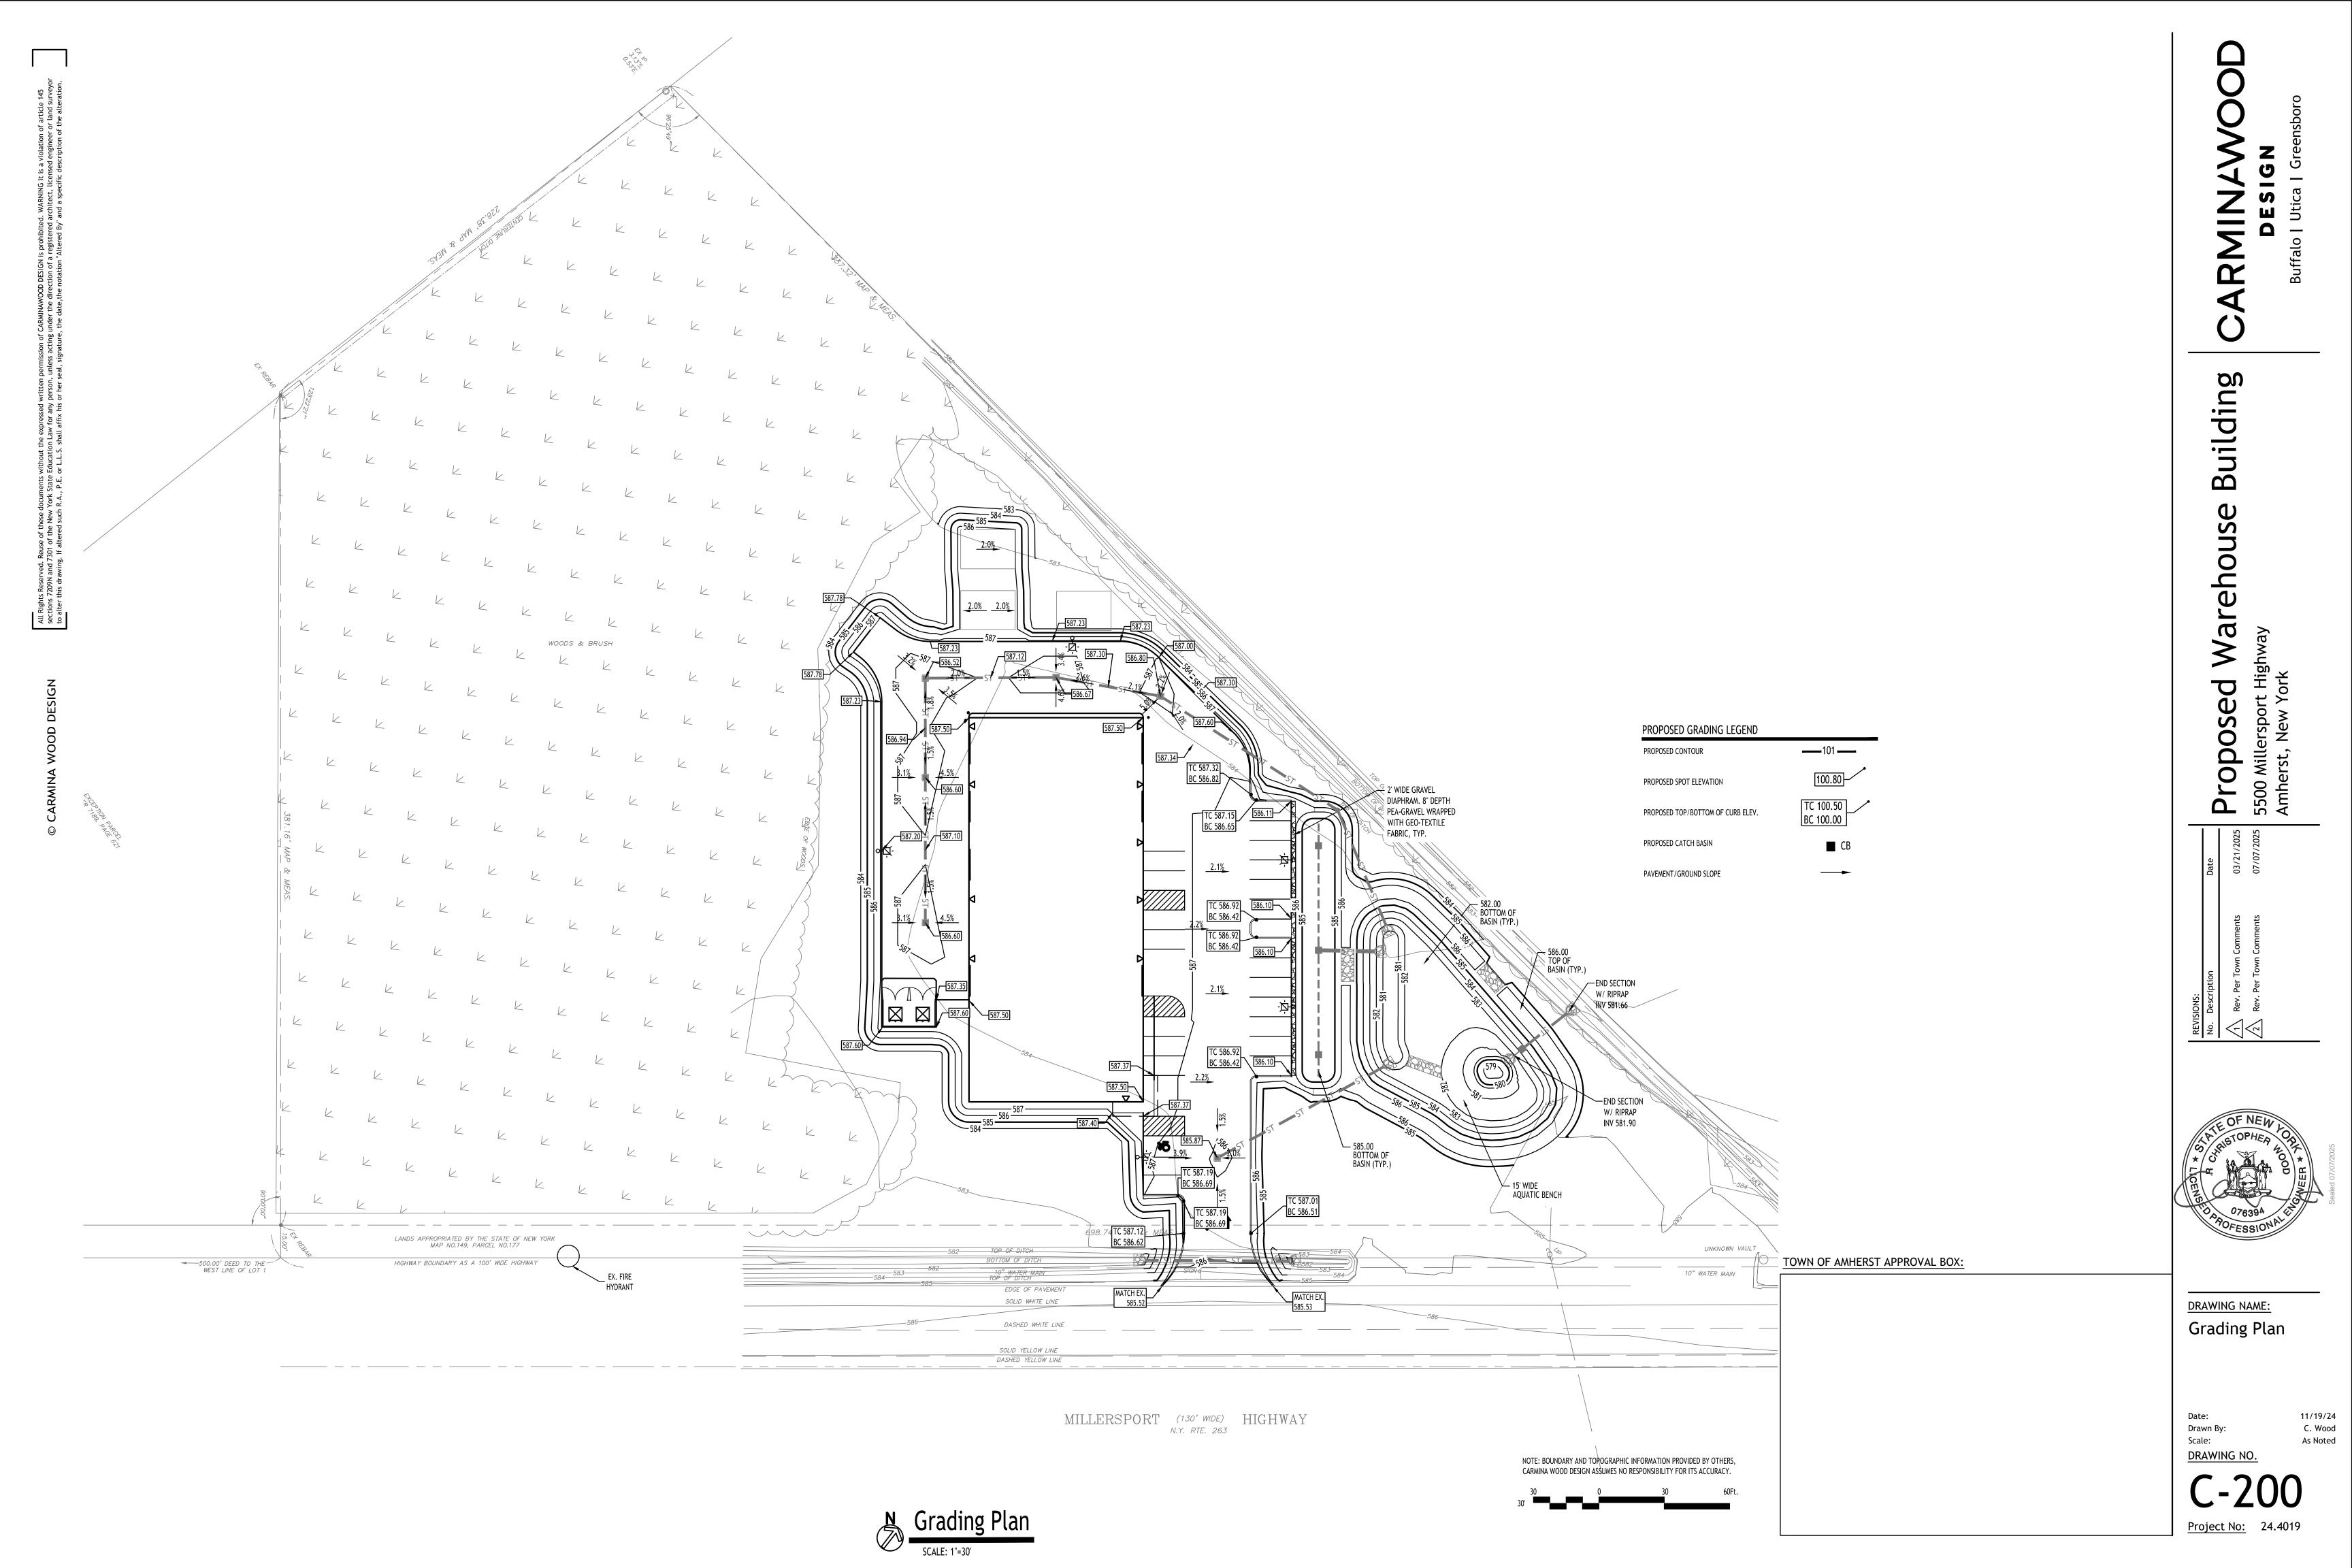

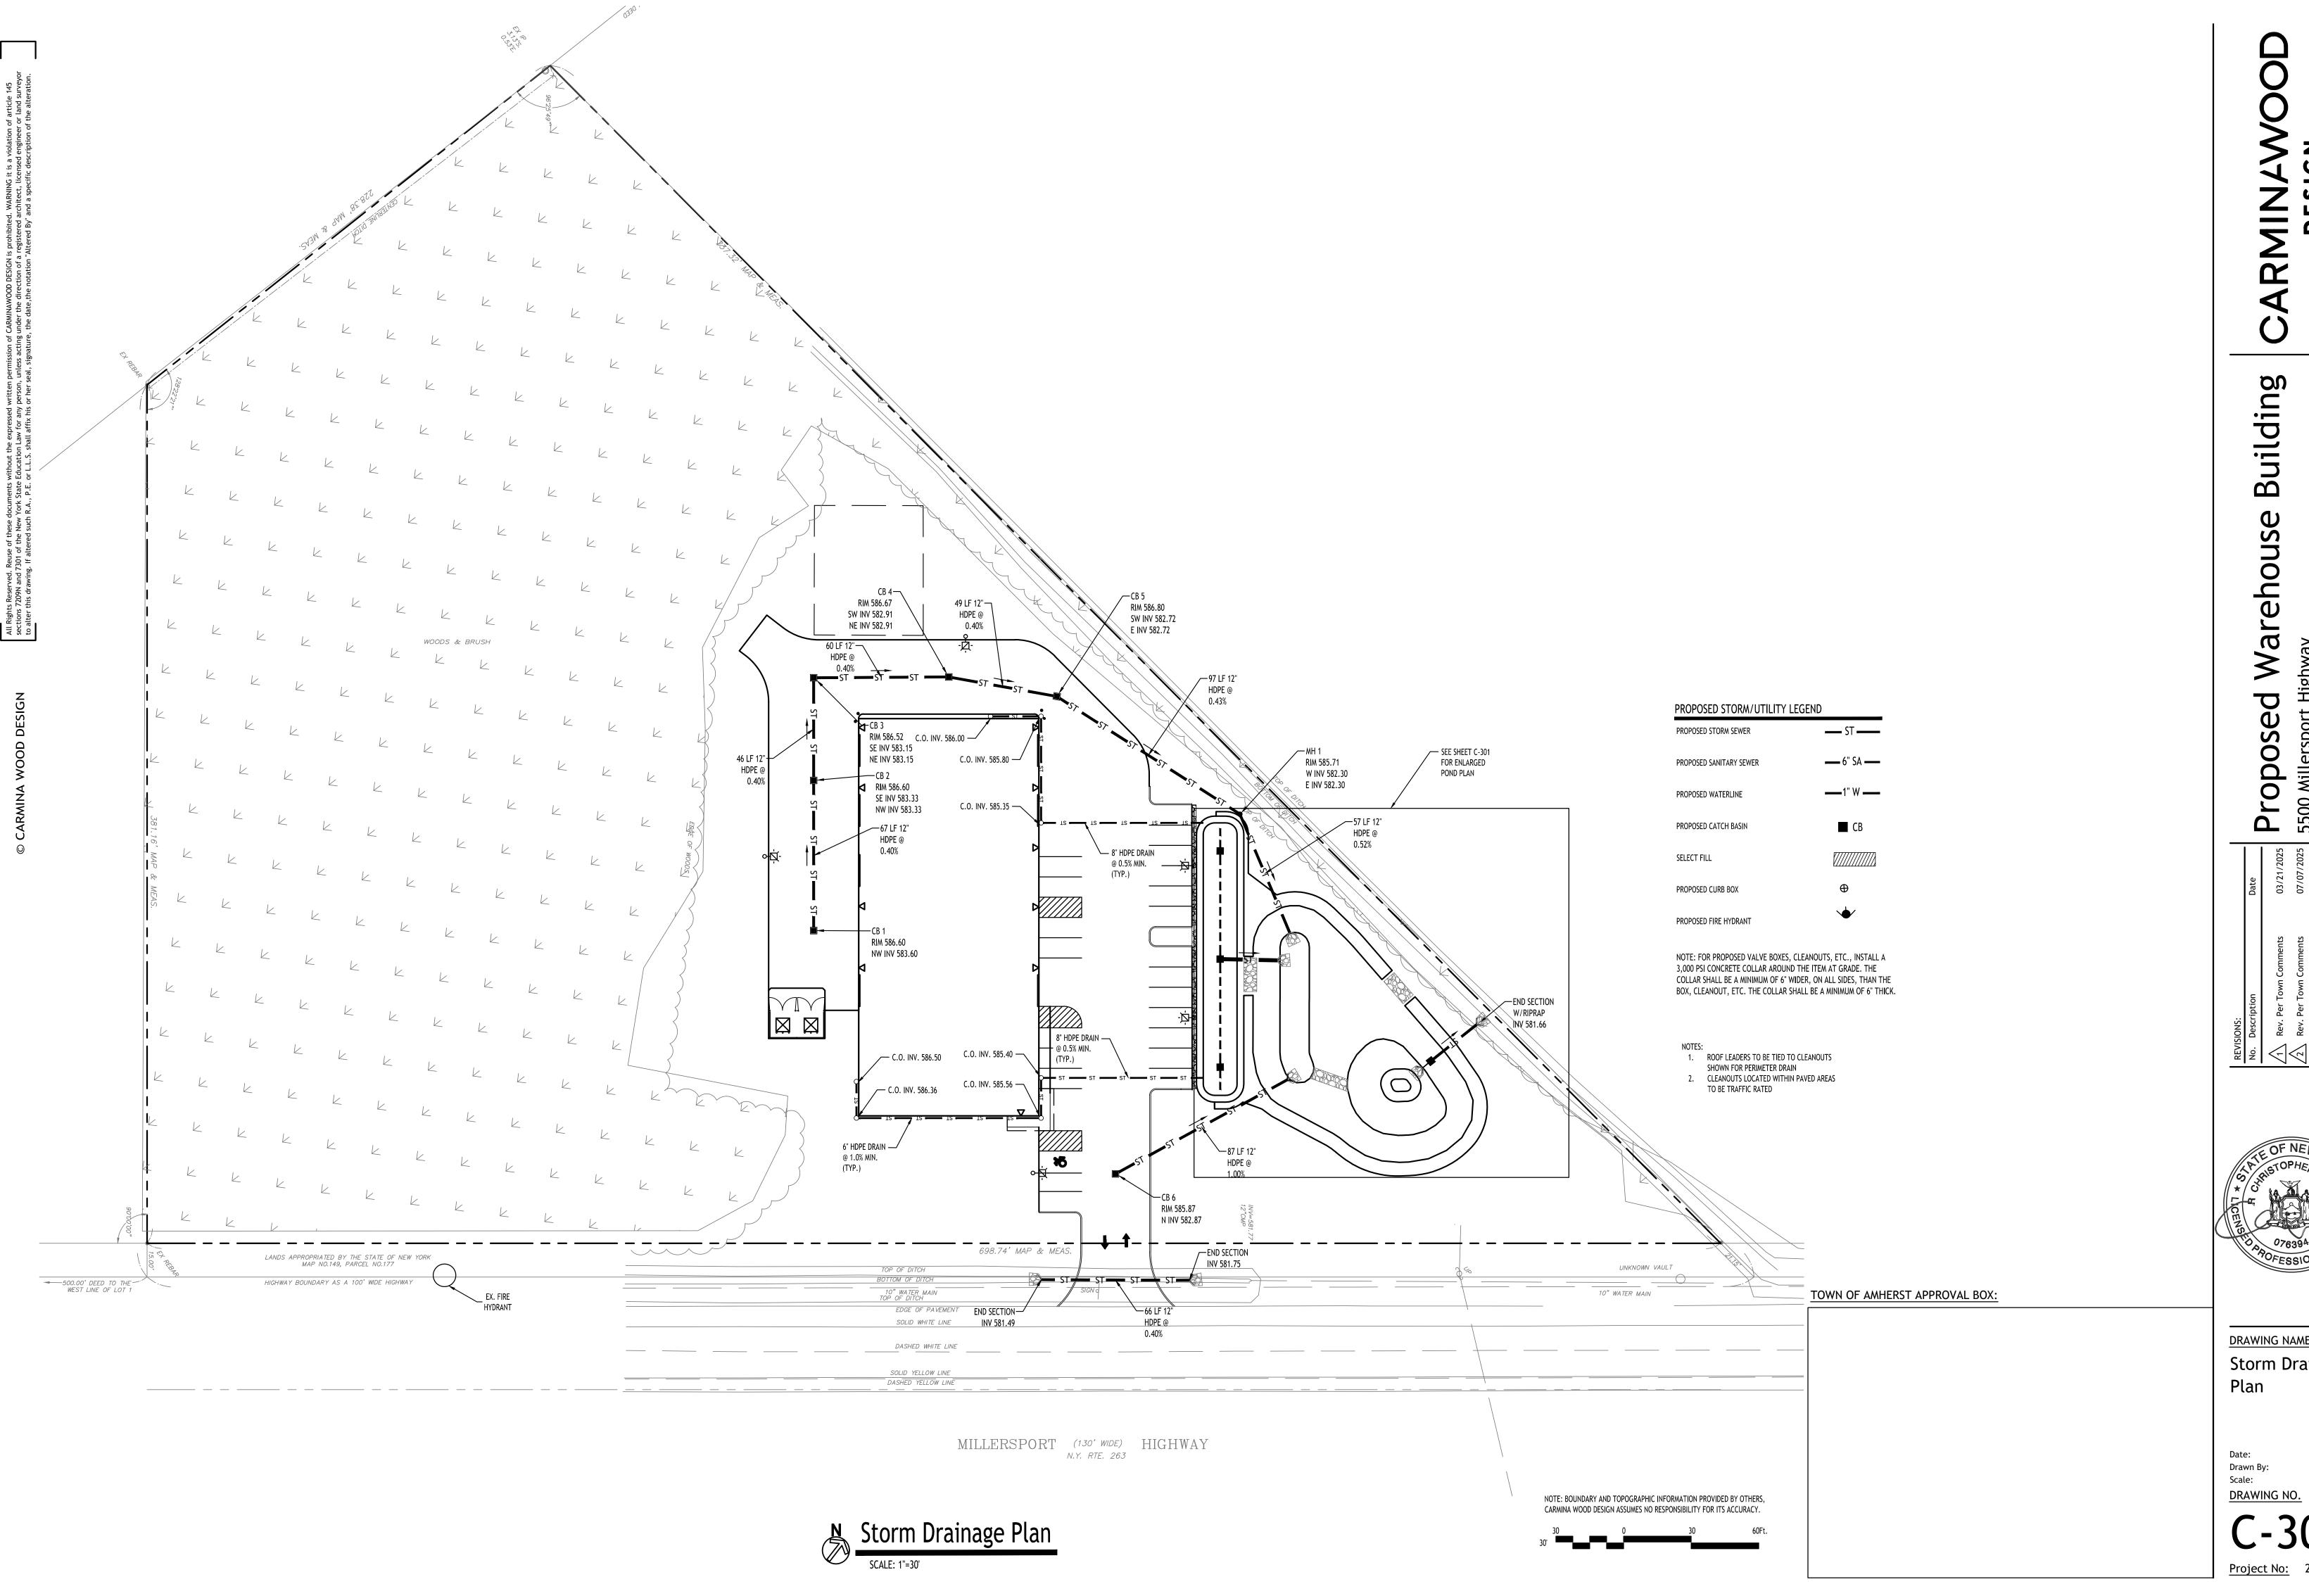




DRAWING NAME: Storm Drainage

As Noted

11/19/24 C. Wood

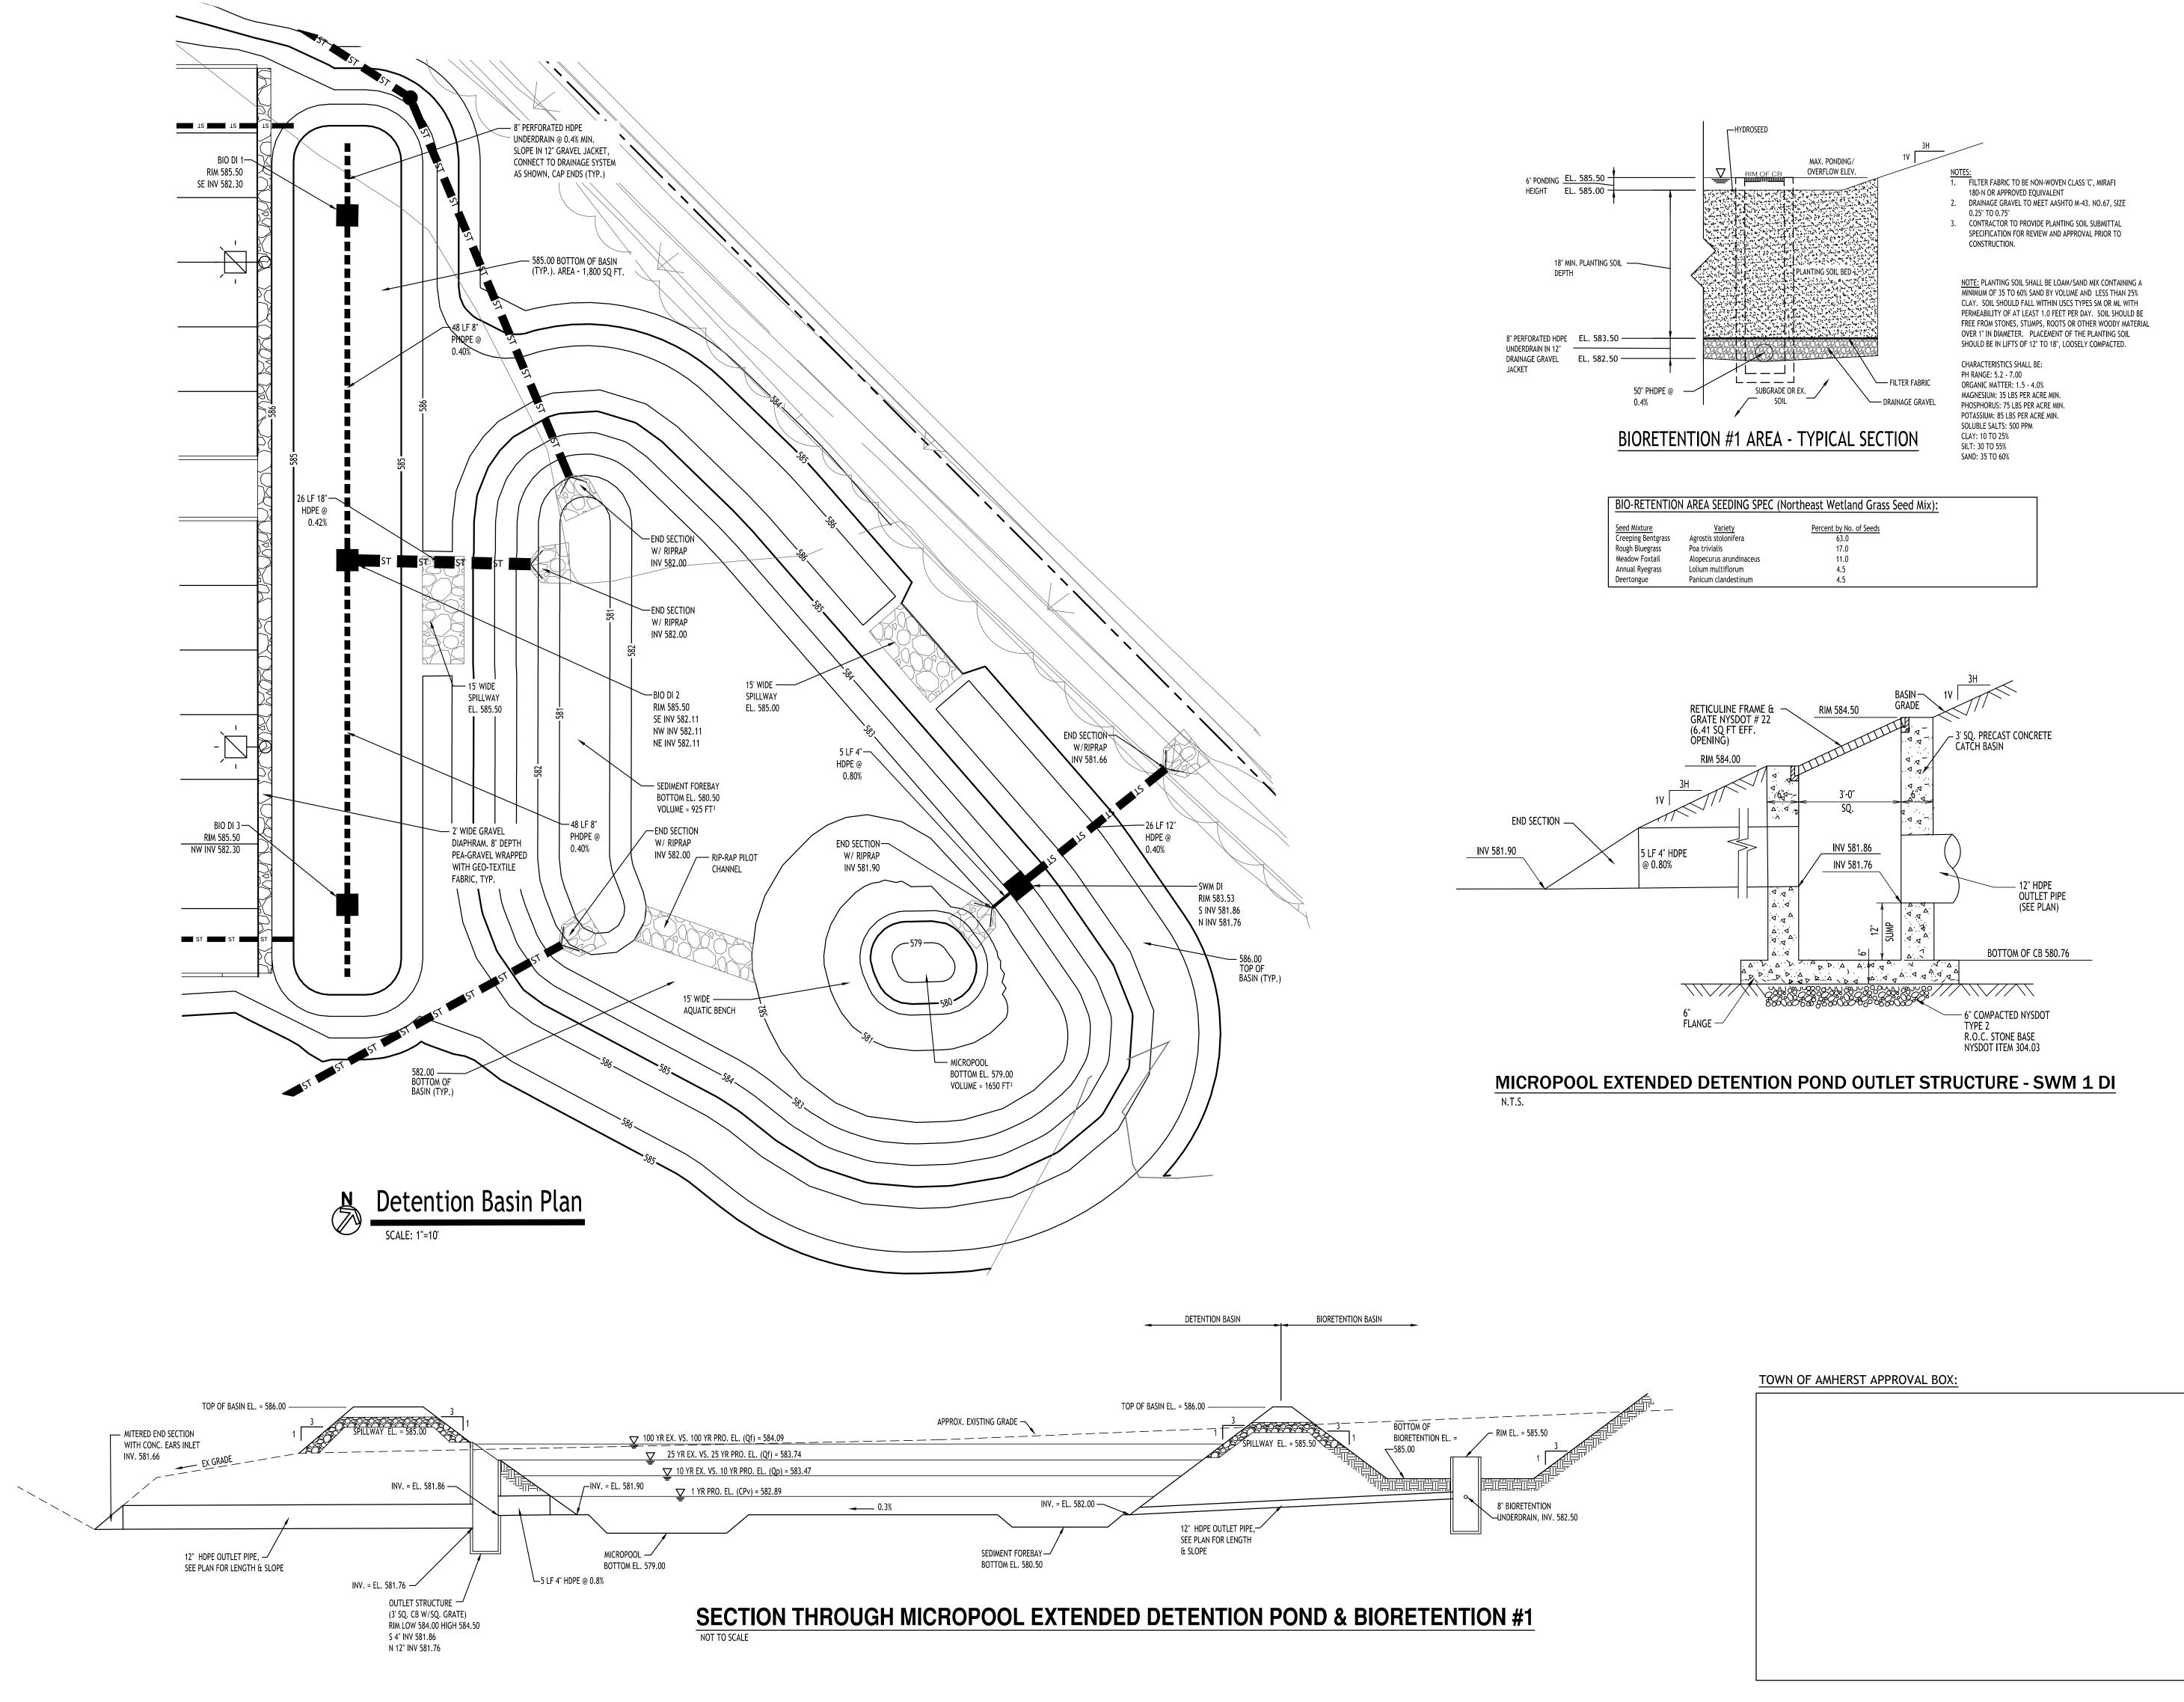

 $\mathbf{\Omega}$

DRAWING NAME: Basin

Details

Date: Drawn By: Scale:

DRAWING NO.

11/19/24

C. Wood

- EXPANSION JOINT

SEE PLANS FOR

SEWER SIZES

4" Ø PERFORATED HDPE DRAIN PIPE, EXTEND 5' FROM CB, CAP END PIPE SHALL

BE SURROUNDED WITH 4" MIN. NYSDOT NO.1 WASHED STONE OR GRAVEL ON

ALL SIDES, SLOPE OF PIPE SHALL MATCH SUBGRADE SLOPE (TYP. ON 4 SIDES OF CB, NOT REQUIRED ON SIDES WHERE PIPES ENTERING/EXITING HAVE 2' OR

- 6" FOR IN-LINE CLEAN-OUT 8" FOR END OF LINE LAMPHOLE

WITH FIBERBOARD

4000 PSI CONCRETE ENCASE

TO FULL DEPTH OF FRAME

EXTERIOR CLEANOUT @ GRADE — J.R. SMITH #4251-U W/ VANDAL-

PROOF SCREWS OR APPROVED EQUAL

TOP COURSE

STONE BASE

SELECT FILL

HEAVY DUTY FRAME

AND GRATE, NEENAH

R4832B, HS20-44,

BICYCLE PROOF

TOP OF PAVEMENT

PRECAST CONCRETE

UNDISTURBED

EARTH

CATCH BASIN UNIT,

KISTNER CB-2436 OR EQUAL

FLOW ----

FRAME OD + 2'

(SEE PLAN), PROVIDE

RISER SECTIONS TO

ACHIEVE RIM ELEV.

INVERT ELEV. VARIES

*NOTE: USE UP TO 18" PIPE, FOR LARGER PIPES USE STORM MH, SEE DETAIL

TYPICAL PRECAST CATCH BASIN

NOT TO SCALE

SEE PLAN

LAMPHOLE/CLEANOUT IN PAVEMENT/SIDEWALK

NOT TO SCALE

TOWN OF AMHERST APPROVAL BOX:

- LESS COVER)

PAVEMENT SUBBASE

FABRIC, TYPAR OR EQUAL

- 6" COMPACTED NYSDOT TYPE 2 R.O.C. STONE BASE

NYSDOT ITEM 304.12

STORM PIPE-

SIZE VARIES (SEE PLAN)

SURROUND STONE WITH GEOTEXTILE DRAINAGE

BINDER

uil $\mathbf{\Omega}$

DRAWING NAME: Storm Drainage **Details**


Date: Drawn By: Scale:

DRAWING NO.

As Noted

11/19/24

C. Wood

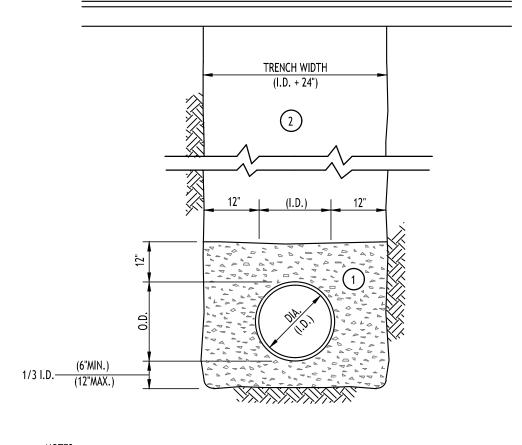

- A. PIPE INSTALLATION SHALL BE IN ACCORDANCE WITH MANUFACTURERS RECOMMENDATIONS.
- B. TRENCHING OPERATIONS SHALL INCLUDE ALL NECESSARY DEWATERING.
- C. TRENCH DETAILS ARE ONLY SHOWN FOR PURPOSES OF MATERIAL PLACEMENT AND MAXIMUM PAY LIMITS.
- D. AN OSHA APPROVED MOVABLE PROTECTIVE TRENCH SHIELD SHALL BE USED IN ALL UNSHEETED TRENCH AREAS.

PIPE BEDDING MATERIAL (NYSDOT 1985 EDITION)

- NO. 1 CRUSHED STONE OR CRUSHED GRAVEL WITH A GRADATION CONFORMING WITH NYSDOT SECTION 703-02. THE MATERIAL SHALL BE WELL GRADED WITH NO PARTICLES LARGER THAN ONE INCH AND HAVING A MAXIMUM GRADATION MEETING THE LIMITS DESCRIBED IN THE SPECIFICATIONS. THE BEDDING SHALL BE COMPACTED IN 6" LIFTS WITH EQUIPMENT ACCEPTABLE TO THE PIPE MANUFACTURER.
 - NO SLAG SHALL BE ALLOWED FOR MATERIAL
- TYPE 2 CRUSHED STONE OR CRUSHED GRAVEL WITH A GRADATION CONFORMING WITH NYSDOT SECTION 304-2.02 TYPE 2. THE MATERIAL SHALL BE WELL GRADED WITH NO PARTICLES LARGER THAN TWO INCHES AND HAVING A MAXIMUM GRADATION MEETING THE LIMITS DESCRIBED IN THE SPECIFICATIONS. THE BEDDING SHALL BE COMPACTED IN 6" LIFTS WITH EQUIPMENT ACCEPTABLE TO THE PIPE

STORM SEWER TRENCH SECTION

IN PAVED AREAS

NOT TO SCALE

NO SLAG SHALL BE ALLOWED FOR MATERIAL

TOP OF PIPE ZONE

__6" TOPSOIL (MIN.)

A. PIPE INSTALLATION SHALL BE IN ACCORDANCE WITH MANUFACTURERS RECOMMENDATIONS.

- B. TRENCHING OPERATIONS SHALL INCLUDE ALL NECESSARY DEWATERING.
- C. TRENCH DETAILS ARE ONLY SHOWN FOR PURPOSES OF MATERIAL PLACEMENT AND MAXIMUM PAY LIMITS.
- D. AN OSHA APPROVED MOVABLE PROTECTIVE TRENCH SHIELD SHALL BE USED IN ALL UNSHEETED TRENCH AREAS.

PIPE BEDDING MATERIAL (NYSDOT 1985 EDITION)


NO. 1 CRUSHED STONE OR CRUSHED GRAVEL WITH A GRADATION CONFORMING WITH NYSDOT SECTION 703-02. THE MATERIAL SHALL BE WELL GRADED WITH NO PARTICLES LARGER THAN ONE INCH AND HAVING A MAXIMUM GRADATION MEETING THE LIMITS DESCRIBED IN THE SPECIFICATIONS. THE BEDDING SHALL BE COMPACTED IN 6" LIFTS WITH EQUIPMENT ACCEPTABLE TO THE PIPE MANUFACTURER.

STORM SEWER TRENCH SECTION

IN UNPAVED AREAS


NOT TO SCALE

NO SLAG SHALL BE ALLOWED FOR MATERIAL BACKFILL MATERIAL SHALL BE NATIVE SOIL CONTAINING NO UNSUITABLE MATERIAL COMPACTED IN 6" LIFTS.

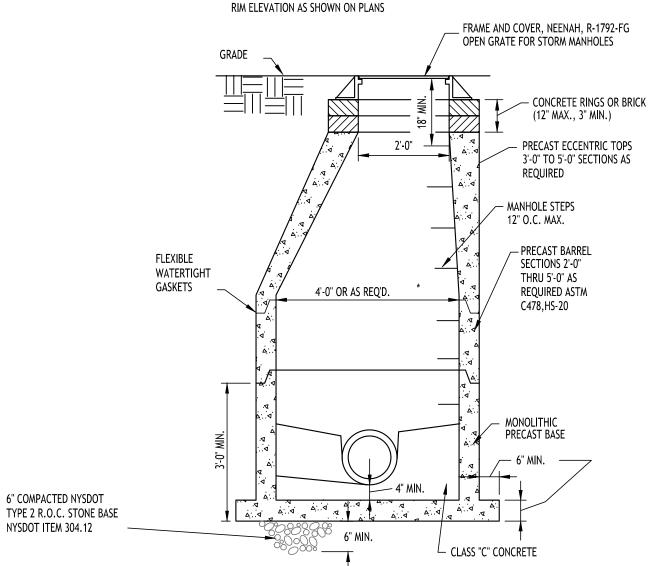

* USE 5' DIAMETER MANHOLE FOR 42" & 48" PIPES

TYPICAL STORM MANHOLE DETAIL

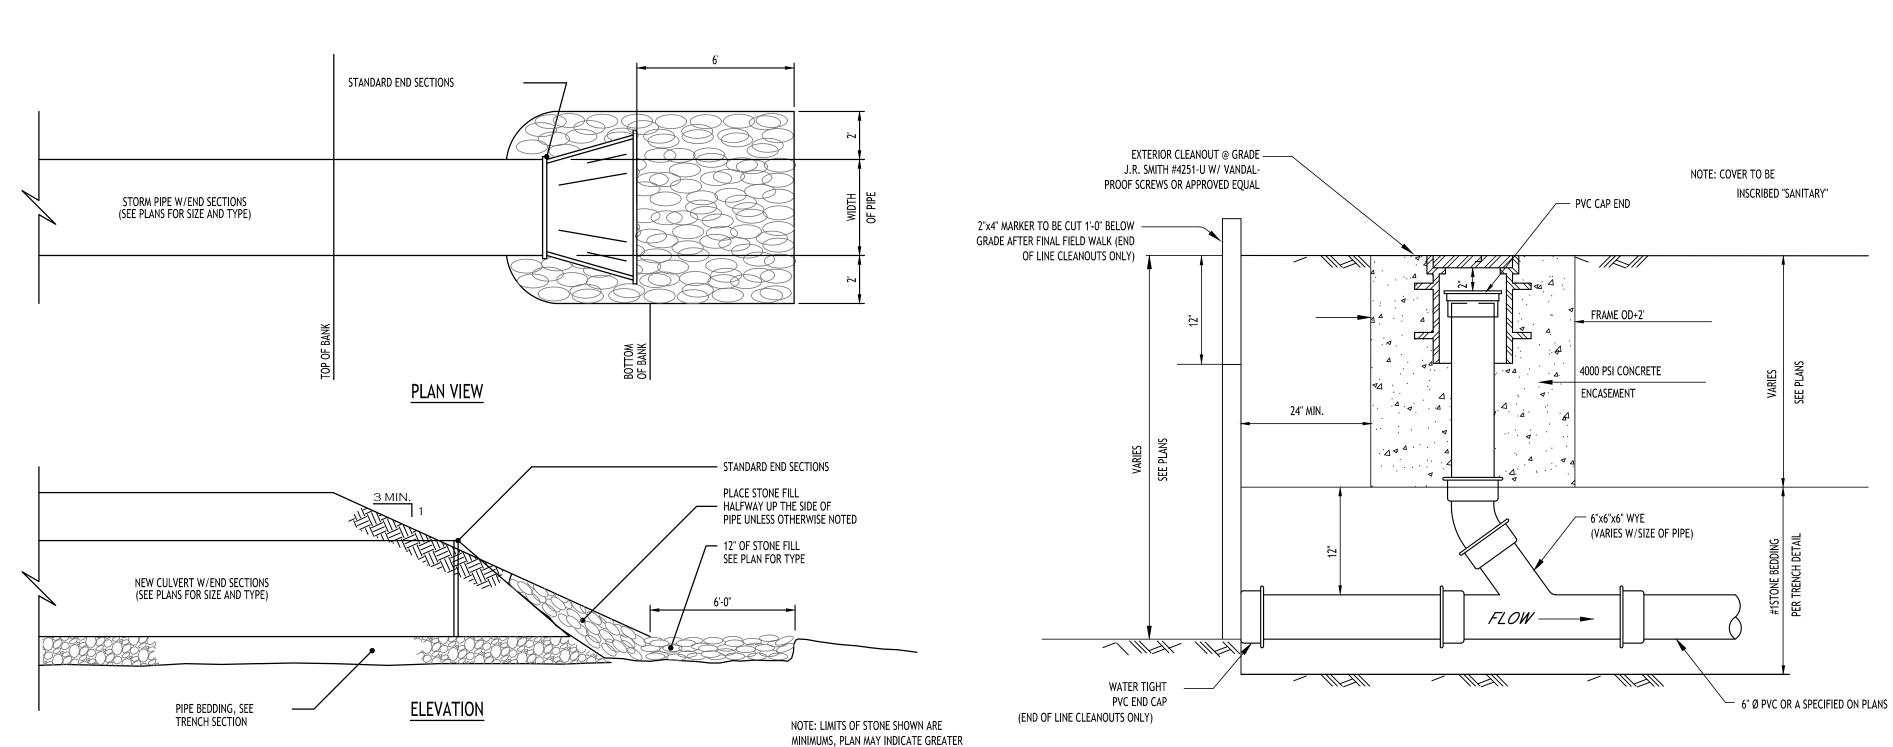


LAMPHOLE/CLEANOUT IN LAWN/FIELD AREAS NOT TO SCALE

6" COMPACTED NYSDOT

NYSDOT ITEM 304.12

TYPICAL PIPE OUTLET W/ END SECTION & RIP RAP

NOT TO SCALE

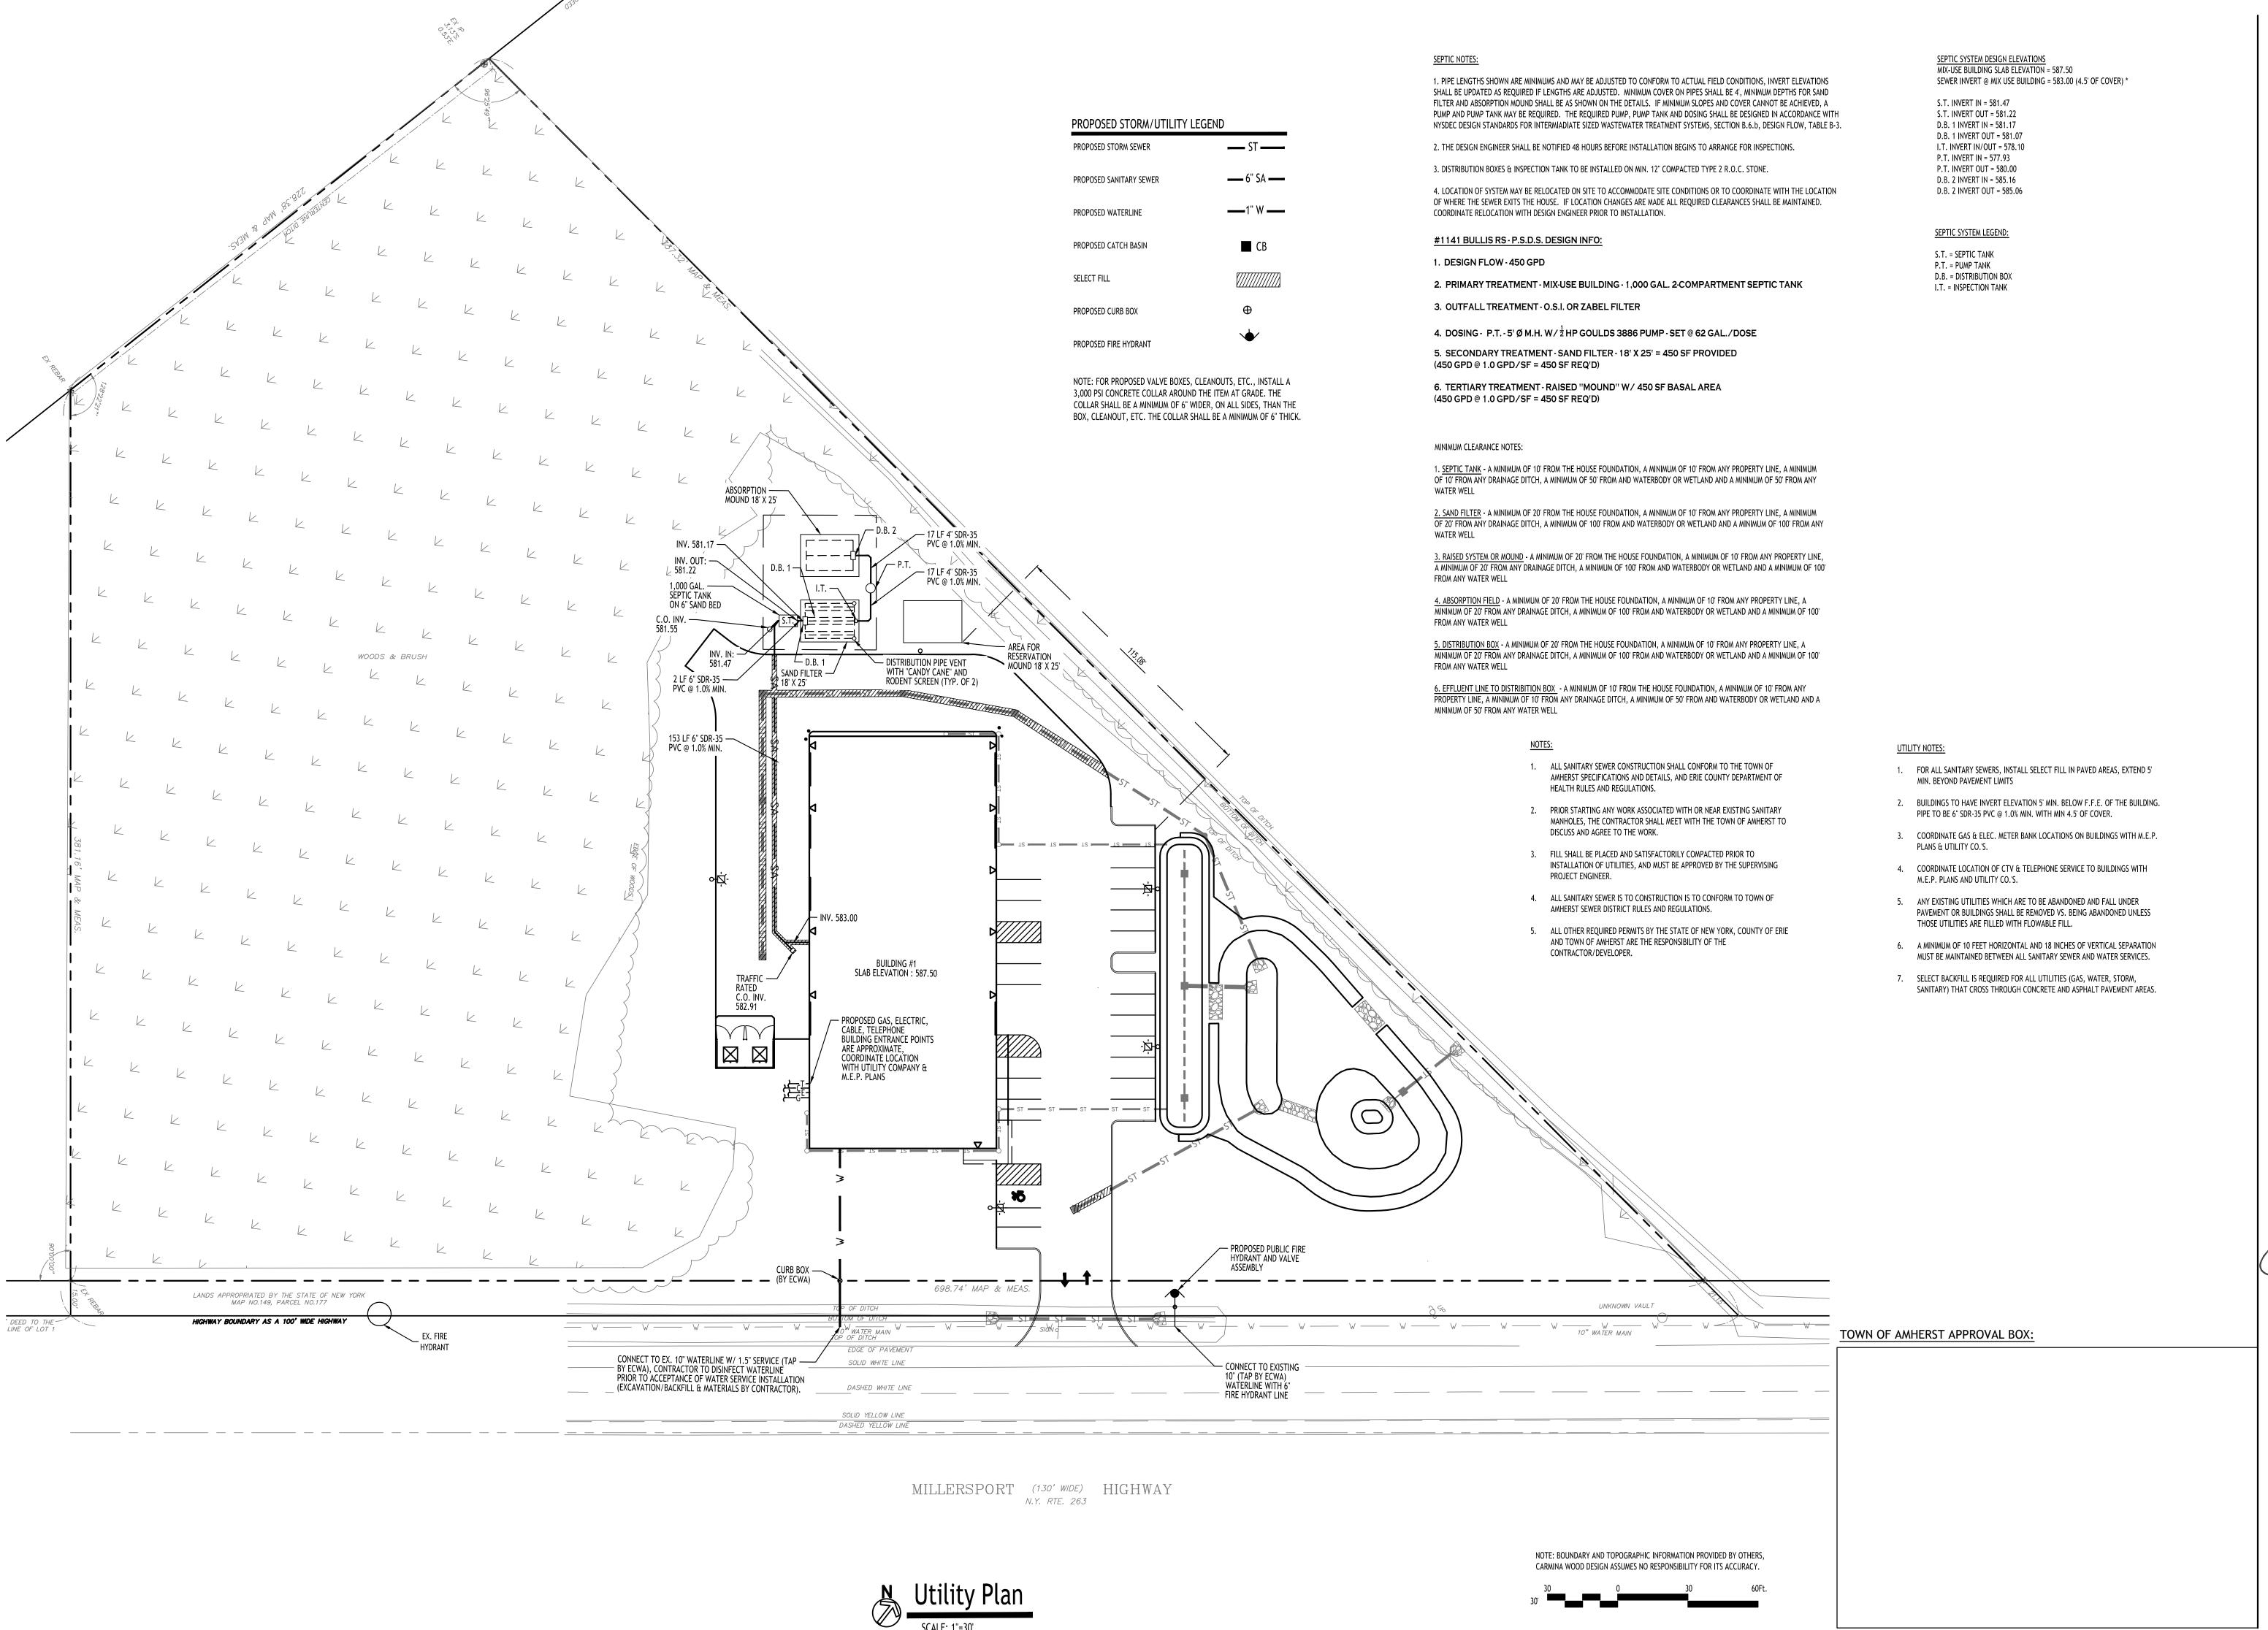

M


DRAWING NAME: **Utility Plan**

Date: Drawn By: Scale: DRAWING NO.


As Noted

11/19/24

C. Wood

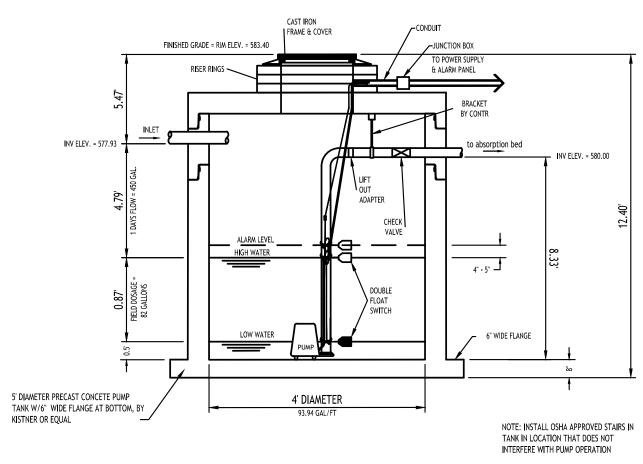

PUMP TANK

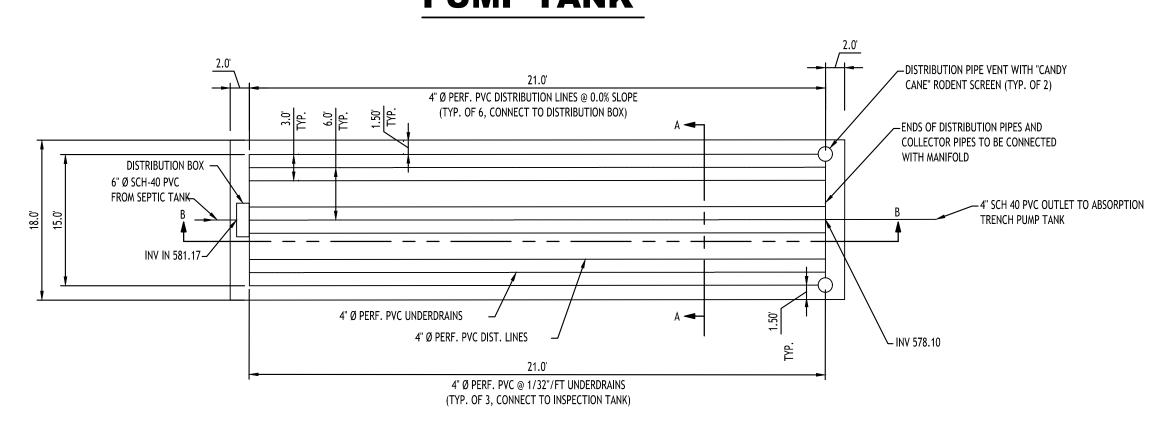

SAND FILTER PLAN


1. ALL SAND SHALL BE UNIFORM COARSE TO MEDIUM SAND (< 4% PASSINF #200 SIEVE), ALL PASSING 1/4 INCH SIEVE, HAVE A EFFECTIVE GRAIN SIZE (EGS) BETWEEN 0.25 - 1.00 mm, AN UNIFORMITY COEFFICIENT (UC) <= 4

2. IF A HDPE LINER IS USED, SEAL PENETRATIONS AND SEAMS WATER TIGHT

3. TOP OF SAND FILTER SHALL BE SLOPED TO DRAIN, AREAS AROUND THE FILTER SHALL BE GRADED TO DIVERT WATER AWAY

4. ALL HEAVY EQUIPMENT SHALL BE KEPT OFF THE SAND FILTER AREA FOLLOWING CONSTRUCTION.

5. depending on depth of high water mark or bedrock or the existing topography, the entire filter may be adjusted up or down. all required clearances and minimum slopes must be maintained. if adjustments are made to the filter, the engineer shall be notified prior to start of installation.

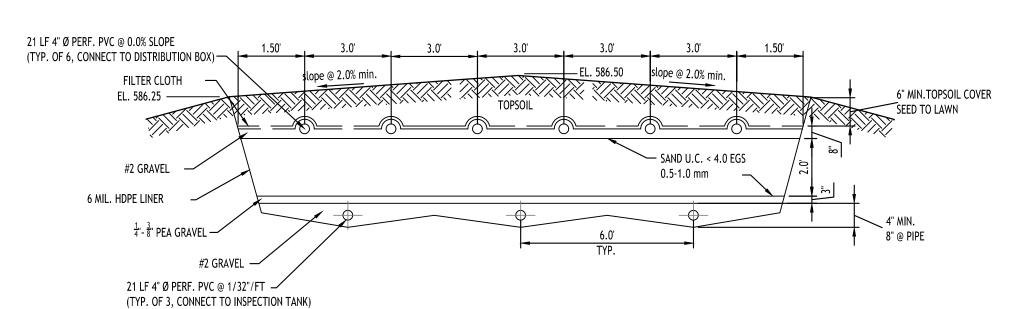

MOUND NOTES:

(SHOWN AS SIDE TO SIDE FOR ILLUSTRATION PURPOSES).

ABOVE THE HIGH GROUND WATER ELEVATION.

A. < 10% PASSING #200 SIEVE

C. < 15% PASSING 1/2 SIEVE

NOTIFIED PRIOR TO START OF INSTALLATION.

F. U.C. BETWEEN 4 - 6

AT THE GROUND SURFACE.

FOLLOWING PLOWING.

E. E.G.S. BETWEEN 0.15 - 0.30 MM

ALLOWED IN THE MOUND AREA FOLLOWING PLOWING OF THE EXISTING SOIL.

ORIENTED TO RUN PARALLEL WITH THE NATURAL SITE CONTOURS.

6. THE ABSORPTION BED SAND SHALL MEET THE FOLLOWING CRITERIA:

D. PERCOLATION RATE OF BETWEEN 5 - 30 MIN/INCH

G. TEST RESULTS TO BE SUBMITTED TO ENGINEER FOR APPROVAL

B. => 25% PASSING #35 SIEVE TO #10 SIEVE

1. TOP OF MOUND SHALL BE SLOPED TO DRAIN, AREAS AROUND THE BASE OF THE MOUND SHALL BE GRADED TO DIVERT WATER AWAY

2. SLOPE UNDER MOUND SHALL FOLLOW SLOPE OF EXISTING GRADE, EITHER SIDE TO SIDE OR LONGITUDINAL TO FACILITATE DRAINAGE

3. ALL HEAVY EQUIPMENT SHALL BE KEPT OFF THE MOUND AREA FOLLOWING CONSTRUCTION. IN ADDITION, NO EQUIPMENT SHALL BE

4. MOUND SHALL BE ELEVATED AS REQUIRED TO PROVIDE A MINIMUM OF 2' OF NATURAL SOIL ABOVE BEDROCK AND A MINIMUM OF 1'

5. THE SLOPE OF THE ORIGINAL GROUND SURFACE IN THE LOCATION OF THE MOUND SHALL NOT EXCEED 12%. THE SYSTEM SHALL BE

NOTE: ASTM C33 WASHED CONCRETE SAND WILL TYPICALLY MEET THE ABOVE SUGGESTED MOUND SAND CRITERIA AND

WILL TYPICALLY BE AVAILABLE AT MOST SAND AND GRAVEL DISTRIBUTORS; HOWEVER, THIS MATERIAL WILL OFTEN HAVE A PERC RATE

FASTER THAN THE MINIMUM OF 5 MINUTES PER INCH. THE PERCOLATION RATE SHALL BE VERIFIED AND TAKE PRECEDENCE TO THE FILL


GRADATION REQUIREMENTS WHEN A MOUND IS PLACED OVER VERY SLOW PERCOLATING SOIL TO AVOID RAPID WEEPING OF FLUIDS

7. THE NATURAL VEGETATION SHALL NOT BE SCRAPED AWAY WITH THE EXCEPTION OF TREES, STUMPS AND EXCESSIVE VEGETATION. THE

PROPOSED MOUND AREA SHALL BE PLOWED TO A DEPTH OF 7" - 8" PREFERABLY WITH A DOUBLE-BOTTOM BLADE/FURROW PLOW WITH

TURNED UPSLOPE OR A BACKHOE EQUIPPED WITH PLOWING BLADES. ALL TRAFFIC SHALL BE EXCLUDED FROM THE MOUND AREA


8. DEPENDING ON DEPTH OF HIGH WATER MARK OR BEDROCK, THE ENTIRE MOUND MAY BE ADJUSTED UP OR DOWN. ALL REQUIRED

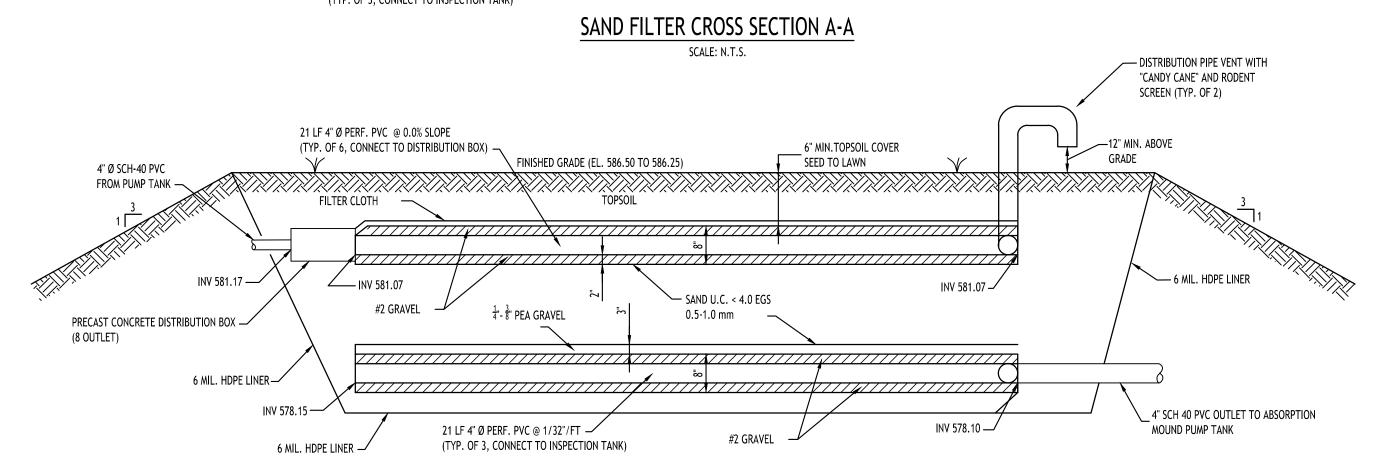

SAND FILTER SECTION B-B SCALE: N.T.S.

DISTRIBUTION BOX 4" Ø SCH-40 PVC / FROM PUMP TANK INV IN 585.16-(3) 4" DISTRIBUTION LINES @ 7.5' OC; 20' LF. @ 0.0% SLOPE (LEVEL) 6" TOPSOIL LAYER OVER ABSORPTION BED SAND -(PERC RATE 5-30 MIN./IN);


6" DEPTH UNDER DISTR. LINE GRAVEL **MOUND PLAN** SIZING CALCUALTION: DAILY FLOW = 450 GPD SCALE: NTS PERC RATE OF EX. UNDERLYING SOIL : > 60 MIN. APPLICATION RATE BASED ON PERC. RATE = 1 GPD/SF BASAL AREA REQ'D = 450 GPD / 1 GPD/SF = 450 SF BASAL AREA PROVIDED = 450 SF

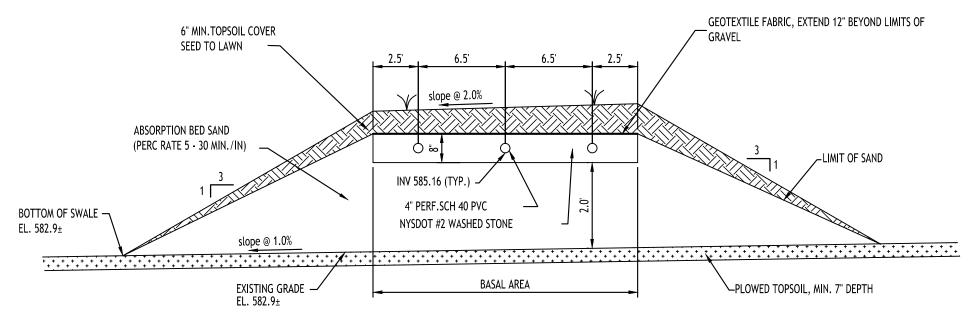

The absorption bed sand shall meet the following criteria: 1. < 10% passing #200 sieve 2. => 25% between 0.5 mm to 2.0 mm 3. Percolation rate of between 5 - 30 min/inch

MOUND SECTION B-B

SCALE: N.T.S.

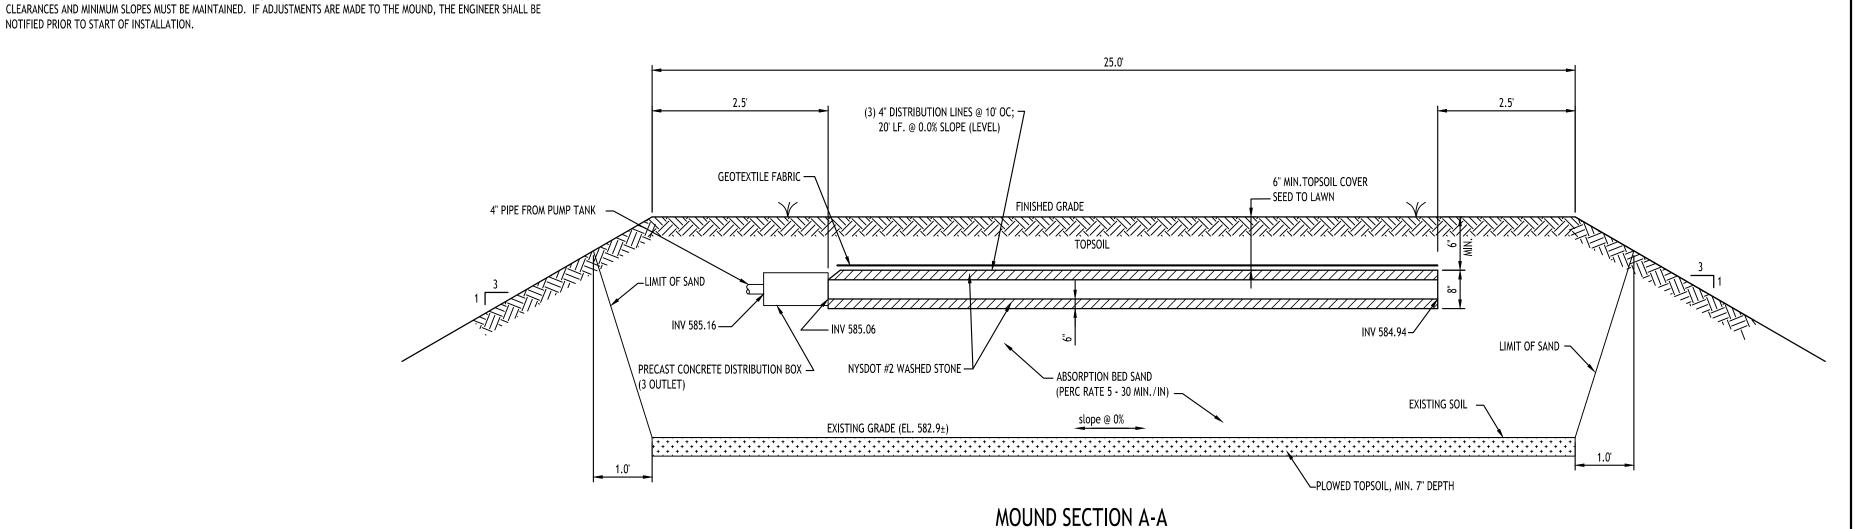

TOWN OF AMHERST APPROVAL BOX:

DRAWING NAME: **Utility Details**

Ë


 $\mathbf{\Omega}$


Date: Drawn By: Scale: DRAWING NO.


11/19/24


C. Wood

As Noted

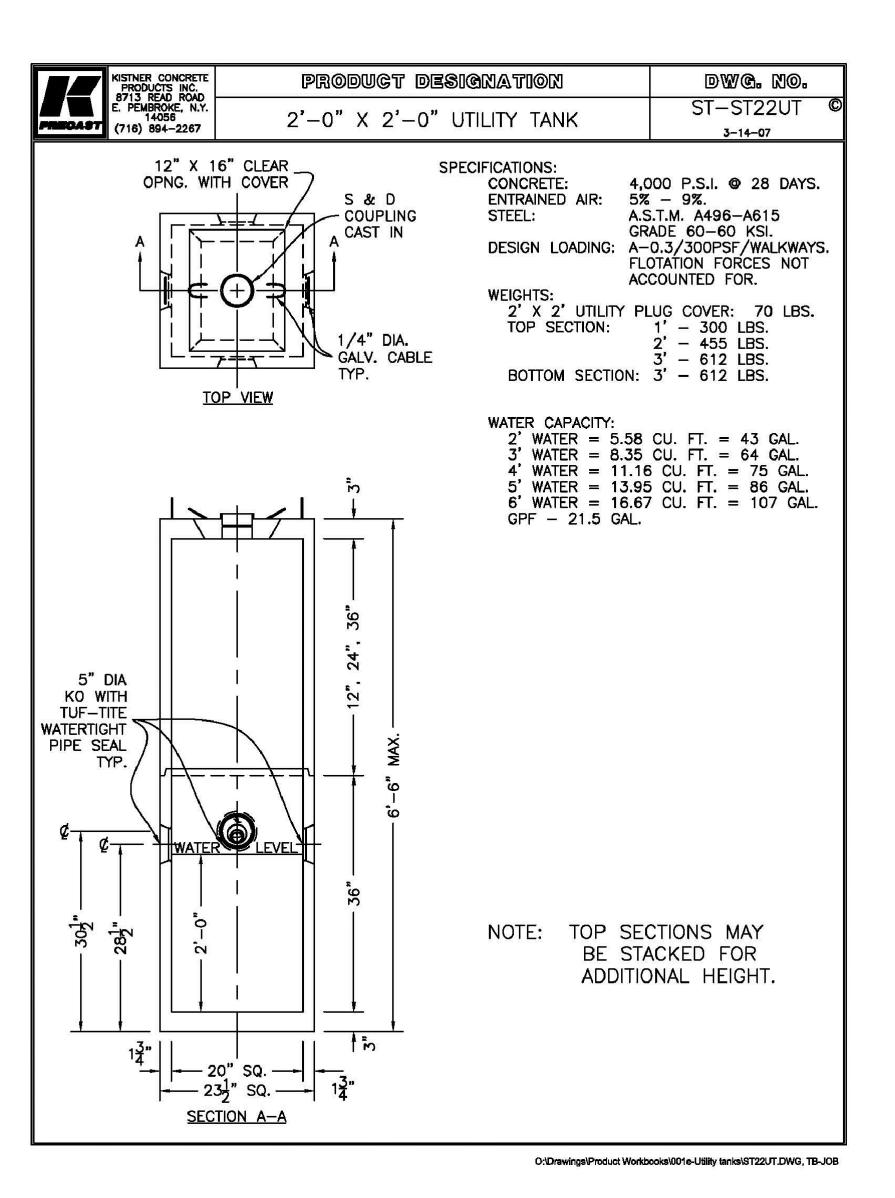

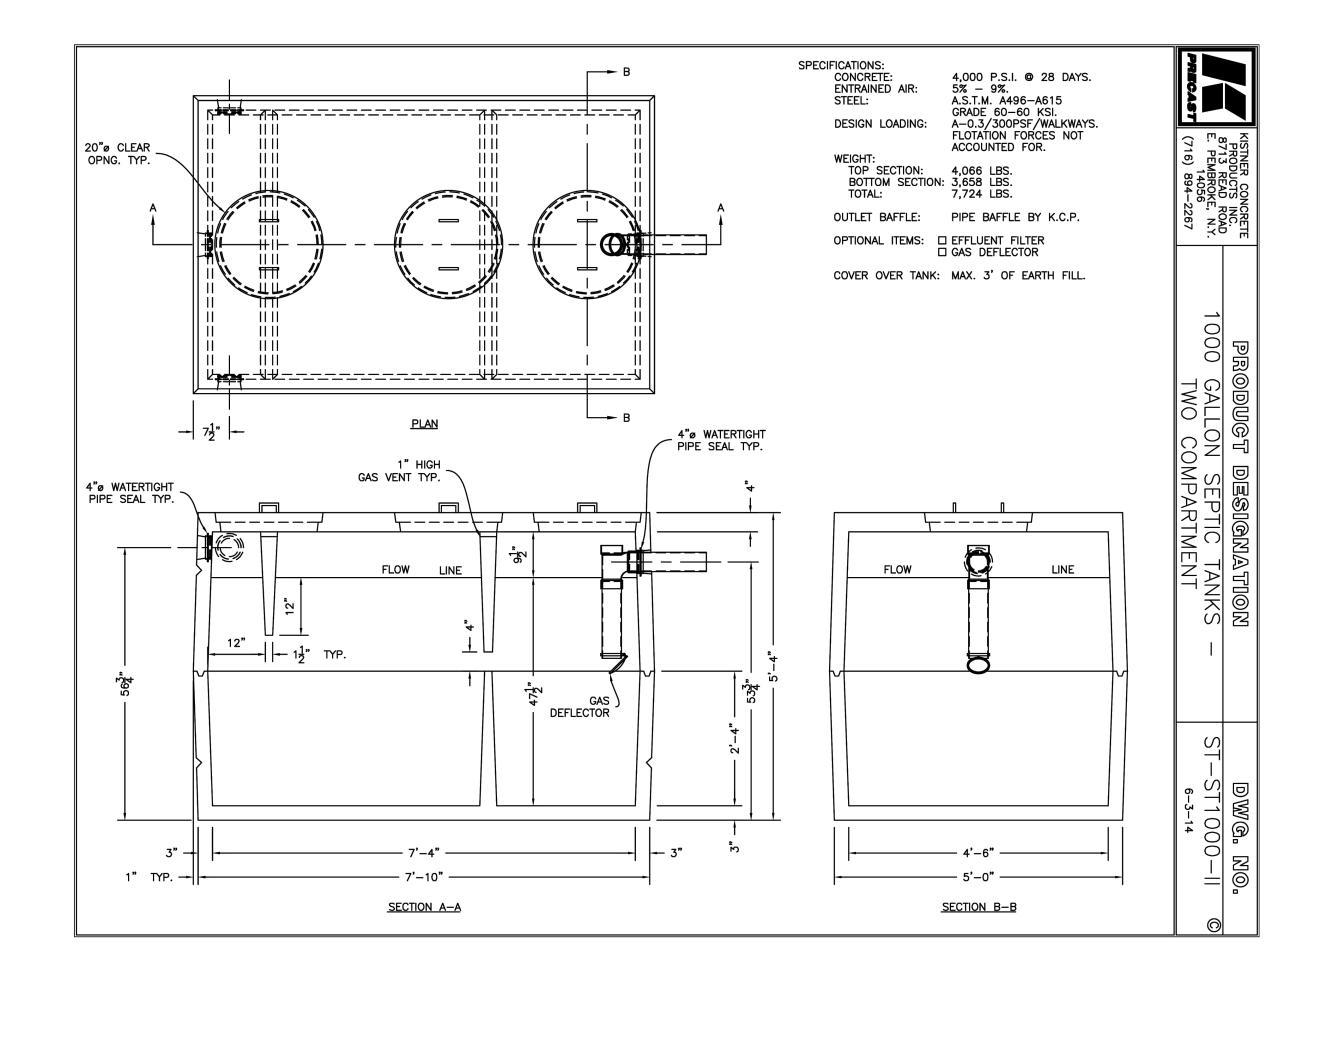

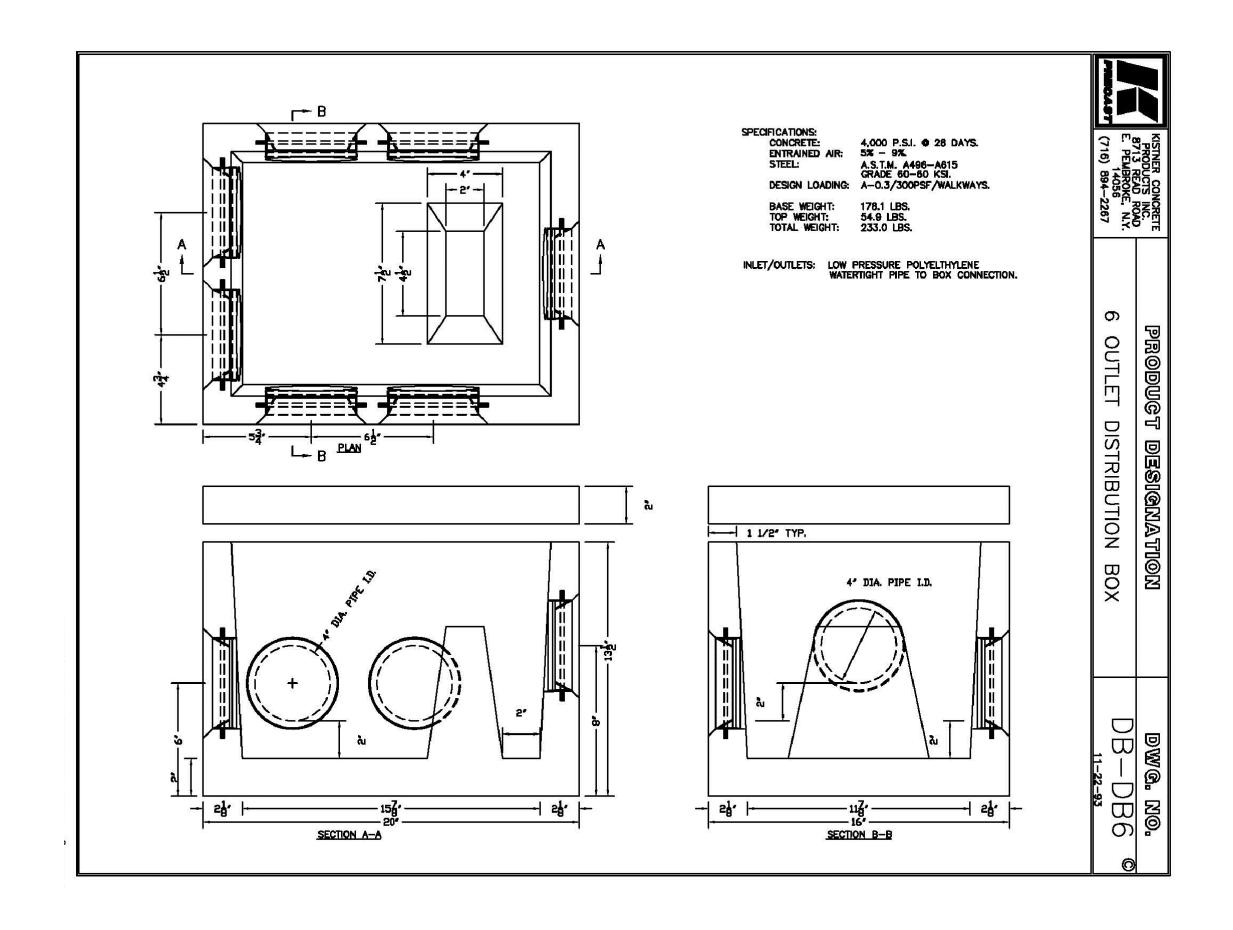

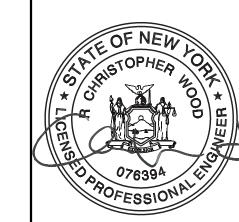

Ġ

Uil

 $\mathbf{\Omega}$

eho



DRAWING NAME: **Utility Details**

TOWN OF AMHERST APPROVAL BOX:

Drawn By:

11/19/24 C. Wood

Scale:

DRAWING NO.

SEWER/WATERLINE TRENCH SECTION

DETECTABLE TAPE 1'-6" BELOW FINISHED GRADE

__6" TOPSOIL (MIN.) 1'-6" BELOW FINISHED GRADE TOP OF PIPE ZONE

A. PIPE INSTALLATION SHALL BE IN ACCORDANCE WITH MANUFACTURERS RECOMMENDATIONS.

- B. TRENCHING OPERATIONS SHALL INCLUDE ALL NECESSARY DEWATERING.
- C. TRENCH DETAILS ARE ONLY SHOWN FOR PURPOSES OF MATERIAL PLACEMENT AND MAXIMUM PAY LIMITS.
- D. AN OSHA APPROVED MOVABLE PROTECTIVE TRENCH SHIELD SHALL BE USED IN ALL UNSHEETED TRENCH AREAS.


PIPE BEDDING MATERIAL (NYSDOT 1985 EDITION)

(1) NO. 1 CRUSHED STONE OR CRUSHED GRAVEL WITH A GRADATION CONFORMING WITH NYSDOT SECTION 703-02. THE MATERIAL SHALL BE WELL GRADED WITH NO PARTICLES LARGER THAN ONE INCH AND HAVING A MAXIMUM GRADATION MEETING THE LIMITS DESCRIBED IN THE SPECIFICATIONS. THE BEDDING SHALL BE COMPACTED IN 6" LIFTS WITH EQUIPMENT ACCEPTABLE TO THE PIPE

NO SLAG SHALL BE ALLOWED FOR MATERIAL


(2) BACKFILL MATERIAL SHALL BE NATIVE SOIL CONTAINING NO UNSUITABLE MATERIAL COMPACTED IN 6" LIFTS.


SEWER/WATERLINE TRENCH SECTION IN UNPAVED AREAS

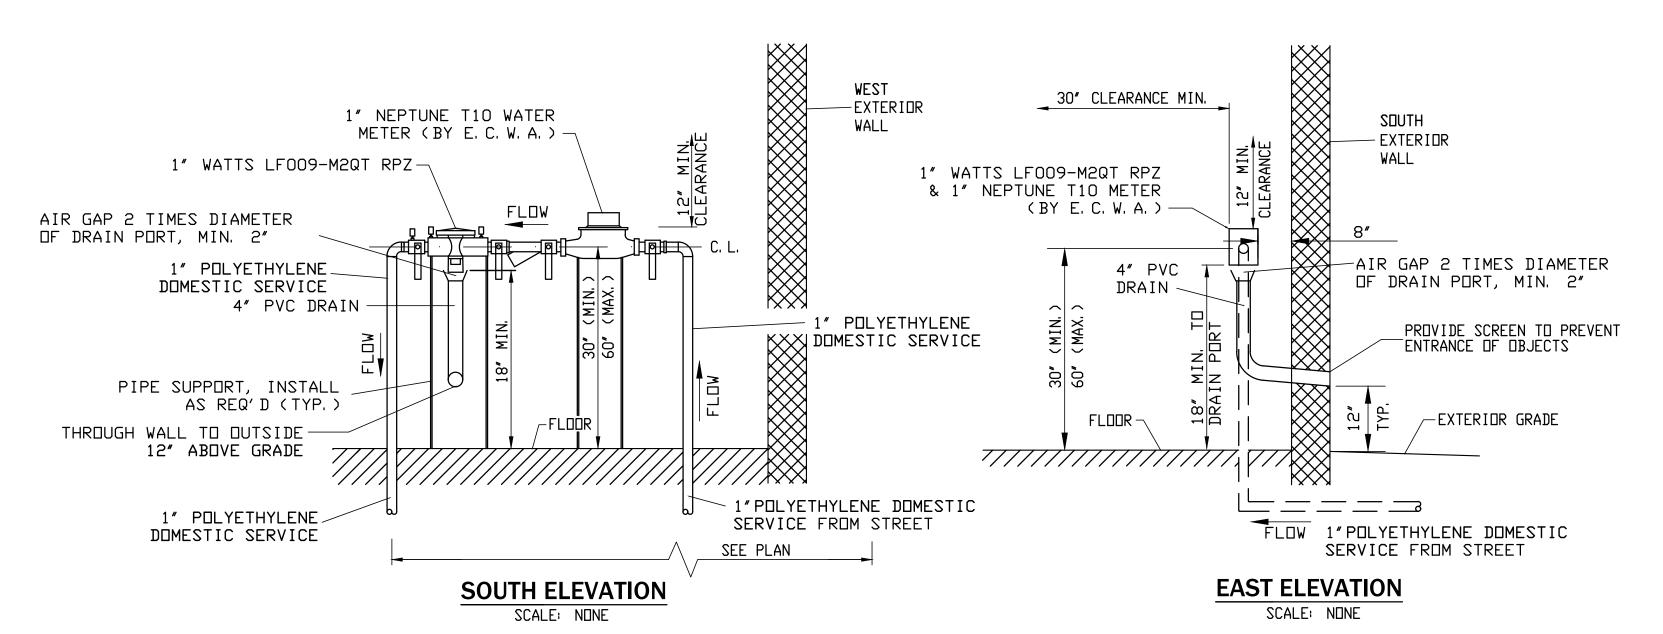

1.5" DOMESTIC SERVICE BACKFLOW PREVENTER **INSTALLATION**

1. NO TAPS TO BE MADE UPSTREAM OF RPZ & METER.
2. HEAT, LIGHT AND ELECTRIC TO BE PROVIDED AT RPZ LOCATION. 3. COORDINATE LOCATION WITH ARCHITECTURAL PLANS.

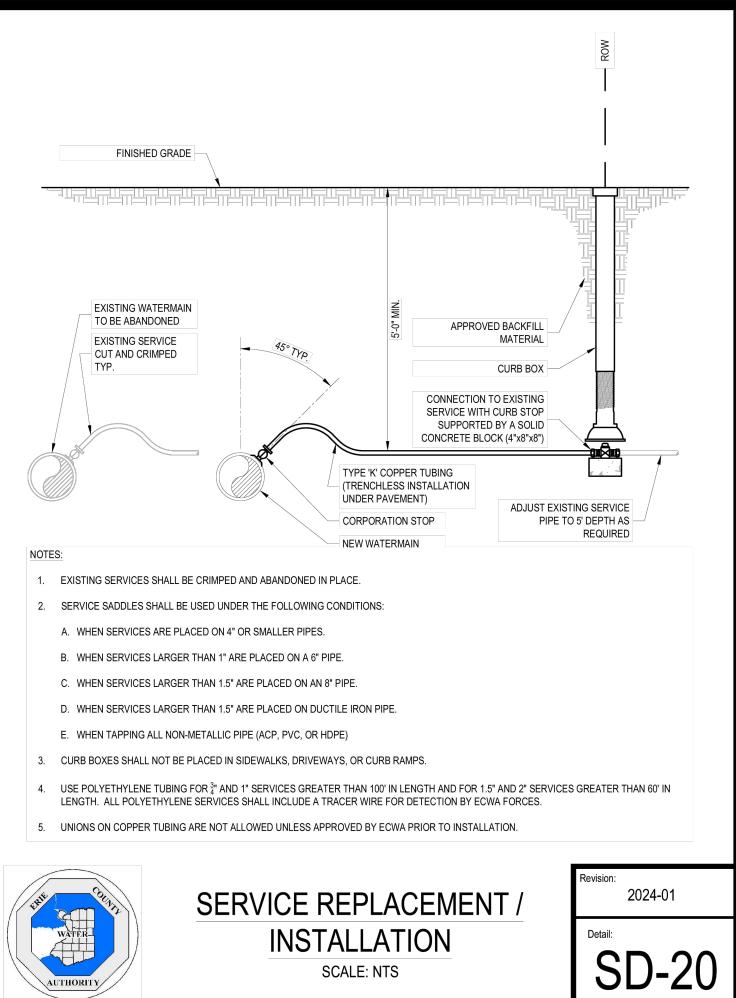

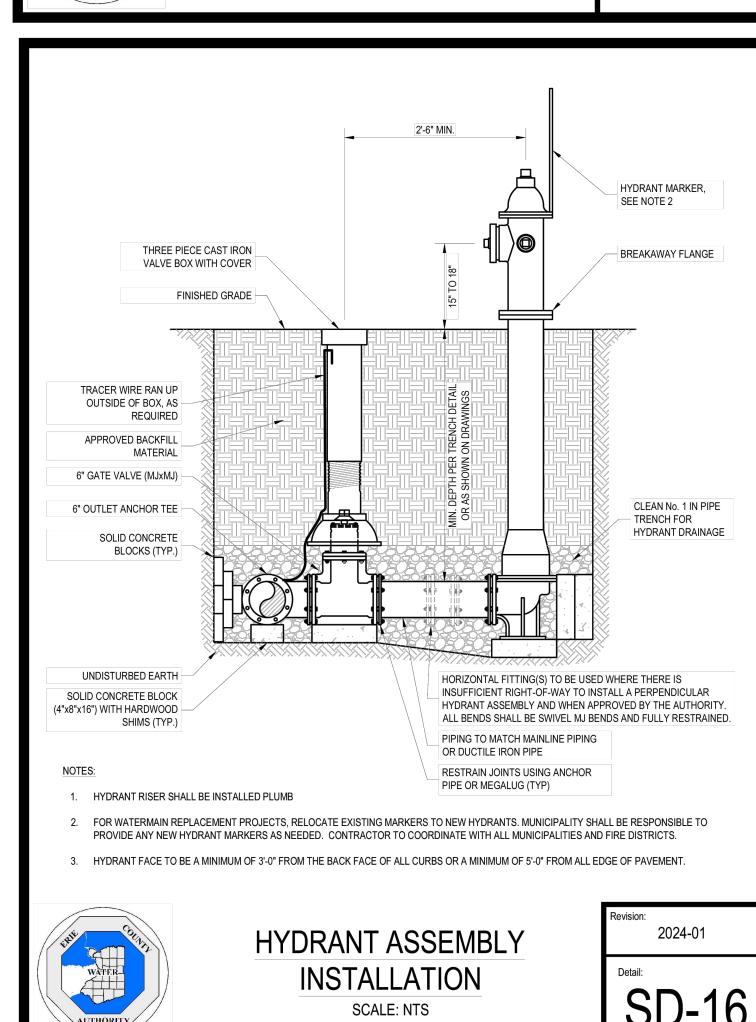



TOWN OF AMHERST APPROVAL BOX:

DRAWING NAME: **Utility Details**

Drawn By: Scale: DRAWING NO.

As Noted

11/19/24 C. Wood

rehous

TOWN OF AMHERST APPROVAL BOX:


Date: Drawn By:

As Noted DRAWING NO.

C. Wood Scale:

11/19/24

TYPICAL COMMERCIAL SERVICE WITHOUT BASEMENT DETAIL

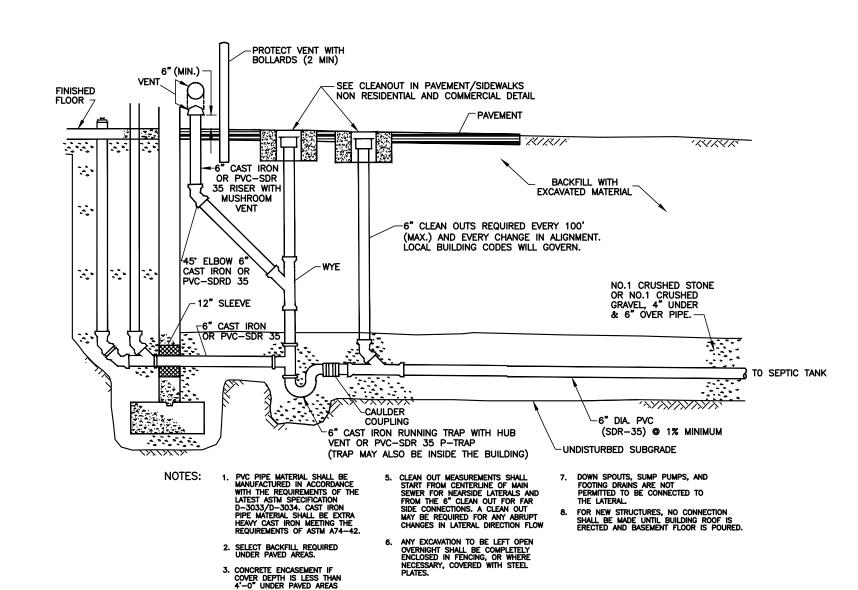

- EXPANSION JOINT

WITH FIBERBOARD


- SEE PLANS FOR

SEWER SIZES

— 6" FOR IN-LINE CLEAN-OUT 8" FOR END OF LINE LAMPHOLE

- 4000 PSI CONCRETE ENCASE TO FULL DEPTH OF FRAME



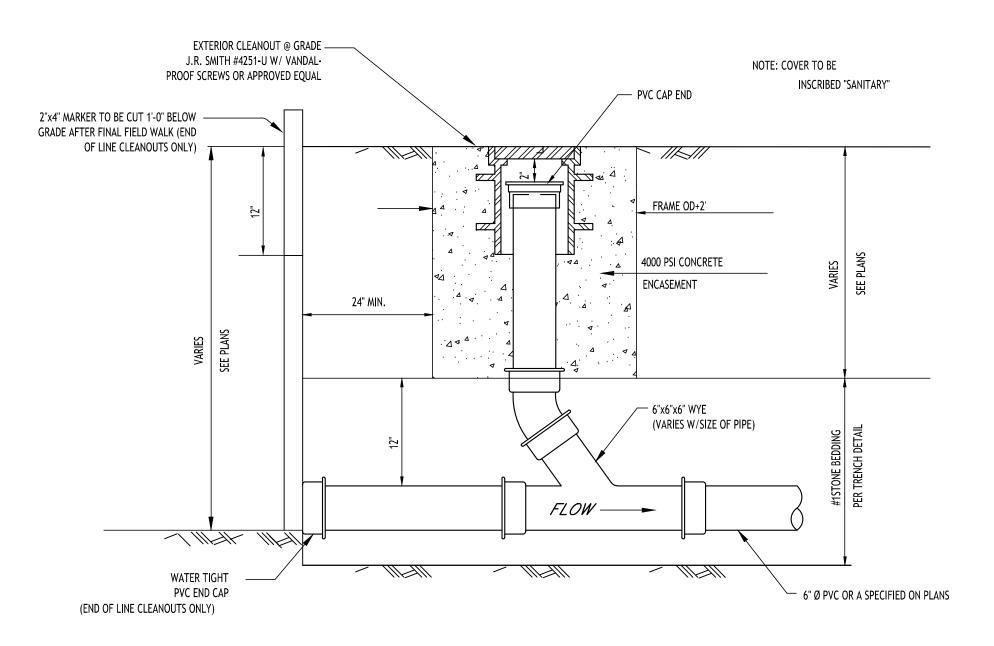

LAMPHOLE/CLEANOUT IN PAVEMENT/SIDEWALK

FRAME OD + 2'

EXTERIOR CLEANOUT @ GRADE —— J.R. SMITH #4251-U W/ VANDAL-

PROOF SCREWS OR APPROVED EQUAL

TOP COURSE


BINDER

STONE BASE

SELECT FILL

FLOW —

LAMPHOLE/CLEANOUT IN LAWN/FIELD AREAS NOT TO SCALE

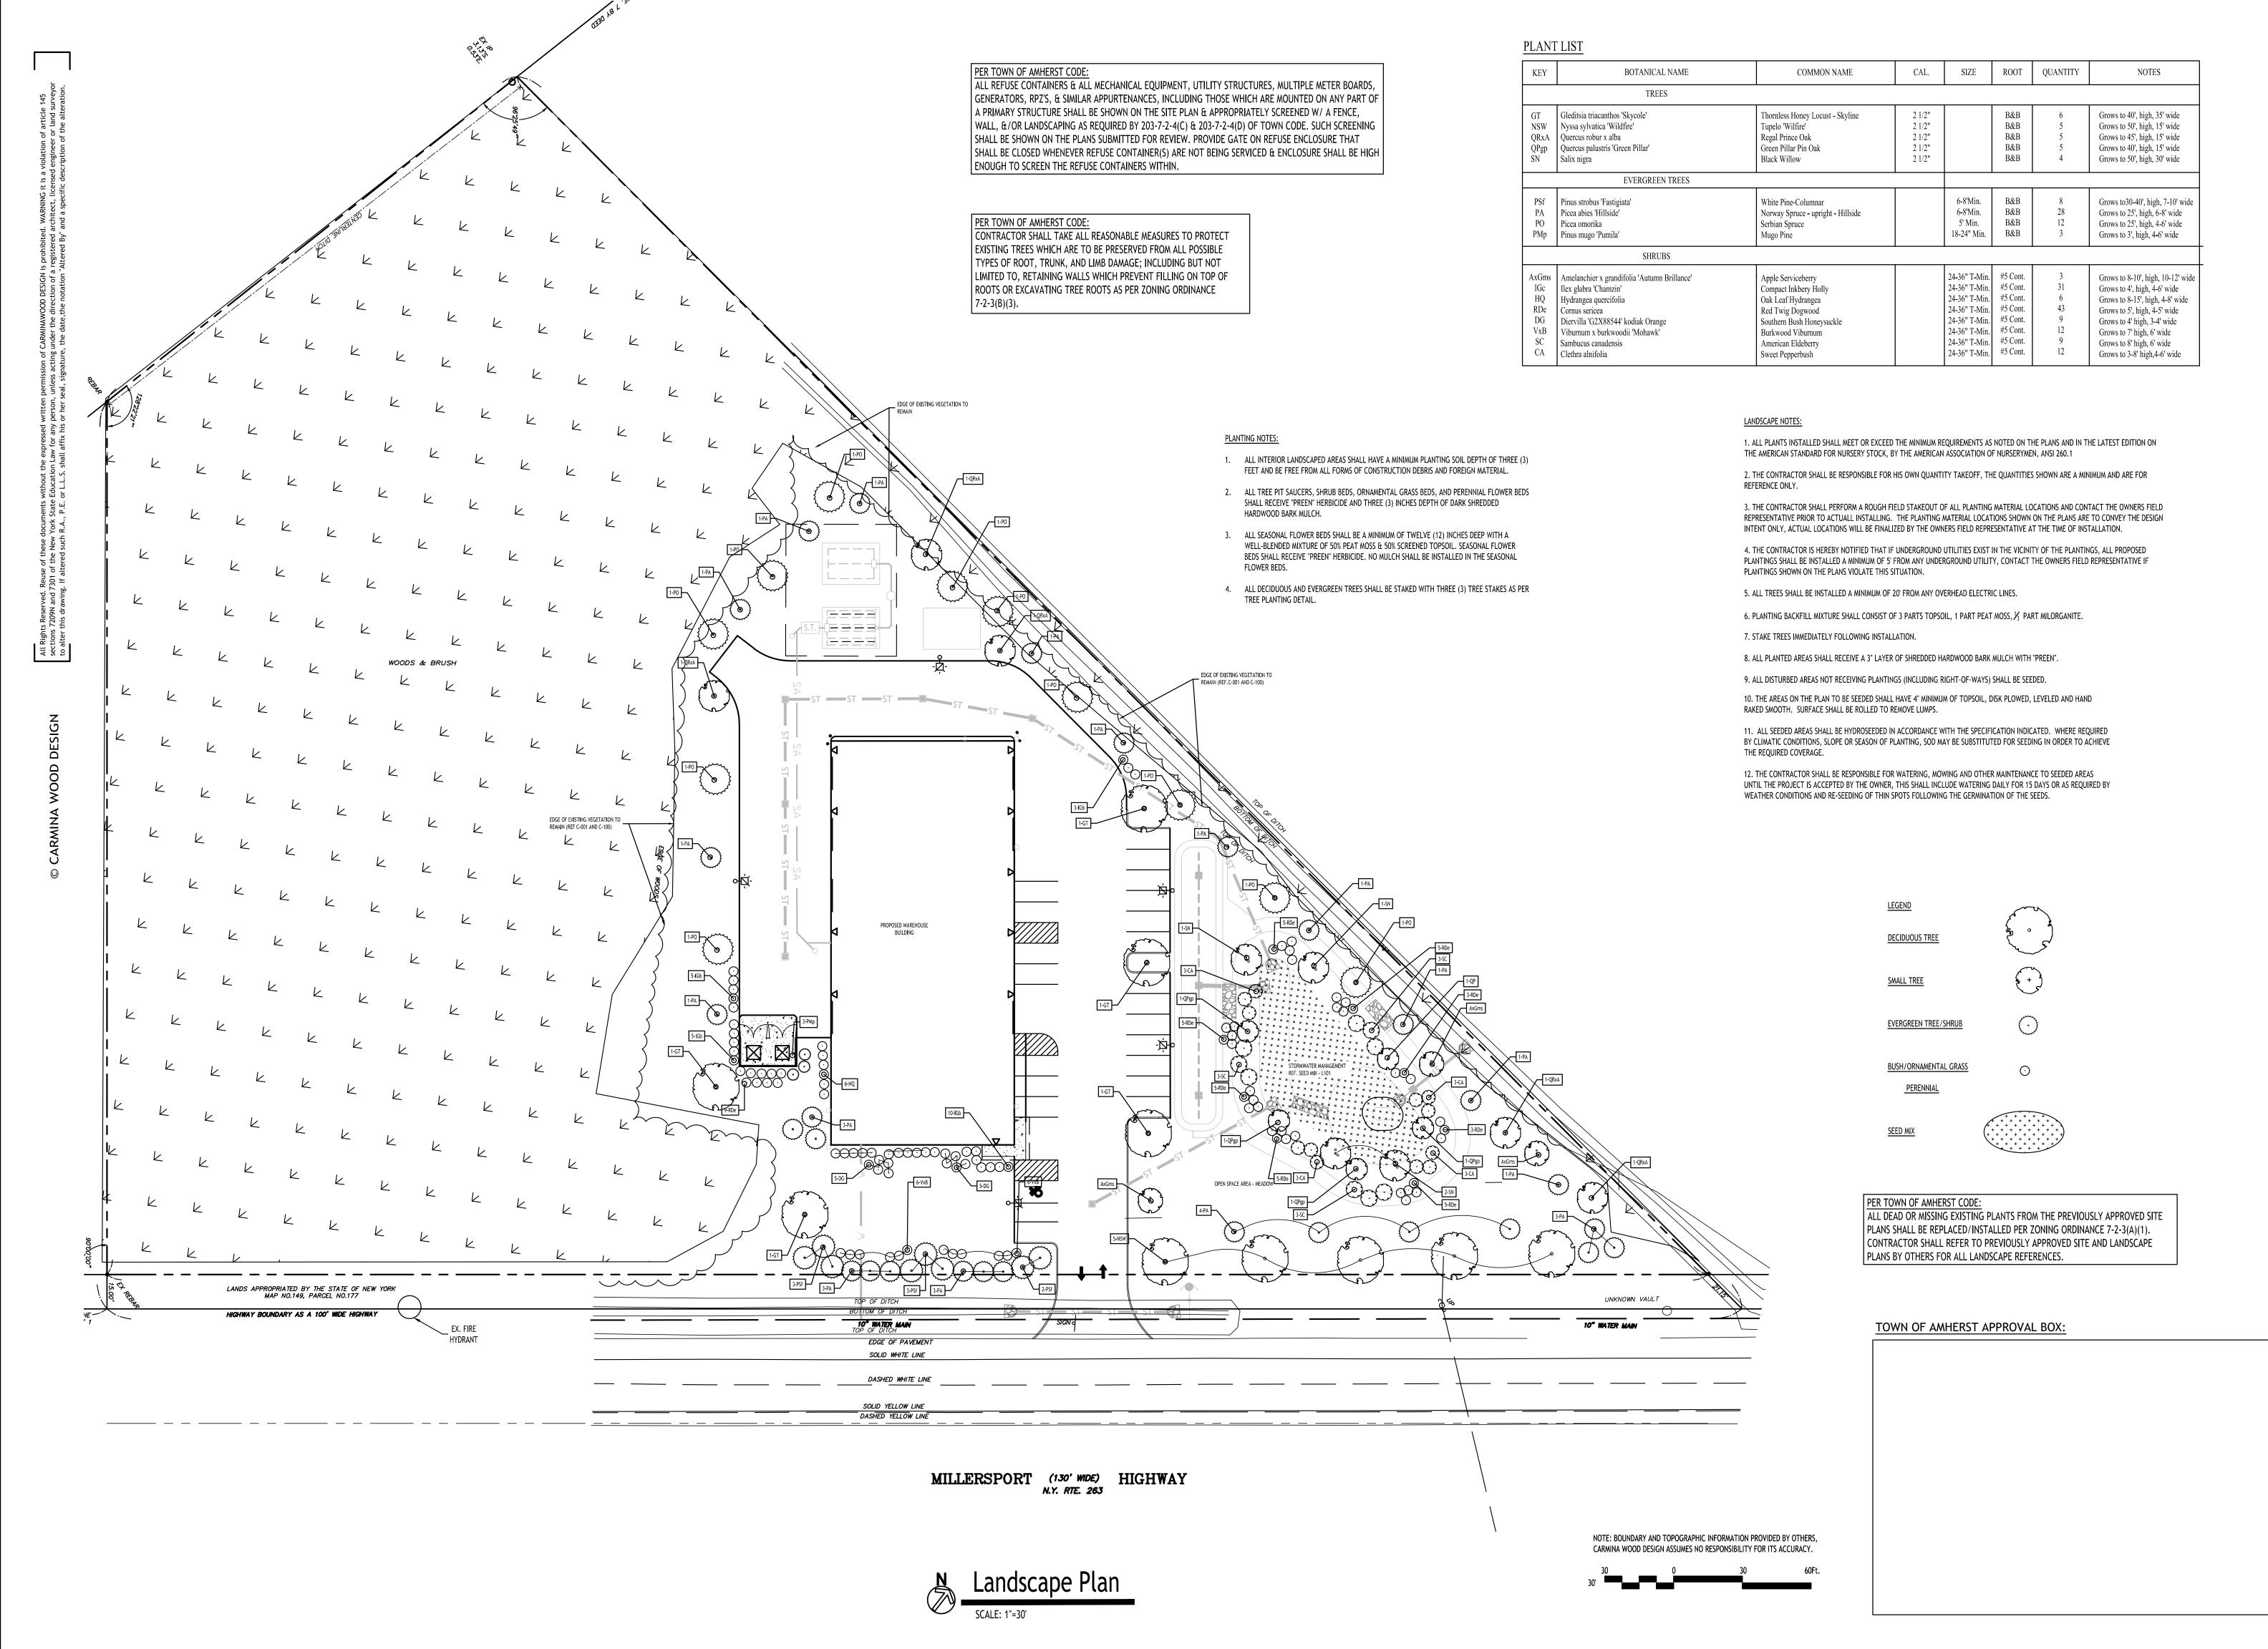

di **B**

Sealed 07/07/2025

DRAWING NAME: Landscape Plan

Drawn By: Scale: DRAWING NO.

11/19/24 C. Wood

Botanical Name

1.30 % Penstemon digitalis, PA Ecotype

0.50 % Juncus effusus

Common Name

29.50 % Schizachyrium scoparium, Fort Indiantown Gap-PA Ecotype Little Bluestem, Fort Indiantown Gap-PA Ecotype 20.00 % Elymus virginicus, Madison-NY Ecotype Virginia Wildrye, Madison-NY Ecotype 9.00 % Carex vulpinoidea, PA Ecotype Fox Sedge, PA Ecotype

Rain Garden Mix - ERNMX-180

Tall White Beardtongue, PA Ecotype

8.00 % Echinacea purpurea Purple Coneflower 5.80 % Panicum rigidulum, PA Ecotype Redtop Panicgrass, PA Ecotype 5.30 % Chasmanthium latifolium, WV Ecotype River Oats, WV Ecotype

3.00 % Coreopsis lanceolata Lanceleaf Coreopsis 3.00 % Rudbeckia hirta Blackeyed Susan 2.50 % Verbena hastata, PA Ecotype Blue Vervain, PA Ecotype 2.00 % Panicum clandestinum, Tioga Deertongue, Tioga 1.80 % Heliopsis helianthoides, PA Ecotype Oxeye Sunflower, PA Ecotype 1.50 % Asclepias incarnata, PA Ecotype Swamp Milkweed, PA Ecotype

1.00 % Carex scoparia, PA Ecotype Blunt Broom Sedge, PA Ecotype 1.00 % Senna hebecarpa, VA & WV Ecotype Wild Senna, VA & WV Ecotype Golden Alexanders, PA Ecotype 1.00 % Zizia aurea, PA Ecotype 0.50 % Baptisia australis, Southern WV Ecotype Blue False Indigo, Southern WV Ecotype

Path Rush, PA Ecotype 0.50 % Juncus tenuis, PA Ecotype 0.50 % Pycnanthemum tenuifolium Narrowleaf Mountainmint 0.50 % Vernonia noveboracensis, PA Ecotype New York Ironweed, PA Ecotype 0.40 % Aster novae-angliae, PA Ecotype New England Aster, PA Ecotype

Wild Bergamot, Fort Indiantown Gap-PA Ecotype 0.40 % Monarda fistulosa, Fort Indiantown Gap-PA Ecotype Zigzag Aster, PA Ecotype 0.20 % Aster prenanthoides, PA Ecotype

Soft Rush

0.10 % Aster lanceolatus Lance Leaved Aster 0.10 % Aster lateriflorus Calico Aster 0.10 % Aster pilosus, PA Ecotype Heath Aster, PA Ecotype 0.10 % Eupatorium perfoliatum, PA Ecotype Boneset, PA Ecotype

0.10 % Mimulus ringens, PA Ecotype Square Stemmed Monkeyflower, PA Ecotype

Early Goldenrod, PA Ecotype 0.10 % Solidago juncea, PA Ecotype 0.10 % Solidago nemoralis, PA Ecotype Gray Goldenrod, PA Ecotype 0.10 % Solidago rugosa, PA Ecotype Wrinkleleaf Goldenrod, PA Ecotype


100.00 %

Seeding Rate: 20 lb per acre with a cover crop. For sites that drain within 24 hours of a rain event use one of the following cover crops:Oats (1 Jan to 31 Jul;

30 lbs/acre), Japanese Millet (1 May to 31 Aug; 10 lbs/acre), or grain rye (1 Aug to 31 Dec; 30

Grasses & Grass-like Species - Herbaceous Perennial; Herbaceous Flowering Species - Herbaceous Perennial; Stormwater Management; Uplands & Meadows

The native perennial forbs and grasses provide food and cover for rain garden biodiversity. Mix formulations are subject to change without notice depending on the availability of existing and new products. While the formula may change, the guiding philosophy and function of the mix will not.

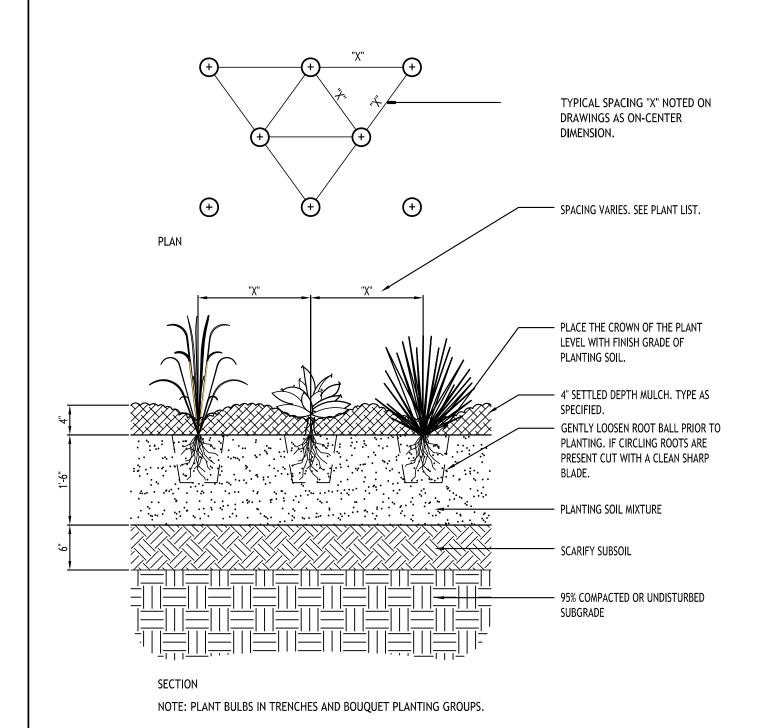


1- SEE SPECIFICATIONS FOR ADDITIONAL TREE PROTECTION


GRADE WITH THE TREE


PROTECTION FENCE

_UNLESS OTHERWISE INDICATED ON THE

GROUND COVER PLANT SPACING

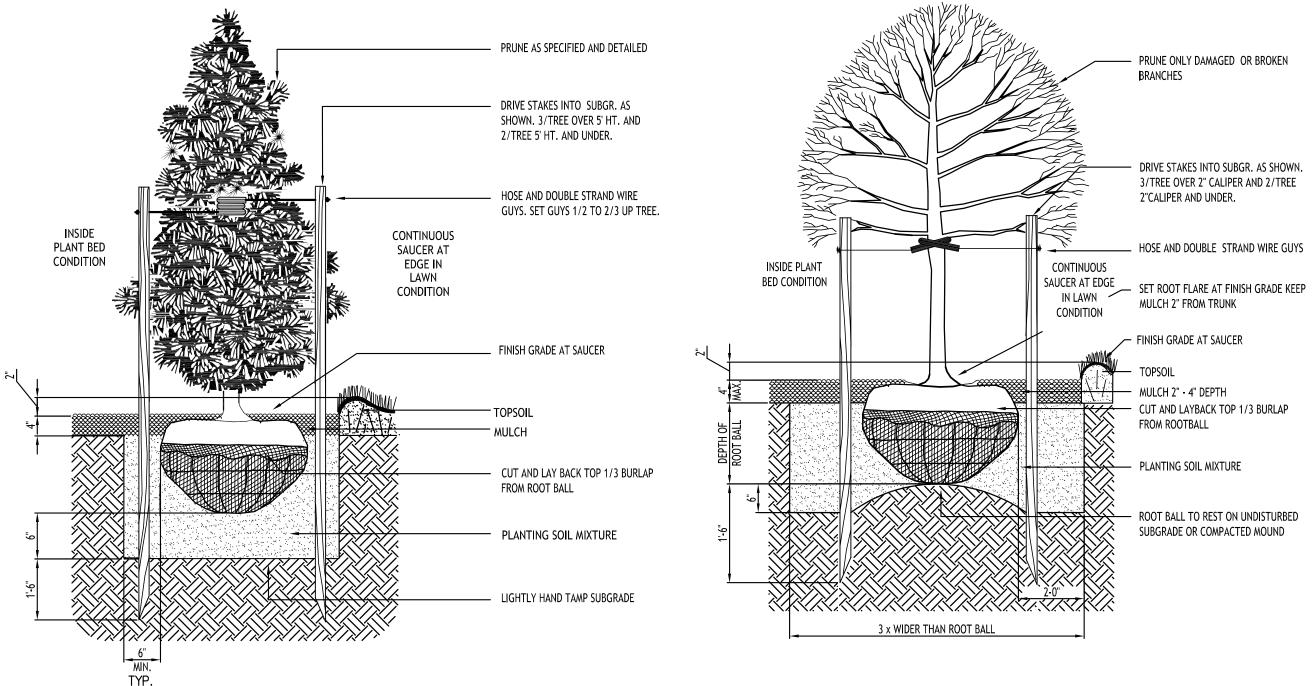

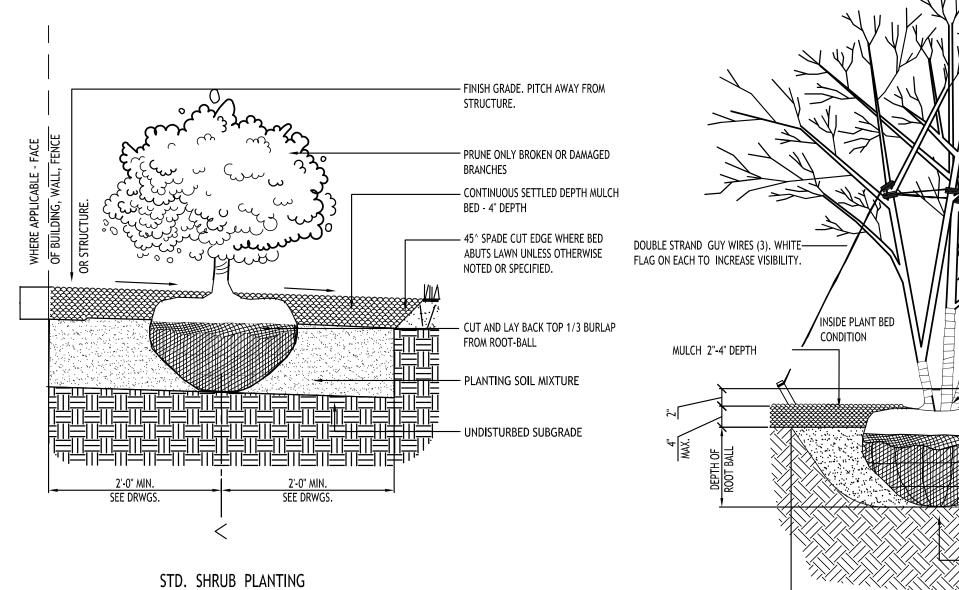


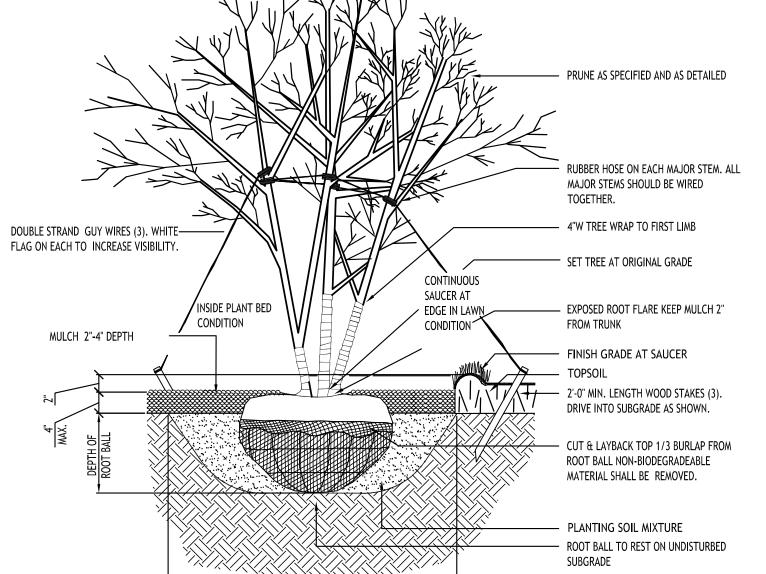


STD. DECIDUOUS TREET PLANTING



2-3 x WIDER THAN ROOT BAL

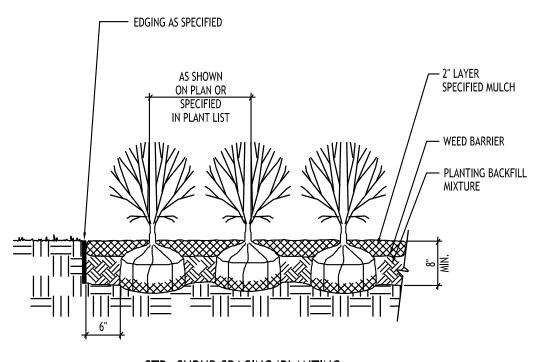

STD. SHRUB SPACING/PLANTING

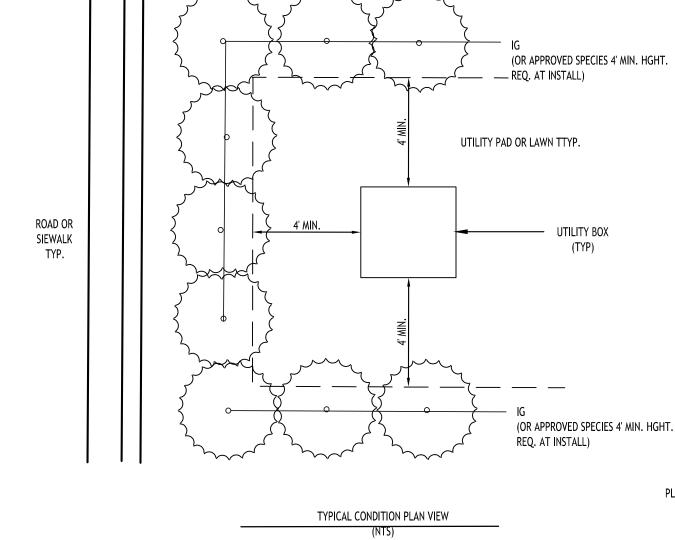

1. USE EVERGREEN SHRUBS TO SCREEN ALL ABOVEGROUND UTILITY BOXES AND INFASTRUCTURE FROM ADJACENT ROAD OR SIDEWALK PER TOWN OF AMHERST CODE

2. PROVIDE A MINIMUM 4' OFFSET FROM THE SHRUBS PLANTED EDGE TO THE EDGE OF THE UTILITY BOX TO ALLOW ENOUGH CLEARANCE FOR UTILITY MAINTENANCE TO BE PERFORMED

TYPICAL SHRUB PLANTING TO SCREEN UTILITY INFASTRUCTURE

REQUIREMENTS. 2- IF THERE IS NO EXISTING IRRIGATION, SEE SPECIFICATIONS FOR WATERING REQUIREMENTS. 3- NO PRUNING SHALL BE PERFORMED EXCEPT BY APPROVED 4- NO EQUIPMENT SHALL OPERATE INSIDE THE PROTECTIVE FENCING INCLUDING DURING FENCE INSTALLATION AND REMOVAL. 5- SEE SITE PREPARATION PLAN FOR ANY MODIFICATIONS WITH THE TREE PROTECTION TREE PROTECTION FENCE: HIGH DENSITY POLYETHYLENE FENCING WITH 3.5" X 1.5" OPENINGS; COLOR-ORANGE. STEEL POSTS INSTALLED AT 8' O.C. SIGN 2" X 6' STEEL POSTS LAMINATED IN OR APPROVED EQUAL. PLASTIC SPACED EVERY 50' ALONG THE LAYER OF MULCH. - MAINTAIN EXISTING

Crown drip line or other limit of Tree Protection area. See

tree preservation plan for fence alignment.

SECTION VIEW

NOTE - REFERENCE SHEET C-001 FOR PROTECTION TREATMENT AREA

TREE PROTECTION / SAFETY NETTING

STD. EVERGREEN PLANTING

TOWN OF AMHERST APPROVAL BOX:

DRAWING NAME: Landscape Details

Sealed 07/07/2025

 \Box

S

0


0

Δ

Drawn By: Scale: DRAWING NO.

11/19/24

C. Wood As Noted

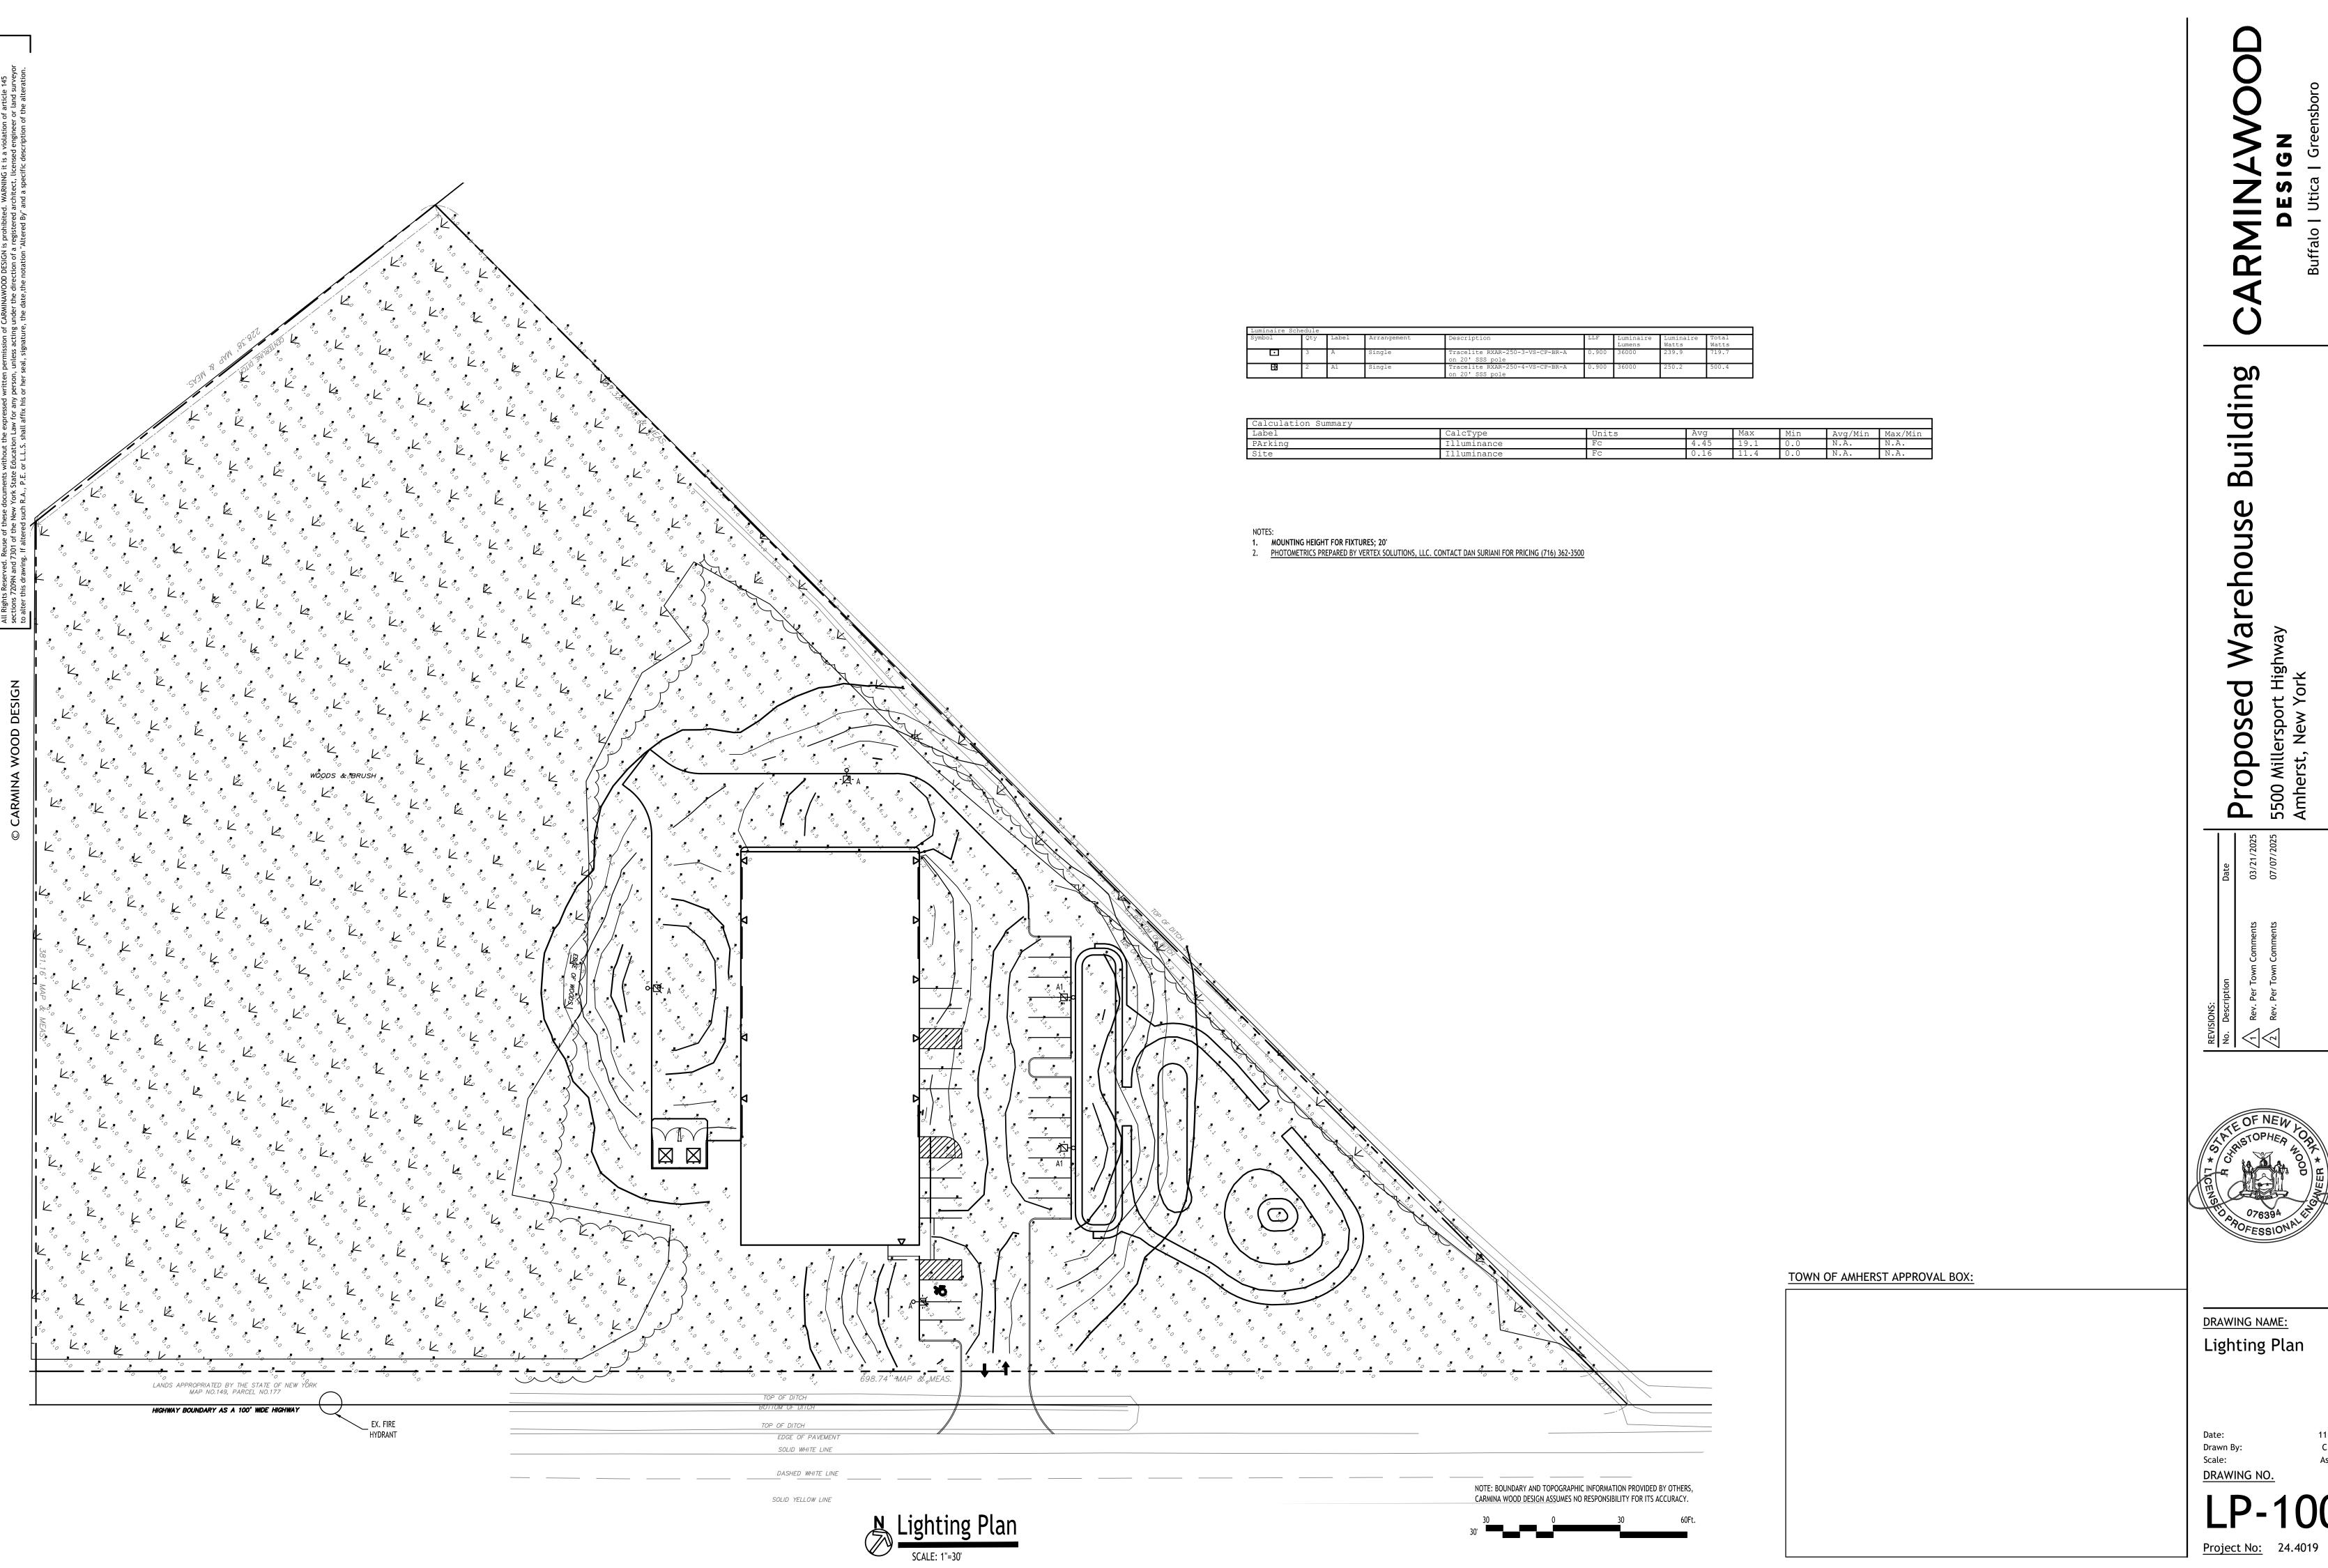

11/19/24 C. Wood As Noted

TRACE*LITE°

The RXAR Series LED area luminaire offers performance and durability with a rugged, one-piece die-cast aluminum housing and high efficacy of up to 172 lumens per watt. This versatile luminaire is designed to ensure optimal heat dissipation and energy efficiency, guaranteeing longevity and reliability. It is available in Type II, III, IV, and V distributions to cater to diverse lighting needs while maintaining zero uplight to eliminate light pollution. With field switchable power (6,200 to 60,000 lumens), and CCT (3000K-4000K-5000K, depending on model) the RXAR Series offers unparalleled flexibility. Includes straight arm for mounting to 4" and 5" square or round pole standard in the packaging. Several other mounts, shields and accessories are available for maximum

SPECIFICATIONS Construction:

• Sleek die-cast aluminum housing with stainless steel hardware and powder coated finish Integral heat sink fins maximize heat dissipation Hinged driver access door for ease of maintenance

• Straight arm for 4" and 5" square or round pole included standard, other • Slotted bolt pattern suitable for retrofit to most existing drill hole patterns • Includes a 12" whip (5 conductors provided for convenience, dimming leads not connected) Optics/LEDs:

• 40 to 400 Watts with lumen packages up to 60,000 lumens • Designed with zero uplight to eliminate light pollution Efficacies up to 172 LPW maximize energy savings and utility rebates • Type II, III, IV and V distributions optimize light distribution

· Hinged driver door for ease of access (coin plugs on the driver door provide ease of access to dipswitches for power and CCT selectability) • Standard with pole mount arm suitable for 4" or 5" square or round poles. Arm features access door for easy wiring on site • Additional contractor friendly mounts such as slipfitter, trunnion, swivel, adjustable pole mount, and wall bracket

 Five Year Warranty (Terms and Conditions Apply) • 10 Year Warranty available upon request, consult factory

• 120-277VAC 3-Pin Twist Lock receptacle (option TLPC) (Twist Lock • 120-277VAC 7-Pin Twist Lock receptacle (option TLPC3) (Twist Lock • 347-480VAC 3-Pin Twist Lock Receptacle (option TLPC4) (Twist Lock photocontrol included)

Specifications are subject to change without notice. Installation must be performed in accordance with Barron Lighting Group installation instructions. 10810439 Rev 10

SEE APP FOR

SENSOR SETTINGS

For a complete list of *litelogic*

compatible products, click here.

Sensor Settings (TL-MSSW-REMOTE)

DETECTION RADIUS/ANGLE

MOUNTING HEIGHT

REMOTE RANGE

FREQUENCY

HIGH MODE

SENSITIVITY

HOLD TIME

DAYLIGHT HARVESTING

STANDBY DIM SETTING

Specifications are subject to change without notice

Installation must be performed in accordance with

Barron Lighting Group installation instructions.

10810439 Rev 10

RXAR Series

LED Area Light Accessories:

Shown with included pole mount arm

RTIFIED	DLC LISTED PREMIUM	Pos	(APPROXIMATION OF THE PROXIMATION OF THE PROXIMATI	lite logic	₿ Bluetooth °	5
---------	--------------------------	-----	--	---------------	----------------------	----------

Type II, III, IV and V distributions optimize light distribution Easily field switchable between 3000K, 4000K and 5000K CCT (4000K and	CERTIFIED PREMI		A Same of the same	logic	Diuctoot	WARRANTY
5000K for 400W models) • L70 of >100,000 hours	Specs at a Glan	ce				
• L90 of 40,000 hours	Model	RXAR-100	RXAR-140	RXAR-250	RXAR-300	RXAR-400
• CRI ≥80 Electrical: • Class 2 power supply, 120-277VAC, 50/60Hz	Wattage*	40W-60W- 80W-100W (Switchable)	60W-90W- 120W-140W (Switchable)	100W-150W- 200W-250W (Switchable)	120W-180W- 240W-300W (Switchable)	300W-320W- 360W-400W (Switchable)
• 0-10V Dimming driver • Power Factor ≥ 0.90	Lumens (Im)	6,400 - 16,000	9,600 - 23,000	14,500 - 38,000	18,000 - 46,000	46,000 - 60,000
277-480VAC Dedicated driver option	Efficacy (LPW)	up to 170	up to 172	up to 161	up to 169	up to 167
 10KA(@120-277V) or 20KA(@347-480V) surge protection 	Distribution		Type II, III, IV, V			
Testing & Compliance: • cULus Listed for Wet Locations, tested to meet IP65 requirements	сст (к)	3000K-4000K-5000K (Switchable) 4000 (Sw				
 DesignLights Consortium® (DLC) PREMIUM Qualified (consult QPL for qualified models) 	CRI	>80				
Operating temperature: -40°C to 45°C (-40°F to 113°F), -40°C to 40°C (-40°F	Input Voltage	120-277VAC or 277-480VAC				
to 104°F) for the 400W model • 3G Vibration rated enclosure	Operating Temp	-40°C to 45°C -40°				
International Dark Sky friendly approved product. (IDA) (compliant onlywith a	Certifications	UL Listed for Wet Locations, IP65, DLC PREMIUM				
fixed downlight mount) and with factory installed RXAR-DSFA module locking	Warranty	5 Years				
CCT to 3000K	Weight	12.0 lbs	12.4 lbs	17.4 lbs	18.0 lbs	18.5 lbs
Installation: Hinged driver door for ease of access (coin plugs on the driver door provides ease of access to dipswitches for power and CCT selectability)	* Nominal Wattage. Te See performance tak				on.	

Note: Environment and application will affect actual performance. Typical values and 25°C used for testing. Factory Installed Accessories • Factory installed module to lock CCT to 3000K for Dark Sky IDA compliance (RXAR-DSFA)

• 3-Pin Twist Lock universal photocontrol (120-277VAC) for dusk to dawn lighting control • 3-Pin Twist Lock universal photocontrol (347-480VAC) for dusk to dawn lighting control

• 7-Pin Twist Lock universal photocontrol (120-277VAC) for dusk to dawn lighting control • Bluetooth enabled dimming occupancy sensor (<u>LE-MS3W-BL-AUX-HB1</u>), PIR, 120/277VAC • Dimming occupancy sensor (TL-MSP12-BL), PIR, with photocontrol, 120/277VAC • Multiple contractor friendly mounts and accessories available, see ordering information

Page 1 of 7

Wattage, Size

Ordering Information (Example: RXAR-250-3-VS-CP-BR-A-TLPC) 100 = 40-100W, Small 2 = Type II HVS¹ = 277-480VAC CP² = CCT & Power Switchable BL¹ = Black A = Pole Mount Arm 140 = 60-140W, Small 3 = Type III VS = 120-277VAC BR = Bronze 250 = 100-250W, Large SV1 = Gray Aluminum 4 = Type IV 300 = 120-300W, Large WH1 = White 400 = 300-400W, Large Options (Factory Installed)

TLPC = 120-277VAC 3-Pin Twist Lock Photocontrol and Receptacle Accessories (Factory Installed - Order As Separate Line Item) TLPC3 = 120-277VAC 7-Pin Twist Lock Photocontrol and Receptacle ${\sf RXAR-DSFA=Factory\ installed\ module\ to\ lock\ CCT\ to\ 3000K\ CT\ for\ Dark\ Sky\ IDA\ Compliance}$ TLPC4 = 347-480VAC 3-Pin Twist Lock Photocontrol and Receptacle LiteLogic Accessories³ (Field Installed - Order As Separate Line Item) Accessories3 (Field Installed - Order As Separate Line Item) W-BL-AUX-HB1 = Bluetooth PIR Motion Sensor with Photocontrol, Black

RXAR-APM-XX⁴ = Adjustable Pole Mount Arm (XX = BL; Black, BR; Bronze, SV; Gray Alum, WH; White) TL-MSP12-BL = Dimming Occupancy Sensor, PIR, Black Finish RXAR-HSS5 - House Side Shield RXAR-L-FGS-BR = Full Glare Shield, Large, Bronze Finish (250W, 300W, 400W) TL-MSSW-REMOTE = Remote for Sensor TLPR = 120-277VAC 3-Pin Twist Lock Photocontrol and Receptacle RXAR-L-GS-BR = Glare Shield, Large, Bronze Finish (250W, 300W, 400W) TLPR7 = 120-277VAC 7-Pin Twist Lock Photocontrol and Receptacle RXAR-S-FGS-BR = Full Glare Shield, Small, Bronze Finish (100W, 140W) TLPRH = 347-480VAC 3-Pin Twist Lock Photocontrol and Receptacle RXAR-S-GS-BR = Glare Shield, Small, Bronze Finish (100W, 140W) RXAR-SF-XX⁴ = Slip fitter Mount (XX = BL; Black, BR; Bronze, SV; Gray Alum, WH; White) 2XAR-WM-XX⁴ = Wall Mount (XX = BL; Black, BR; Bronze, SV; Gray Alum, WH; White) RXAR-SW-XX⁴ = Swivel Mount (XX = BL; Black, BR; Bronze, SV; Gray Alum, WH; White)

¹ 70 CRI only, longer lead times may apply, consult factory RXAR-TR-XX⁴ = Trunnion Mount (XX = BL; Black, BR; Bronze, SV; Gray Alum, WH; White) ² 400W Switchable between 4000K/5000K, static 3000K option available - consult factory ³ Order as separate line item - Shipped in separate box for final installation in the field Black (BL), Gray Aluminum (SV), and White (WH) finishes may require longer lead times, consult factory (default finish is bronze)

ADDITIONAL POLE MOUNTS AVAILABLE - SEE PAGES 6-7 FOR DETAILS

INTING HEIGHT: 20' ZERO	60'	RXAR-140-3-VS-CP (140W, 4000K) IES: TYPE III SHORT MOUNTING HEIGHT: 20' TILT: ZERO	001	RXAR-140-4-VS-CP (140W, 4000K) IES: TYPE IV SHORT MOUNTING HEIGHT: 20' TILT: ZERO	001	RXAR-140-5-VS-CP (140W, 4000K) IES: TYPE VS SHORT MOUNTING HEIGHT: 20' TILT: ZERO
	00		60'		60'	
	40'		40'		40'	
10c 3fc 11c	20'	10fc 1fc	20'	3fe 10fc 1fc 3fc	20'	Sfc 11c
516	20'	516	20'		20'	
	40'		40'		40'	

Model	Wattage	CCT	Distribution	Lumens	LPW	BUG Rating	CRI
RXAR-100-2-VS-CP-BR-A (100W, T2, 4000K)	100W	4000K	Type II	15400lm	154 lm/W	B3-U0-G3	80
RXAR-100-2-VS-CP-BR-A (80W, T2, 4000K)	80W	4000K	Type II	12700lm	159 lm/W	B3-U0-G3	80
RXAR-100-2-VS-CP-BR-A (60W, T2, 4000K)	60W	4000K	Type II	9800lm	163 lm/W	B3-U0-G2	80
RXAR-100-2-VS-CP-BR-A (40W, T2, 4000K)	40W	4000K	Type II	6600lm	165 lm/W	B2-U0-G2	80
RXAR-100-3-VS-CP-BR-A (100W, T3, 4000K)	100W	4000K	Type III	15400lm	154 lm/W	B3-U0-G3	80
RXAR-100-3-VS-CP-BR-A (80W, T3, 4000K)	80W	4000K	Type III	12700lm	159 lm/W	B3-U0-G2	80
RXAR-100-3-VS-CP-BR-A (60W, T3, 4000K)	60W	4000K	Type III	9800lm	163 lm/W	B2-U0-G2	80
RXAR-100-3-VS-CP-BR-A (40W, T3, 4000K)	40W	4000K	Type III	6600lm	165 lm/W	B2-U0-G2	80
RXAR-100-4-VS-CP-BR-A (100W, T4, 4000K)	100W	4000K	Type IV	15400lm	154 lm/W	B3-U0-G2	80
RXAR-100-4-VS-CP-BR-A (80W, T4, 4000K)	80W	4000K	Type IV	12700lm	159 lm/W	B3-U0-G2	80
RXAR-100-4-VS-CP-BR-A (60W, T4, 4000K)	60W	4000K	Type IV	9800lm	163 lm/W	B2-U0-G2	80

Page 2 of 7

Large Glare Shield RXAR-L-GS-BR

(Sold Separately)

RXAR-WM

Allows for Direct Wall Mount

(Sold Separately)

Page 6 of 7

Small Full Glare Shield

RXAR-S-FGS-BR

(Sold Separately)

Trunnion RXAR-TR

RT2-120-3-BR

Bronze finish.

RT2-90-4-BR

Round pole, 120° tenon - 3 arms

Round pole, 90° tenon - 4 arms

Vertical steel tenon adaptor to mount over

a 2-3/8" O.D. round pole, three arms, 120°.

Vertical steel tenon adaptor to mount over a

2-3/8" round pole, four arms, 90°. Bronze finish.

Specifications are subject to change without notice Installation must be performed in accordance with Barron Lighting Group installation instructions. 10810439 Rev 10

Shields (sold separately for field installation)

Small Glare Shield

(Sold Separately)

RXAR-SW

Allows Fixture to Swivel and Tilt (180° total tilt, 180° total swivel)

Round pole 90° tenon - 2 arms

Round pole 180° tenon - 2 arms

Round pole 90° tenon - 3 arms

Vertical steel tenon adaptor to mount over a 2-3/8" O.D. round pole, two arms, 90°.

Vertical steel tenon adaptor to mount over

a 2-3/8" O.D. round pole, two arms, 180°.

Vertical steel tenon adaptor to mount over

a 2-3/8" O.D. round pole, three arms, 90°.

RT2-90-2-BR

Bronze finish.

RT2-180-2-BR

Bronze finish.

RT2-90-3-BR

Mounting (non-standard mounts sold separately for field installation)

RXAR-S-GS-BR

House Side Shield

RXAR-HSS

(Sold Separately)

Slipfitter RXAR-SF

For 2-3/8" O.D. Pipe with Angle

Markers (Sold Separately)

Pole Top Arms

⁵ Two (2) pieces required for 250W, 300W, and 400W units

BARRON lighting group 800.533.3948 • www.barronltg.com

Large Full Glare Shield

RXAR-L-FGS-BR


Adjustable Pole Mount

Adjustable Between 90° Up and

90° Down with Angle Markers

RXAR-APM

(Sold Separately

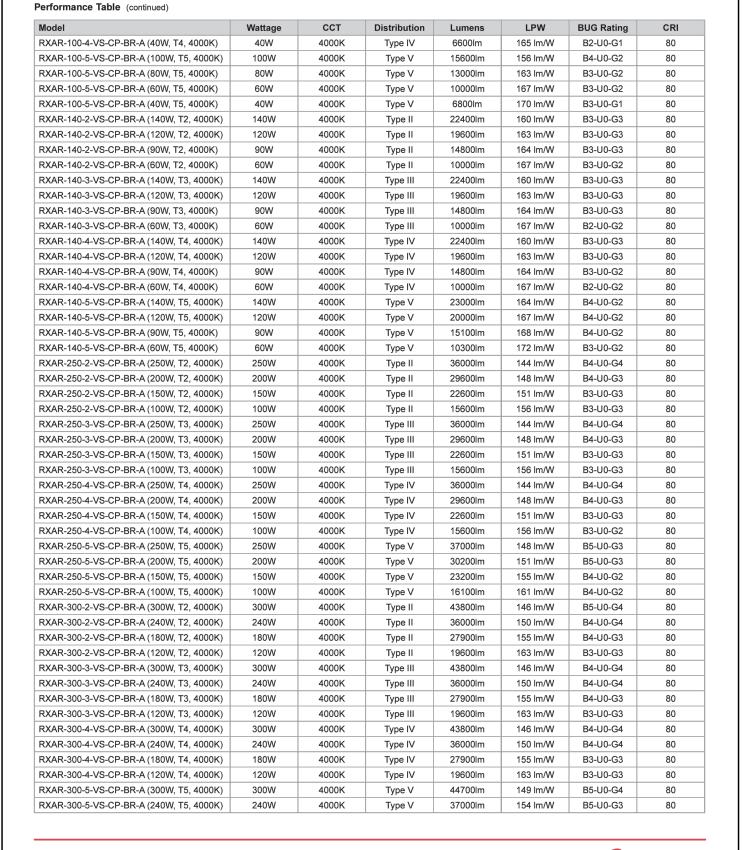

Specifications are subject to change without notice Installation must be performed in accordance with Barron Lighting Group installation instructions. 10810439 Rev 10

BARRON lighting group 800.533.3948 • www.barronltg.com Page 3 of 7

RXAR-300-5-VS-CP-BR-A (180W, T5, 4000K) RXAR-300-5-VS-CP-BR-A (120W, T5, 4000K) RXAR-400-2-VS-CP-BR-A (400W, T2, 4000K) RXAR-400-2-VS-CP-BR-A (360W, T2, 4000K) 156 lm/W RXAR-400-2-VS-CP-BR-A (325W, T2, 4000K) RXAR-400-2-VS-CP-BR-A (300W, T2, 4000K) 300W RXAR-400-3-VS-CP-BR-A (400W, T3, 4000K) RXAR-400-3-VS-CP-BR-A (360W T3 4000K) 360W 4000K Type III 56200lm 156 lm/W RXAR-400-3-VS-CP-BR-A (325W, T3, 4000K) 4000K 49900lm 156 lm/W RXAR-400-3-VS-CP-BR-A (300W, T3, 4000K) RXAR-400-4-VS-CP-BR-A (360W, T4, 4000K) 4000K 55400lm RXAR-400-4-VS-CP-BR-A (325W, T4, 4000K) 4000K RXAR-400-4-VS-CP-BR-A (300W, T4, 4000K) 300W 4000K RXAR-400-5-VS-CP-BR-A (400W, T5, 4000K) 400W 4000K 156 lm/W RXAR-400-5-VS-CP-BR-A (360W, T5, 4000K) RXAR-400-5-VS-CP-BR-A (325W, T5, 4000K) 325W 4000K 163 lm/W RXAR-400-5-VS-CP-BR-A (300W, T5, 4000K) 300W 4000K Type V 50100lm 167 lm/W Dimensions (250/300/400W


(***	
PA Values						
	-					
Model	1	2 @ 90°	2 @ 180°	3 @ 90°	3 @ 120°	4 @ 90°
100/140W	0.3632	0.6849	0.8861	1.0481	1.2078	1.0481
200/300/400W	0.4758	0.8091	1.059	1.2849	1.3923	1.2849

Page 4 of 7

Specifications are subject to change without notice. Installation must be performed in accordance with Barron Lighting Group installation instructions. 10810439 Rev 10

Performance Table (continued)

BARRON 800.533.3948 • www.barronltg.com

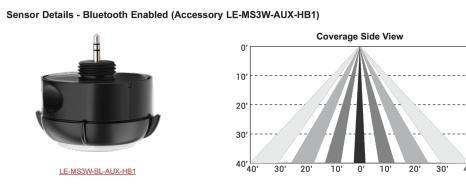







BARRON

800.533.3948 • www.barronltg.com

Coverage Top View (40')



Sensor Details (Accessories TL-MSP12-BL and TL-MSSW-REMOTE)

MAX 60'/360'


MAX 40'

MAX 33'

5.8 gHz

(DEFAULT 5min)

STANDBY TIME SETTING (TO OFF) ON (disabled), 1min, 30min, 60min (DEFAULT 30min)

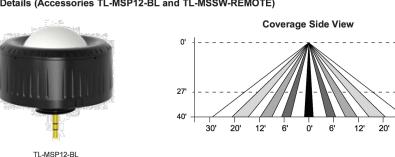

70%, 80%, 90%, 100% (DEFAULT 100%)

20%, 50%, 75%, 100% (DEFAULT 100%)

OLux, 300Lux (DEFAULT disabled)

0, 10%, 20%, 30%, OFF (∞), (DEFAULT 30%)

10sec, 1min, 5min, 10min, 15min, 20min, 30min, 60min

(disabled), 10Lux, 30Lux, 50Lux, 100Lux, 150Lux,

Page 5 of 7

Coverage Top View (40')

MODIFICATION OF THE PARTY OF TH	

TL-MSSW-REMOTE Accessory (Sold Separately)

> BARRON 800.533.3948 • www.barronltg.com 10810439 Rev 10

Specifications are subject to change without notice Installation must be performed in accordance with Barron Lighting Group installation instructions.

BARRON 800.533.3948 • www.barronltg.com




Page 7 of 7

Wall Mount Adaptors

WM-T-90-BR Wall mount 90° tenon 2-3/8" O.D. steel tenon adaptor with 90° arm for wall mount applications, for use with slipfitter accessory. Bronze finish. 3-1/4" Spacing beween mounting holes

WM-T-S-BR Wall mount straight tenon 2-3/8"O.D. steel tenon adaptor arm for wall mount applications, for use with slipfitter accessory. Bronze finish.

Drilling Template (Standard Mount)

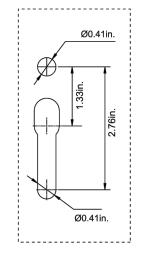

Specifications are subject to change without notice Installation must be performed in accordance with Barron Lighting Group installation instructions. 10810439 Rev 10

BARRON 800.533.3948 • www.barronltg.com TOWN OF AMHERST APPROVAL BOX:

DRAWING NAME: Lighting Details

di

Ë

B

0


D

0

Δ

Date: Drawn By: Scale: DRAWING NO.

11/19/24 C. Wood As Noted

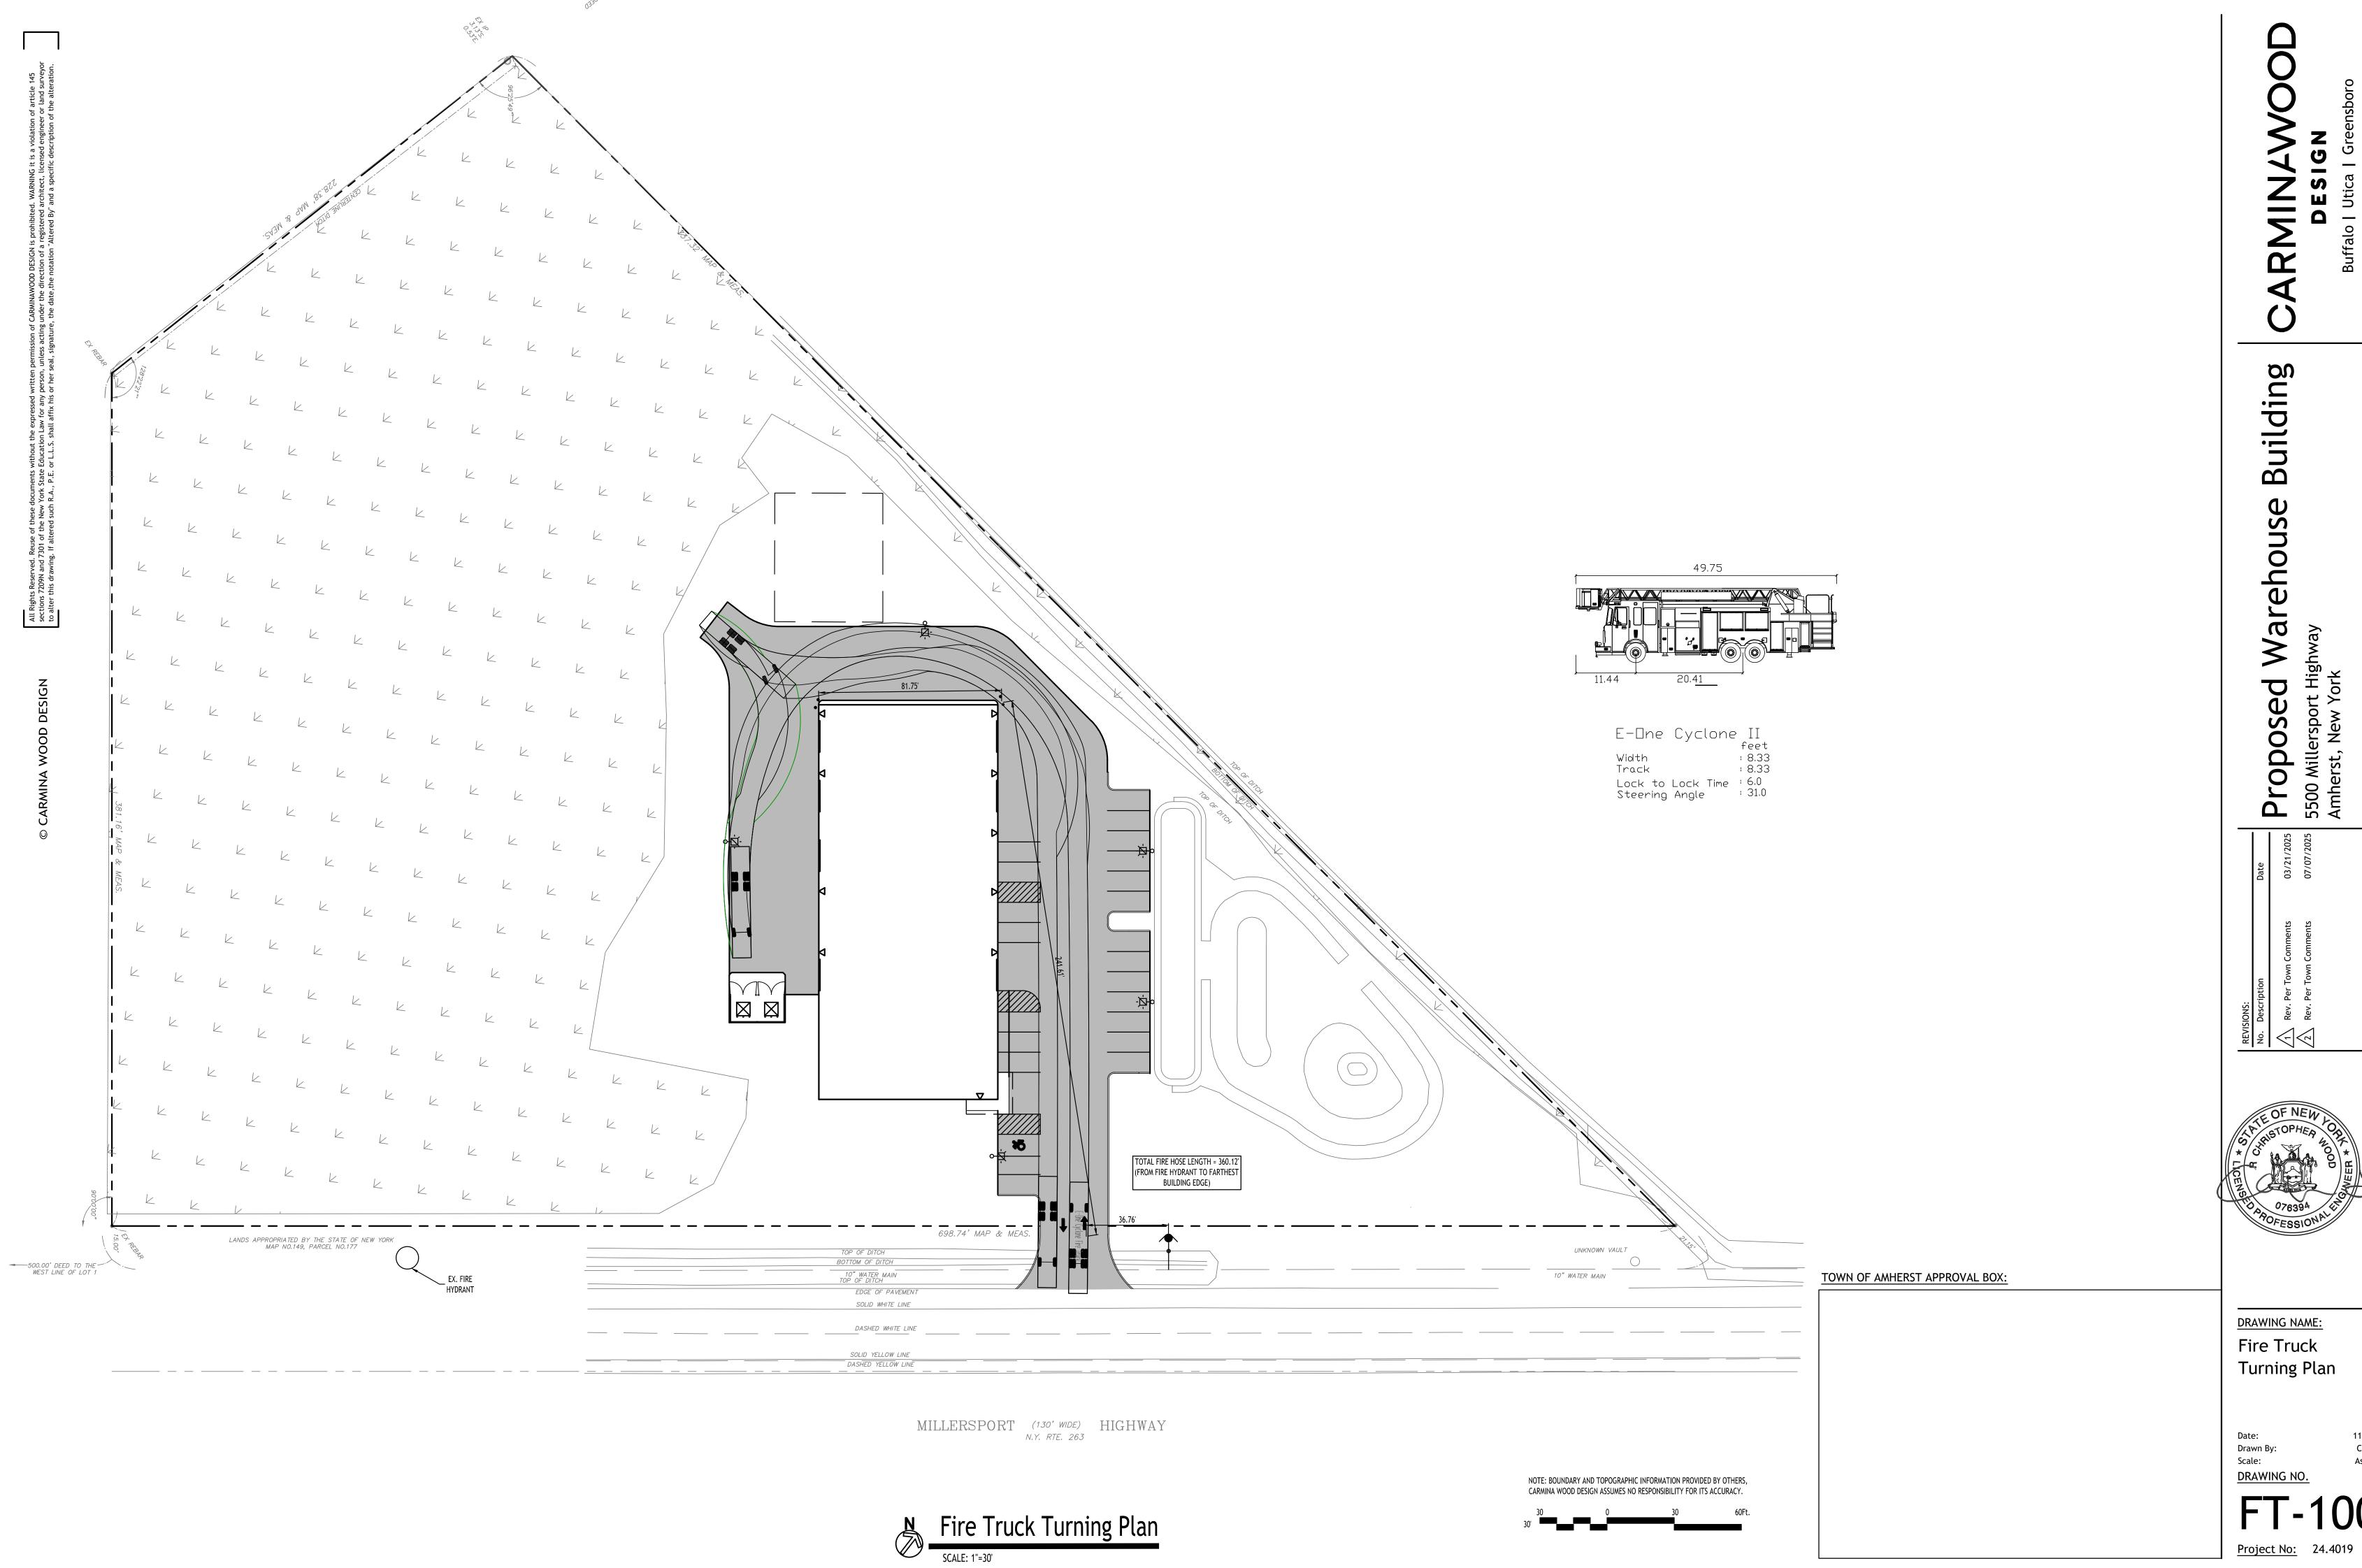



DRAWING NAME: Fire Truck

11/19/24 C. Wood As Noted