PROPOSED RETAIL

Main St. - Snyder 4548-4564 Main Street Town of Amherst, NY 14226 BDC Property # 5202

INDEX OF DRAWINGS

REVISION DATE DRAWING NAME **COVER SHEET EXISTING SURVEY** DEMOLITION AND EROSION CONTROL PLAN DEMOLITION AND EROSION CONTROL DETAILS OVERALL SITE PLAN DETAILED SITE PLAN **CONSTRUCTION DETAILS GRADING PLAN** DRAINAGE PLAN DRAINAGE DETAILS UTILITY PLAN UTILITY DETAILS LANDSCAPING PLAN LIGHTING PLAN LIGHTING DETAILS

OWNER/DEVELOPER:

NAME: BENDERSON DEVELOPMENT COMPANY, LLC ADDRESS: 570 DELAWARE AVENUE, BUFFALO, NY 14202

CONTACT: DAVID ZUPPELLI PHONE: 716 - 878 - 9683



BENDERSON DEVELOPMENT COMPANY, LLC

570 Delaware Ave. Buffalo, New York 14202

SURVEYOR

PHONE:

NAME: TRUE NORTH SURVEYING ADDRESS: 150 AERO DRIVE, BUFFALO NY 14225

716-631-5140

CONTACT: CHRISTOPHER BARR

UTILITIES:

WATER DEPARTMENT

ADAM MASSARO NAME/TITLE:

COMPANY/DEPT: ERIE COUNTY WATER AUTHORITY ADDRESS: 3030 UNION RD, CHEEKTOWAGA, NY

PHONE: 716 - 685-8207

BUILDING & PLUMBING DEPARTMENT

NAME/TITLE:

TOWN OF AMHERST, NY - BUILDING DPT COMPANY/DEPT: ADDRESS: 5583 MAIN STREET, WILLIAMSVILLE, NY 14221

716 - 631 - 7080

NATURAL GAS

NAME/TITLE: WILLIAM SCHNEIDER NATURAL FUEL GAS COMPANY/DEPT: **ADDRESS**

PHONE: 716 - 696 - 6460

TELEPHONE COMPANY

JOHN HECKMAN COMPANY/DEPT: ADDRESS:

ELECTRIC

PHONE:

NAME/TITLE:

COMPANY/DEPT: NATIONAL GRID

ADDRESS:

PHONE:

DIG SAFELY NEW YORK

PHONE: 1 - 800 - 962 - 7962 OR (811)

716 - 840 - 8603

AGENCIES:

ENGINEERING DEPARTMENT

NAME/TITLE: JEFF BURROUGHS COMPANY/DEPT:

TOWN OF AMHERST, NY - ENGINEERING DPT ADDRESS: 1100 NORTH FOREST RD, WILLIAMSVILLE, NY

PHONE: 716 - 631 - 7154 EX 7418

PLANNING DEPARTMENT

NAME/TITLE: DAN HOWARD

COMPANY/DEPT: TOWN OF AMHERST, NY - PLANNING DPT

5583 MAIN STREET, WILLIAMSVILLE, NY 14221 ADDRESS:

PHONE: 716 - 631 - 7051


NYSDOT - HIGHWAY & UTILITY PERMITS

NAME/TITLE: ALFRED I. OYOYO, ASSISTANT RESIDENT ENGINEER COMPANY/DEPT: NEW YORK STATE DEPARTMENT OF TRANSPORTATION

(NORTH ERIE RESIDENCY)


ADDRESS: 111 INDIAN ROAD. DEPEW, NEW YORK 14043

PHONE: 716 - 683 - 3476 (EXT - 27)

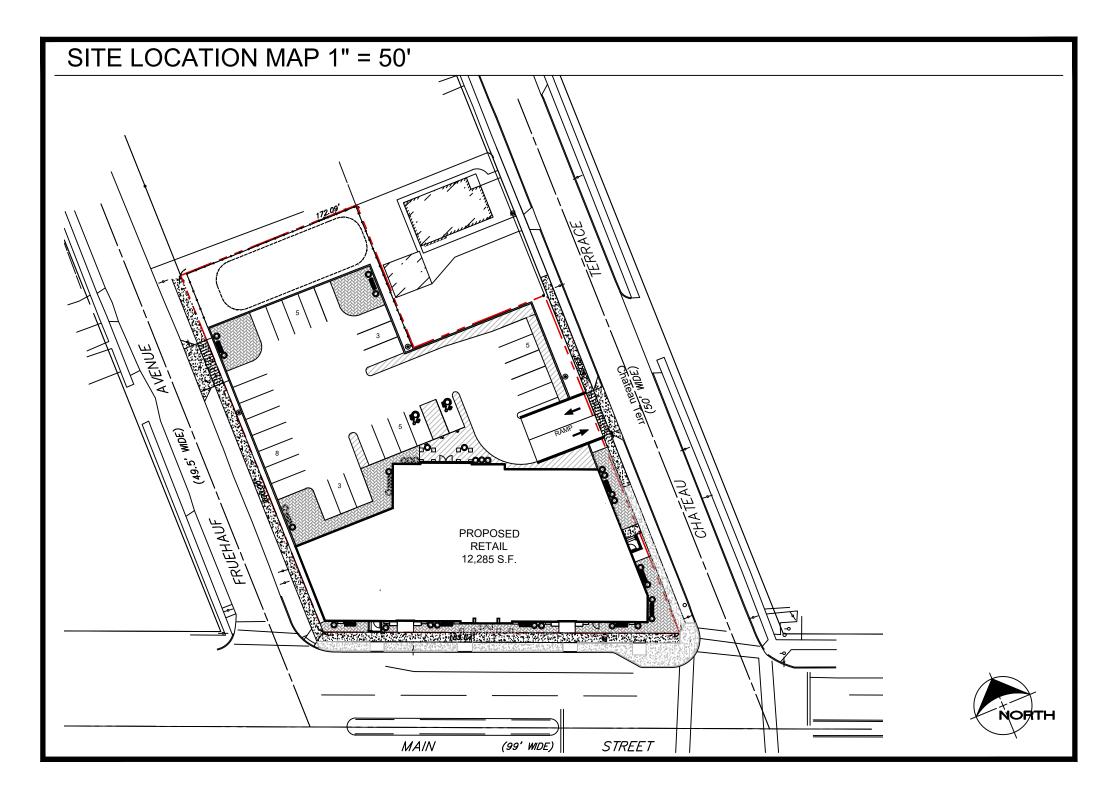



OFFICIAL TOWN USE ONLY

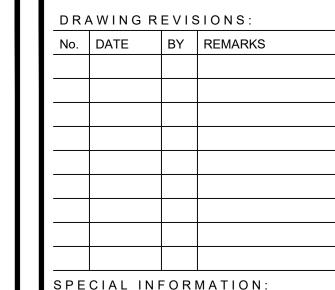

ALL CONTRACTORS SHALL GUARANTEE THEIR WORK FOR A PERIOD OF ONE YEAR FROM THE DATE OF OWNERS ACCEPTANCE.

UNAUTHORIZED ALTERATIONS OF THIS DOCUMENT AR IN VIOLATION OF SECTION #7209 OF THE STATE

CONSTRUCTION SET


PROPERTY NUMBER:

0

CONSULTANT

JAMES ALLEN RUMSEY

570 DELAWARE AVE., BUFFALO, NY 14202

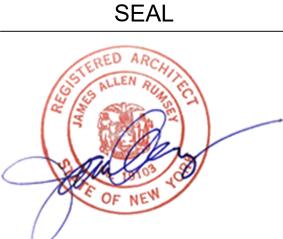


SHEET

COVER

DRAWN BY:

DATE: 04.16.2025

DRAWING NO.

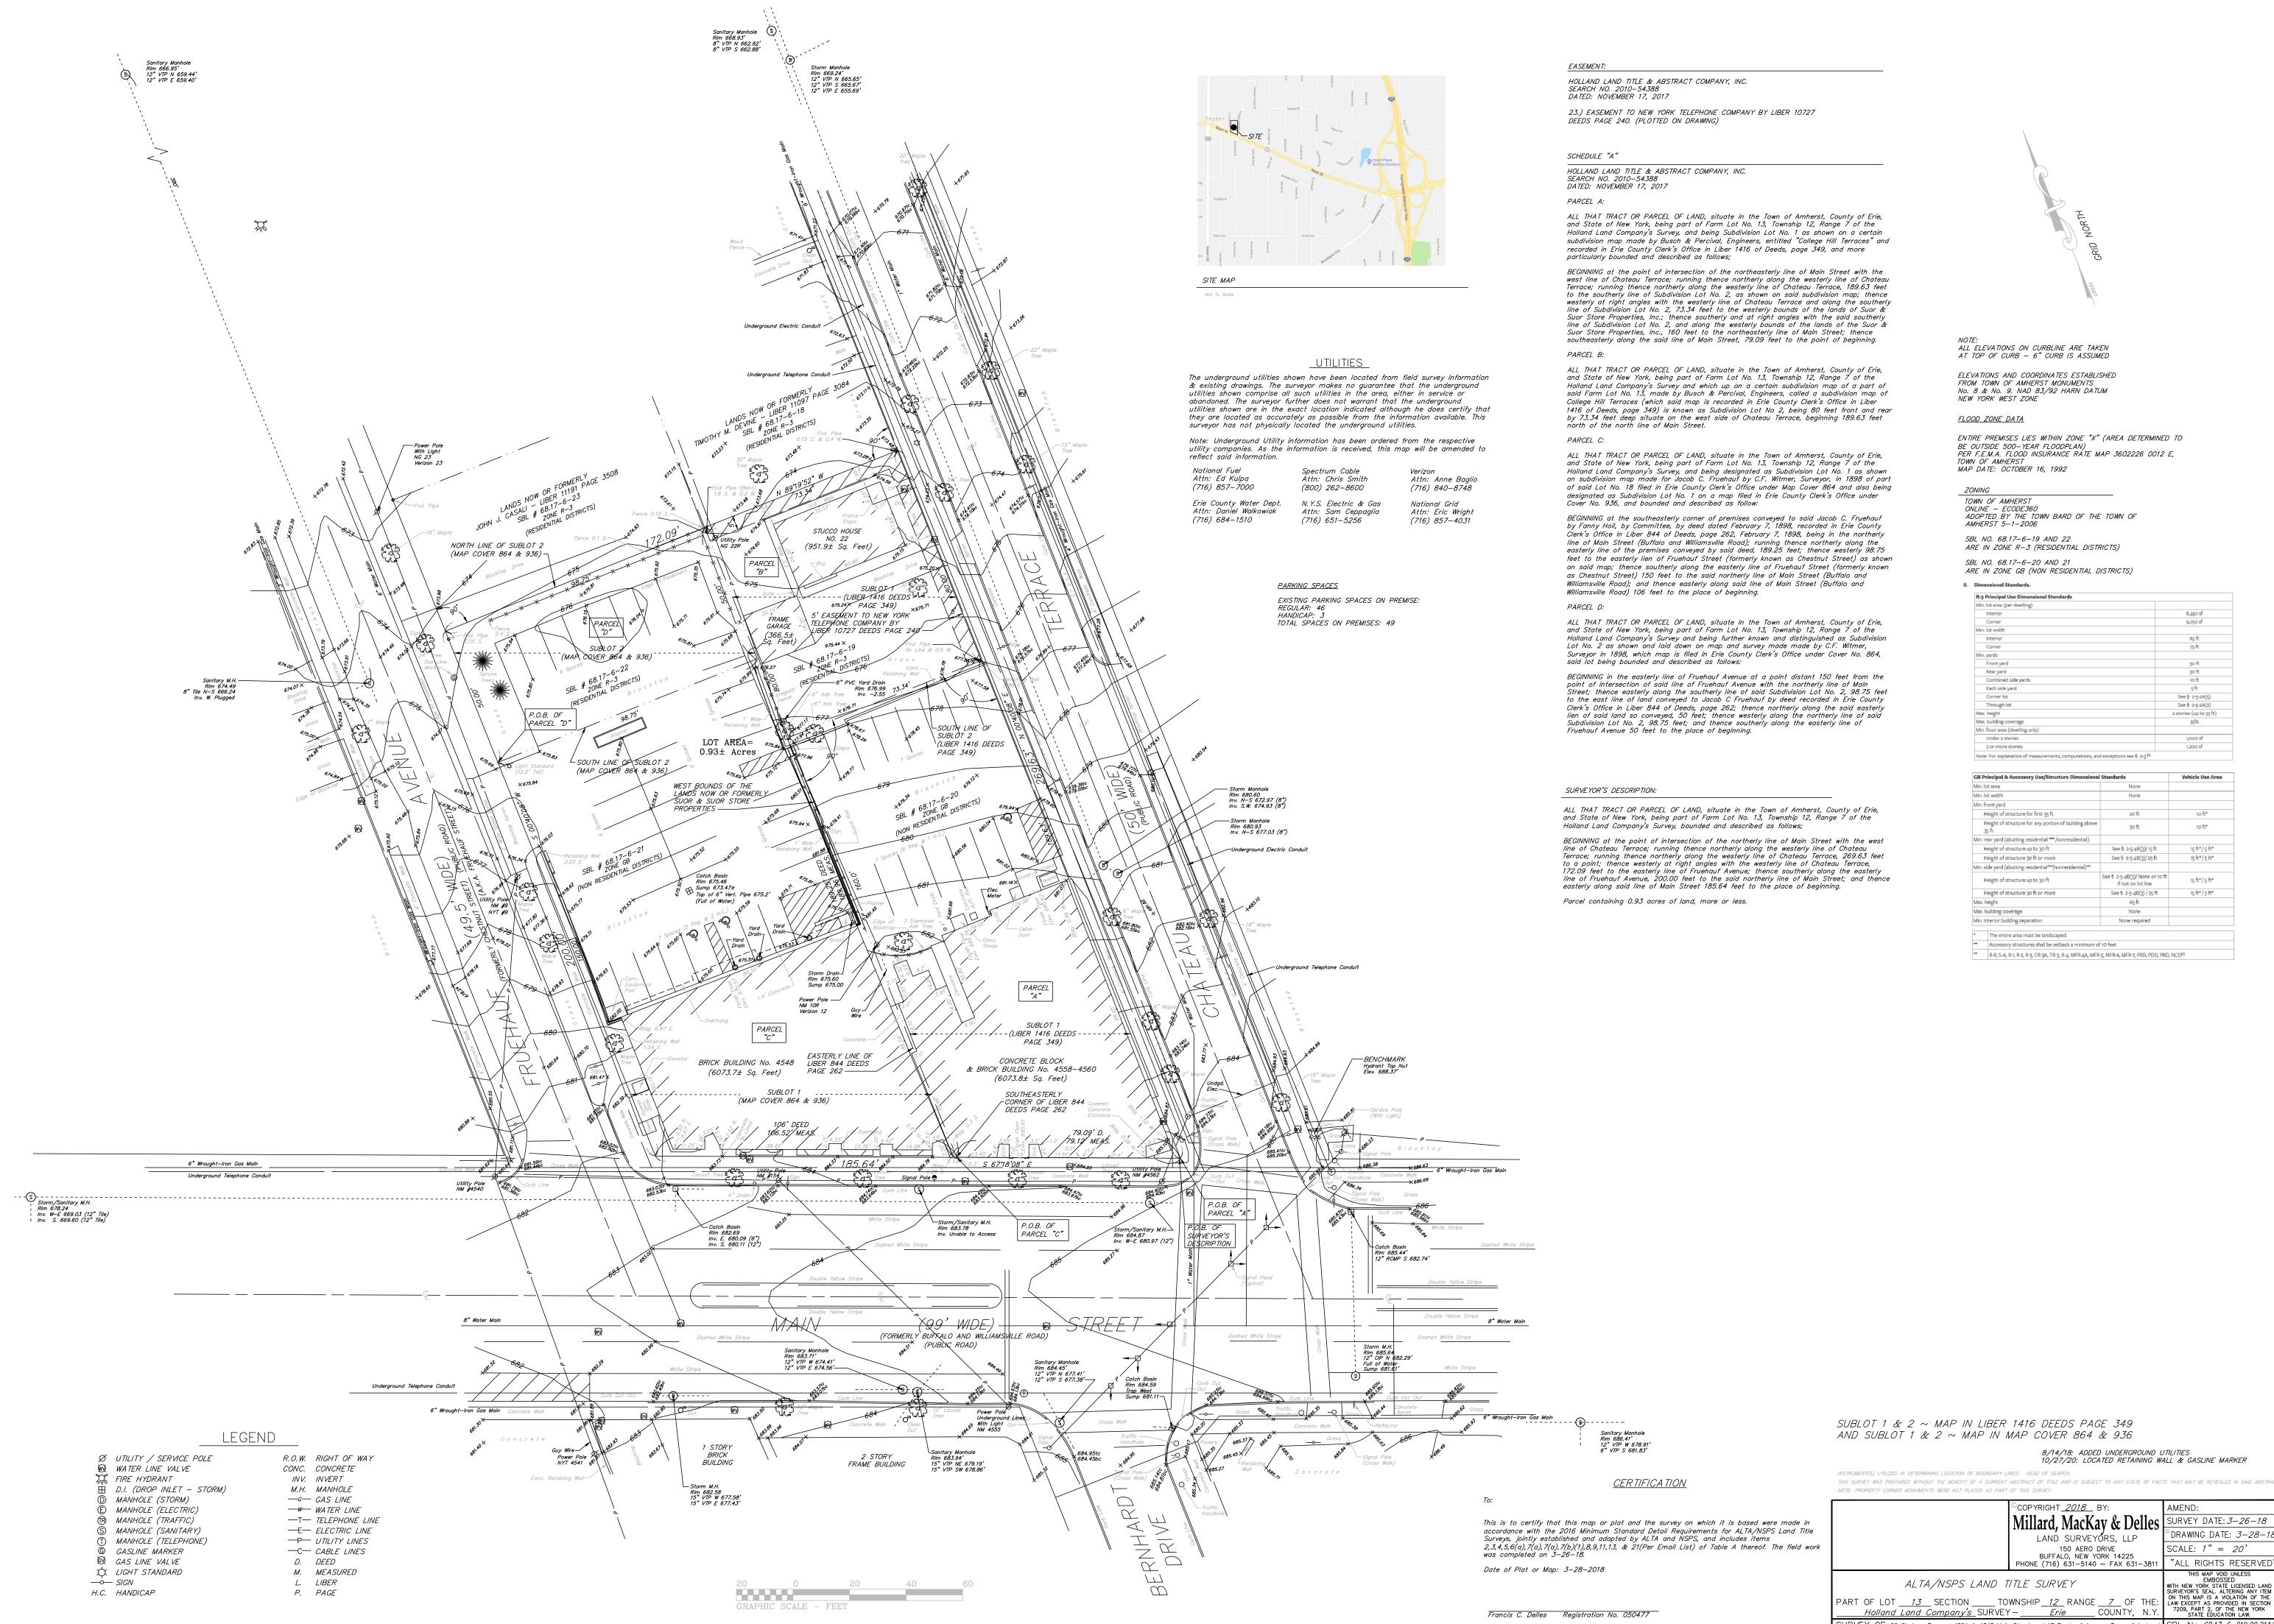



ALL ELEVATIONS ON CURBLINE ARE TAKEN AT TOP OF CURB — 6" CURB IS ASSUMED

ELEVATIONS AND COORDINATES ESTABLISHED FROM TOWN OF AMHERST MONUMENTS No. 8 & No. 9. NAD 83/92 HARN DATUM

ENTIRE PREMISES LIES WITHIN ZONE "X" (AREA DETERMINED TO BE OUTSIDE 500-YEAR FLOODPLAN) PER F.E.M.A. FLOOD INSURANCE RATE MAP 3602226 0012 E,

ADOPTED BY THE TOWN BARD OF THE TOWN OF AMHERST 5-1-2006

SBL NO. 68.17-6-19 AND 22 ARE IN ZONE R-3 (RESIDENTIAL DISTRICTS)

SBL NO. 68.17-6-20 AND 21

Min. lot area (per dwelling)	
Interior	8,450 sf
Corner	9,750 sf
Min. lot width	
Interior	65 ft
Corner	75 ft
Min. yards	
Front yard	30 ft
Rear yard	30 ft
Combined side yards	10 ft
Each side yard	5 ft
Corner lot	See § 2-5-2A(5)
Through lot	See § 2-5-2A(2)
Max. height	2 stories (up to 35 ft)
Max. building coverage	35%
Min. floor area (dwelling only)	
Under 2 stories	1,000 sf
2 or more stories	1,200 sf

Vehicle Use Area GB Principal & Accessory Use/Structure Dimensional Standard 15 ft*/5 ft* See § 2-5-4B(3)/ None or 10 ft 15 ft*/5 ft*

See § 2-5-4B(3) / 25 ft

15 ft*/5 ft*

R-R, S-A, R-1, R-2, R-3, CR-3A, TR-3, R-4, MFR-4A, MFR-5, MFR-6, MFR-7, PRD, PDD, PRD, NCD^[1]

SUBLOT 1 & 2 ~ MAP IN LIBER 1416 DEEDS PAGE 349


8/14/18: ADDED UNDERGROUND UTILITIES 10/27/20: LOCATED RETAINING WALL & GASLINE MARKER

INSTRUMENT(S) UTILIZED IN DETERMINING LOCATION OF BOUNDARY LINES: HEAD OF SEARCH THIS SURVEY WAS PREPARED WITHOUT THE BENEFIT OF A CURRENT ABSTRACT OF TITLE AND IS SUBJECT TO ANY STATE OF FACTS THAT MAY BE REVEALED IN SAI

SURVEY OF: 22 Chateau Terrace, 4564 & 4548 Main Street and 17 Fruehauf Avenue, Town of Amherst SBL No. 68.17–6–219,20,21&2

COPYRIGHT <u>2018</u> BY: AMEND: Millard, MacKay & Delles SURVEY DATE: 3-26-18 DRAWING DATE: 3-28-18 LAND SURVEYÕRS, LLP 150 AERO DRIVE SCALE: 1" = 20'BUFFALO, NEW YORK 14225 PHONE (716) 631–5140 ~ FAX 631–3811 "ALL RIGHTS RESERVED



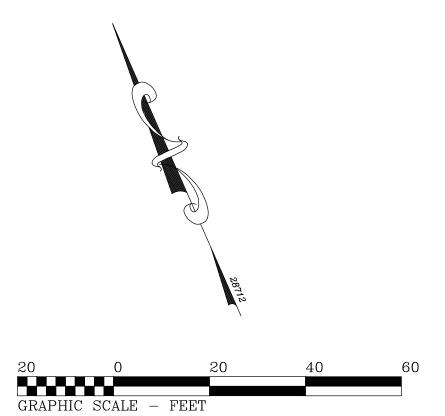


LEGEND

Ø UTILITY / SERVICE POLE W WATER LINE VALVE C FIRE HYDRANT D.I. (DROP INLET - STORM) D MANHOLE (STORM) E MANHOLE (ELECTRIC) ® MANHOLE (TRAFFIC) S MANHOLE (SANITARY) (T) MANHOLE (TELEPHONE) GASLINE MARKER M GAS LINE VALVE

R.O.W. RIGHT OF WAY CONC. CONCRETE INV. INVERT M.H. MANHOLE —G— GAS LINE ─₩─ WATER LINE —T— TELEPHONE LINE —E— ELECTRIC LINE —P— *UTILITY LINES* —C— CABLE LINES D. DEED \times LIGHT STANDARD M. MEASURED L. LIBER P. PAGE H.C. HANDICAP

SUBLOT 1 & 2 ~ MAP IN LIBER 1416 DEEDS PAGE 349 AND SUBLOT 1 & 2 ~ MAP IN MAP COVER 864 & 936

INSTRUMENT(S) UTILIZED IN DETERMINING LOCATION OF BOUNDARY LINES: HEAD OF SEARCH THIS SURVEY WAS PREPARED WITHOUT THE BENEFIT OF A CURRENT ABSTRACT OF TITLE AND IS SUBJECT TO ANY STATE OF FACTS THAT MAY BE REVEALED IN SAID ABSTRACT. NOTE: PROPERTY CORNER MONUMENTS WERE NOT PLACED AS PART OF THIS SURVEY.

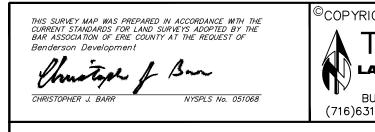

COPYRIGHT <u>2024</u> BY:	AMEND:
A TRUE N⊕RTH	SURVEY DATE: 5-16-24
TRUE NORTH	©DRAWING DATE: 5-17-24
150 AERO DRIVE	SCALE: 1" = 20'
BUFFALO, NEW YORK 14225 716)631—5140 ~ Truenorthpllc@aol.com	"ALL RIGHTS RESERVED"

BUFFALO, NEW YORK 14225
(716)631-5140 ~ Truenorthplic@aol.com

**FOUNDATION LOCATION SURVEY*

PART OF LOT ___13 SECTION ___ TOWNSHIP __12 RANGE __7 OF THE:

____ Holland Land Company's SURVEY ___ Erie ___ COUNTY, N.Y.

BUFFALO, NEW YORK 14225

"ALL RIGHTS RESERVED"

THIS MAP VOID UNLESS EMBOSSED
WITH NEW YORK STATE LICENSED LAND SURVEYOR'S SEAL. ALTERING ANY ITEM
ON THIS MAP VOID UNLESS
EMBOSSED
WITH NEW YORK STATE LICENSED LAND
ON THIS MAP VOID UNLESS
EMBOSSED
WITH NEW YORK STATE LICENSED LAND
ON THIS MAP VOID UNLESS
EMBOSSED
ON THIS MAP

SURVEY OF: 22 Chateau Terrace, 4564 & 4548 Main Street and 17 Fruehauf Avenue, Town of Amherst SBL No. 68.17-6-219,20,21&22

0.15 S. & 0.4 W. With Light NG 23 Verizon 23 30" Maple Tree 1.6 S. & 0.2 W. Fnd. Pipe On Line & 0.6 V 10' x 20' concrete wash area, Grasslined with a polyethylene sheet. location subject to change Construction Entrance \triangleleft Inv. S.W. 674.93 (8") Rim 680.93 Inv. N-S 677.03 (8") Temporary "Construction Site Entrance Only" Sign Catch Basin Rim 675.46 Sump 673.47 Ω 49 5 1 J. J. **(5)** Utility Pole NN-#4562.5 Signal Pole 🗣 S 📗 p 🙀 (8) Storm/Sanitary M.H.— Rim 684.87 Inv. W−E 680.97 (12") <u>Inv</u>. Unable to A<u>ccess</u>

DEMOLITION & EROSION NOTES

1. USE NOTED ENTRANCE FOR CONSTRUCTION ENTRANCE 2. INSTALL TEMPORARY EROSION CONTROL DEVICES AS DIRECTED WITHIN THE WORKING AREA TO PREVENT SEDIMENT MIGRATION. ALL EROSION CONTROL DEVICES SHALL BE INSTALLED IN ACCORDANCE WITH THE

3. ALL EROSION CONTROL DEVICES SHALL BE REPLACED WHEREVER THEY BECOME INOPERABLE.

4. THE CONTRACTOR SHALL BE RESPONSIBLE FOR MAINTENANCE AND REMOVAL OF TEMPORARY

5. THE CONTRACTOR MUST CONTROL DUST DURING CONSTRUCTION, DURING EARTHWORK OPERATIONS, WATER-SPREADING EQUIPMENT SHALL BE PROVIDED BY THE CONTRACTOR, AND WATER SPREAD AS NECESSARY AND AS DIRECTED IN ORDER TO CONTROL DUST.

6. DIRT OR DEBRIS LEFT ON LOCAL PUBLIC ROADS AS A RESULT OF THIS CONSTRUCTION PROJECT SHALL BE REMOVED AND ROAD SURFACES CLEANED BY THE CONTRACTORS ON A DAILY BASIS, OR MORE FREQUENTLY IF DEEMED NECESSARY

7. ALL DISTURBED AREAS (EXCEPT AREAS TO BE PAVED OR BUILT UPON) SHALL BE TOPSOILED TO A MINIMUM OF 4" DEPTH AND SEEDED IMMEDIATELY AFTER FINE GRADING TAKES PLACE AND AS SOON AS PHYSICALLY

8. THE CONTRACTOR IS RESPONSIBLY FOR THE MAINTENANCE OF DOWNSTREAM STORM SEWERS, DITCHES AND CULVERTS. SILT BUILDUP FOUND TO BE A RESULT OF THIS SITE CONSTRUCTION WORK SHALL BE REMOVED FROM DOWNSTREAM CULVERTS, DETENTION PONDS, BY THE CONTRACTOR AT NO ADDITIONAL EXPENSE TO THE OWNER OR CITY.

9. ALL SOIL EROSION AND SEDIMENT CONTROL DEVICES AND MATERIALS SHALL BE IN PLACE PRIOR TO BEGINNING EARTHWORK OPERATIONS AND SHALL BE MAINTAINED UNTIL THE ALL GRADING WORKS ARE COMPLETE.

INSTALL ALL MATERIALS TO MANUFACTURER'S RECOMMENDATIONS AND BEST STANDARDS OF TRADE INVOLVED.

. SUBSTITUTIONS SHALL BE MADE ONLY WITH OWNER'S APPROVAL AND BE OF EQUIVALENT QUALITY TO WHAT IS SPECIFIED.

. WORK SHALL BE COMPLETED IN STRICT ACCORDANCE WITH ALL LOCAL CODES AND OSHA SAFETY RULES AND REGULATIONS.

4. CONTRACTOR SHALL VERIFY ALL EXISTING CONDITIONS AND DIMENSIONS AT THE SITE. NOTIFY OWNER & ENGINEER OF DISCREPANCIES IN CONDITIONS SHOWN ON DRAWINGS PRIOR TO PROCEEDING WITH THE WORK.

5. CONTRACTOR SHALL BE RESPONSIBLE FOR PROTECTION OF ANY EXISTING STRUCTURES TO REMAIN AND ANY FINISH MATERIAL INSTALLED WHILE WORKING ON OTHER COMPONENTS. 6. CONTRACTOR SHALL KEEP JOB FREE OF DEBRIS AND MAKE FINAL CLEANUP TO THE SATISFACTION OF OWNER.

. CONTRACTOR SHALL ASCERTAIN THE LOCATION OF ALL UTILITIES PRIOR TO CONSTRUCTION SO THAT THIS WORK WILL NOT DISTURB EXISTING LINES AND/OR INSTALLATIONS EXCEPT AS DETAILED ON THE PLANS. COORDINATE ALL WORK WITH THE APPLICABLE UTILITY COMPANIES.

B. $\,$ CONTRACTOR SHALL OBTAIN AND PAY FOR ALL REQUIRED PERMITS NECESSARY TO PERFORM THE WORK.

BUILDING DIMENSIONS ARE APPROXIMATE. REFER TO ARCHITECTURAL DRAWINGS FOR LAYOUT DIMENSIONS.

 $10.\;\;$ SIDEWALK DIMENSIONS ARE APPROXIMATE. REFER TO ARCHITECTURAL DRAWINGS FOR THE SIDEWALK PLAN . CONCRETE SIDEWALK SEALERS: (REFER TO ARCHITECTURAL PLANS FOR LOCATION OF CONCRETE TYPES.)

11.1. GREY CONCRETE SIDEWALKS SHALL HAVE CHEMMASTERS - SILENCURE WITHIN 2HRS AFTER FINAL FINISHING OF CONCRETE AND ALL

11.2. EXPOSED AGGREGATE/STAMPED CONCRETE SIDEWALKS SHALL HAVE ONE (x1) COAT CHEMMASTERS - SILENCURE AS SOON AS CONCRETE HAS DRIED AFTER PRESSURE-WASHING THE RELEASE AGENT OFF. APRX 30 DAYS AFTER THIS (IF WEATHER PERMITS) APPLY ONE (x1) COAT OF

CHEMMASTERS - POLYSEAL EZ. 12. LIGHTING FIXTURE ARROW SYMBOLS REFER TO THE DIRECTION THAT THE FIXTURES ARE REQUIRED TO

FACE. SPECIFIC MOUNT BRACKETS WILL BE REQUIRED DEPENDING ON ORIENTATION AND FIXTURE COUNT.

13. CURB ISLAND DIMENSIONS ARE FROM INSIDE OF CURB TO INSIDE OF CURB.

14. CONTRACTOR TO PROVIDE NEW PAVEMENT THAT CONFORMS TO THE GRADING PLAN WHILE MAINTAINING, AS A MINIMUM, THE EXISTING STONE BASE. THE MEANS AND METHODS OF OBTAINING NEW GRADES IS LEFT UP TO THE CONTRACTOR AND CAN BE OBTAINED VIA SHIMMING THE PAVEMENT AND THEN A NEW TOP COAT, REMOVING EXISTING ASPHALT PAVEMENT AND REGRADING EXISTING STONE BASE, A COMBINATION OF THESE TWO OR ANOTHER METHOD OF THE CONTRACTORS CHOOSING. FINAL PAVEMENT WORK PLAN SHALL BE PROVIDED TO OWNER AND ENGINEER FOR REVIEW AND APPROVAL

DEMOLITION LEGEND: — - - Property Line Existing Gas ——₅к ∨тъ—— Existing Water ——EXISTING Sanitary ——Existing Storm ----- Saw Cut Line Silt Fence/Sock Inlet Protection Existing Building / Foundations to be removed. Existing Asphalt Pavement to be Removed. Sub-base to be recycled, and reused to regrade

DEMOLITION NOTES: (#) Existing Building / Foundations to be Removed. Follow construction sequence for shoring removal of existing foundation walls. Existing Curb to be removed Limits of Curb Removal Existing Asphalt Pavement to be removed and regraded (Refer to General Note 14) Existing Concrete Sidewalk/ Pavement/ Structures to be removed. Existing Storm Drainage/CB to remain and be protected during Construction.

Existing Storm Drainage/CB to be removed. Existing Utility Structure to remain and be protected during Construction. Existing Utility Structure to be removed.

OFFICIAL TOWN USE ONLY

10. Existing Fence to be removed. 11. Existing Landscaping to be removed.

12. Existing Feature to Remain. 13. Existing Feature to be Removed. DRAWING REVISIONS: No. DATE BY REMARKS

SPECIAL INFORMATION: ALL CONTRACTORS SHALL GUARANTEE THEIR WORK FOR A PERIOD OF ONE YEAR FROM THE DATE OF OWNERS ACCEPTANCE.

SHOP DRAWING SUBMITTALS ARE REQUIRED FOR ANY AND ALL STRUCTURES.

UNAUTHORIZED ALTERATIONS OF THIS DOCUMENT ARE IN VIOLATION OF SECTION #7209 OF THE STATE

CONSTRUCTION SET



PROPERTY NUMBER: #5202

AREA:

S

0


0

CONSULTANT

JAMES ALLEN RUMSEY ARCHITECT

BENDERSON DEVELOPMENT 570 DELAWARE AVE., BUFFALO, NY 14202 (716) 886-0211

SEAL

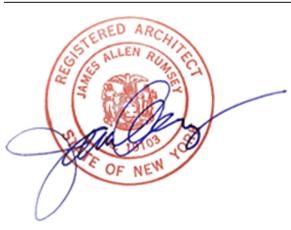


Demolition and **Erosion Control**

1" = 20' DRAWN BY:

04.16.2025


DRAWING NO. DMZ MAO DATE:

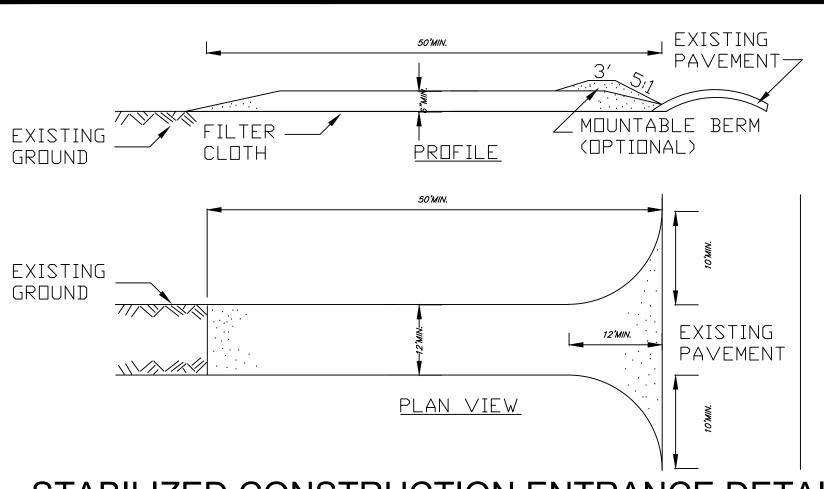



STABILIZED CONSTRUCTION ENTRANCE DETAIL

NOT TO SCALE

- 1. STONE SIZE USE 2" STONE, OR RECLAIMED OR RECYCLED CONCRETE EQUIVALENT.
- 2. LENGTH NOT LESS THAN 50 FEET (EXCEPT ON A SINGLE RESIDENCE LOT WHERE A 30 FOOT MINIMUM LENGTH WOULD APPLY).
- 3. THICKNESS NOT LESS THAN SIX (6) INCHES.
- 4. WIDTH TWELVE (12) FOOT MINIMUM, BUT NOT LESS THAN THE FULL WIDTH AT POINTS WHERE INGRESS OR EGRESS OCCURS. TWENTY-FOUR (24) FOOT IF SINGLE ENTRANCE TO SITE.
- 5. FILTER CLOTH WILL BE PLACED OVER THE ENTIRE AREA PRIOR TO PLACING OF STONE.
- 6. SURFACE WATER ALL SURFACE WATER FLOWING OR DIVERTED TOWARD CON-STRUCTION ENTRANCES SHALL BE PIPED ACROSS THE ENTRANCE. IF PIPING IS IMPRACTICAL, A MOUNTABLE BERM WITH 5:1 SLOPES WILL BE PERMITTED.
- 7. MAINTENANCE THE ENTRANCE SHALL BE MAINTAINED IN A CONDITION WHICH WILL PREVENT TRACKING OR FLOWING OF SEDIMENT ONTO PUBLIC RIGHTS-OF-WAY, ALL SEDIMENT SPILLED, DROPPED, WASHED OR TRACTED ONTO PUBLIC RIGHTS-OF-WAY MUST BE REMOVED IMMEDIATELY.
- 8. WHEN WASHING IS REQUIRED, IT SHALL BE DONE ON A AREA STABILIZED WITH STONE AND WHICH DRAINS INTO AN APPROVED SEDIMENT TRAPPING DEVICE.
- 9. PERIODIC INSPECTION AND NEEDED MAINTENANCE SHALL BE PROVIDED AFTER EACH RAIN.

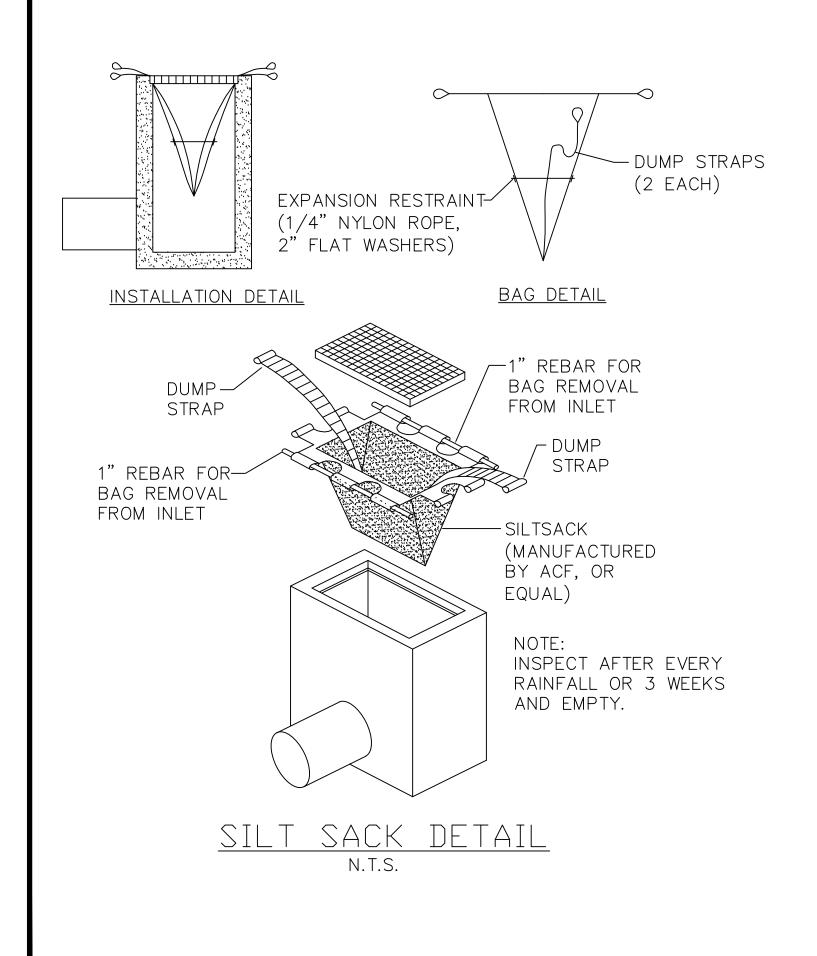


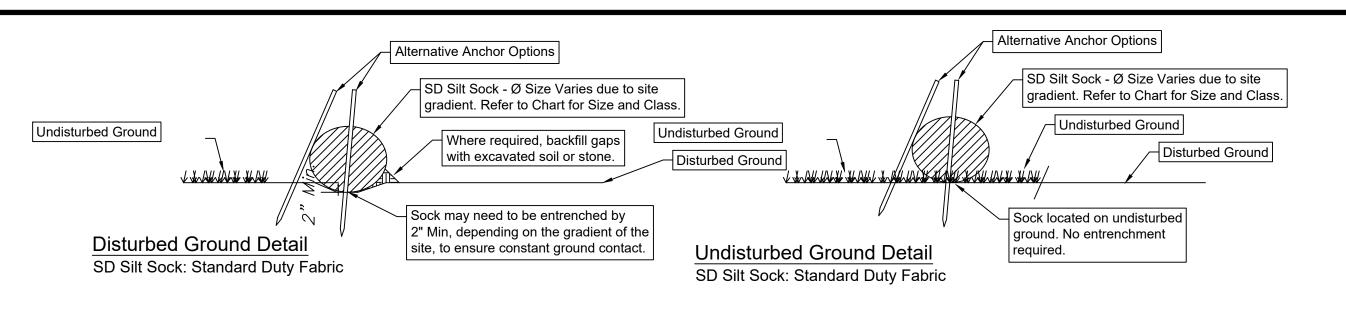

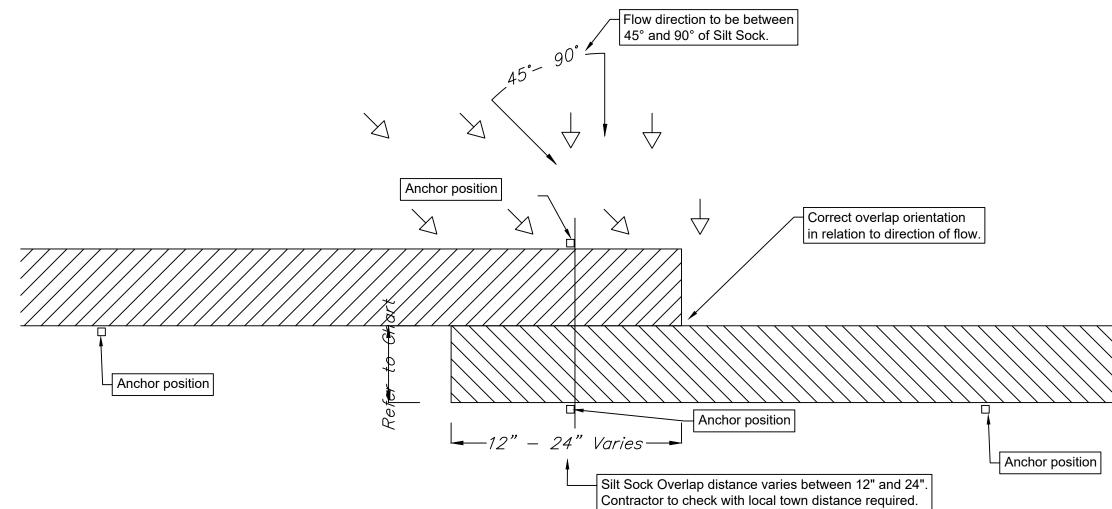


Overlap Detail - PLAN

1) Anchors required at the overlap section are to stay outside the Silt Sock and not pierce through the material. See alternative anchor positons in details above.

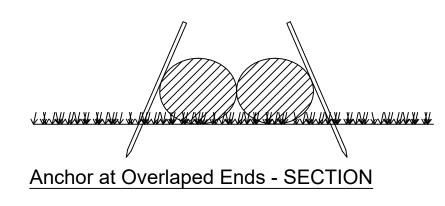

Size & Clas	ss Cha	ırt			
	Diameter				
Gradient	8"	12"	18"		
0 - 2%	30	55	75		
2.1 - 5%	25	40	55		
5.1 - 10%	15	30	40		
10.1 - 33%	10	15	20		
> 33%	5	10	15		

SD SILT SOCK DETAIL SD Silt Sock: Standard Duty Fabric

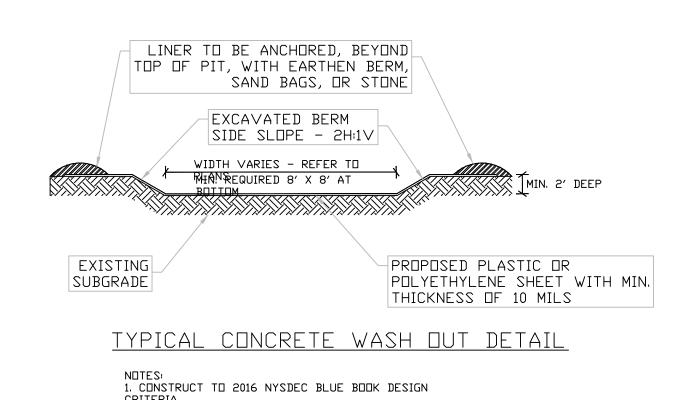

- 1 Do not use sock below the normal watermark or perpendicular to flow in river and where the maximum incline is greater than 50%.
- 2 Contractors should be aware of federal, state and local laws, rules regulations or permit requirements for the use of Silt Socks on site.
- 3 Sock should be positioned on the outline of the area to be protected, but must be installed between 45° to 90° from directions of flow.
- 4 Sock may be required to be entrenched a minimum of 2" on disturbed ground to ensure constant ground contact.
- 5 All gaps and ruts must be backfilled with soil or sock material.
- 6 Sock overlap should be in the direction of the flow. Overlap amount will be between 12" and 24". Contractor to check with local town for requirements.
- 7 If sediment collects to 1/2 the height of the sock, then a second sock may be stacked immediately up slope of the original instead of removing the sediment.
- 8 Sock joint is where two sock sections meet on a level grade, overlap and adjoining ends, tightening the ends together, and anchoring through each end. Where two sections meet on un-level ground, j-hook higher elevated end, anchor, and begin new section just below. Back fill any gaps.
- 9 Sock should be inspected and repaired as needed.
- 10 If ruts begin under the sock they should be backfilled with soil and compacted so that the ground and sock have continuous contact.
- 11 If sock rolls out of place, the sock should be repositioned and secured with additional
- 12 Tears in the Sock fabric may be repaired by wrapping a new piece of fabric over the sock and securing, or by place a second sock immediately up slope with the required overlap beyond deformation.
- 13 A section of sock should be replaced whenever it has weakened to such an extent that the efficiency is reduced or diminished. Weakening can occur because the natural mesh fabric breaks down over time of from being moved/dragged on site.
- 14 Sock should be replaced when sediment has built up and has been removed three
- 15 All sediment in disturbed area next to sock must be removed and correctly disposed of

OFFICIAL TOWN USE ONLY

- before the sock can be removed. 16 - When removing, cut sock open and spread the filler material around. The netting
- should be removed from site.
- 17 Sock should be installed before works commence on site.

DRAWING REVISIONS: No. DATE BY REMARKS

SPECIAL INFORMATION ALL CONTRACTORS SHALL GUARANTEE THEIR WORK FOR A PERIOD OF ONE YEAR FROM THE DATE OF OWNERS ACCEPTANCE.

SHOP DRAWING SUBMITTALS ARE REQUIRED FOR ANY

UNAUTHORIZED ALTERATIONS OF THIS DOCUMENT ARE IN VIOLATION OF SECTION #7209 OF THE STATE

CONSTRUCTION SET





PROPERTY NUMBER: #5202

nyder

AREA:

St. er

Ш

S

0

PA

CONSULTANT

JAMES ALLEN RUMSEY ARCHITECT

DEVELOPMENT 570 DELAWARE AVE., BUFFALO, NY 14202 (716) 886-0211





Demolition and Erosion **Control Details**

NTS DRAWN BY DMZ

DATE: 04.16.2025

DRAWING NO. CHECKED BY MAO



	REQUIRED	PROVIDED TI-2.5 (Village Frontage)	
ZONED	TI-2.5 (Village Frontage)		
6A-1-3: TI-2.5 Traditional Infill 2.5 S	ection		
LOT			
Area	0 S.F. min.	34,542 S.F.	
Width	0' min.	170.7'	
Outdoor Amenity Space	10% min. = 3,454 S.F.	3,560 S.F. = 10.3%	
BUILDING SETBACKS			
Building-to-zone	Refer to Section 5A-2 Infill Frontages		
Lot Frontage	Refer to Section 5A-2 Infill Frontages		
Common lot line	0' min.	0.6' (North Side)	
Alley	5' min.	N/A	
PARKING SETBACKS			
Primary and Side Street	Refer to Section 5A-2 Infill Frontages (below)		
Common lot line	0' min.	1.3' (North Side)	
Alley	5' min.	N/A	
BUILDING HEIGHT			
Top Plate Height	2 Stories / 24' max.	N/A	
Building Height	2.5 Stories / 35' max.	35'-0"	
Roof Pitch	18:12 max.	18:12	
BUILDING LENGTH	Refer to Section 5A-2 Infill Frontages (below)	168.5'	
STORY HEIGHT	Refer to Section 5A-2 Infill Frontages (below)	16.5'	

5A-2-4: Village Frontage			
BUILDING SETBACKS			
Build-to zone	0' min./10' max.	0.0'	
Street Frontage:			
Front: Main Street	90% min.	90.8% (168.5')	
PARKING SETBACKS			
Street	20' min.	52.8' (Main Street)	
BUILDING MASS			
Street facing building length:			
Front: Main Street	200' max.	168.5'	
STORY HEIGHT		_	
Ground floor elevation	0' min. / 2' max.	0.0'	
Ground story height	13' min.	16.5'	
Upper story height	9' min.	12.5'	
TRANSPARENCY			
Ground story	70% min.	70.1%	
Upper story	20% min.	41.0%	
Blank wall length	15' max.	4.0'	
PEDESTRIAN ACCESS			
Street facing entrance	Required	Complies	
Entrance spacing	50' max.	Complies	
STREETSCAPE			
Clear pedestrian zone	10' min.	10.21 Total - Eviating Condition	
Curb zone	6' min.	10.3' Total - Existing Condition	
Tree planting type	Grates	Complies	
Tree spacing	35' on-center avg.	Existing: 33.3' c-c Average	

	,	$\overline{}$		
		PROPOSED F	PARKING ANAYLSIS	3 TI-2.5
		USE	CODE	RI
			0000	
		RETAIL	2.5/1000 SF	12,28
•		CTALL CIZE		
	,	STALL SIZE		
	ļ			


PROVIDED

77 SPACES

9'x19'


12,285 sqft / 1000 x 2.5 = 31 SPACES


9'x19'

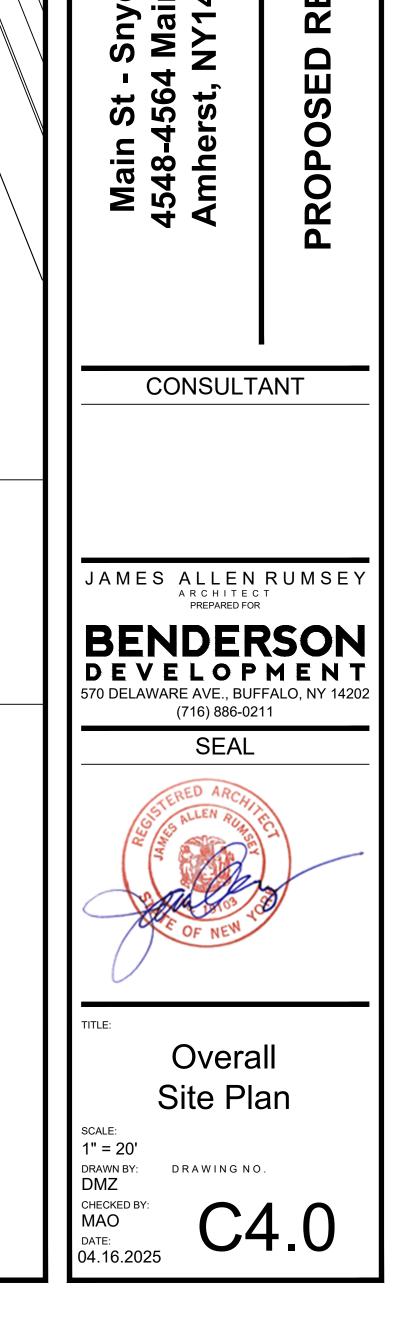

CONSTRUCTION SET

Proposed Outdoor Amenity Space

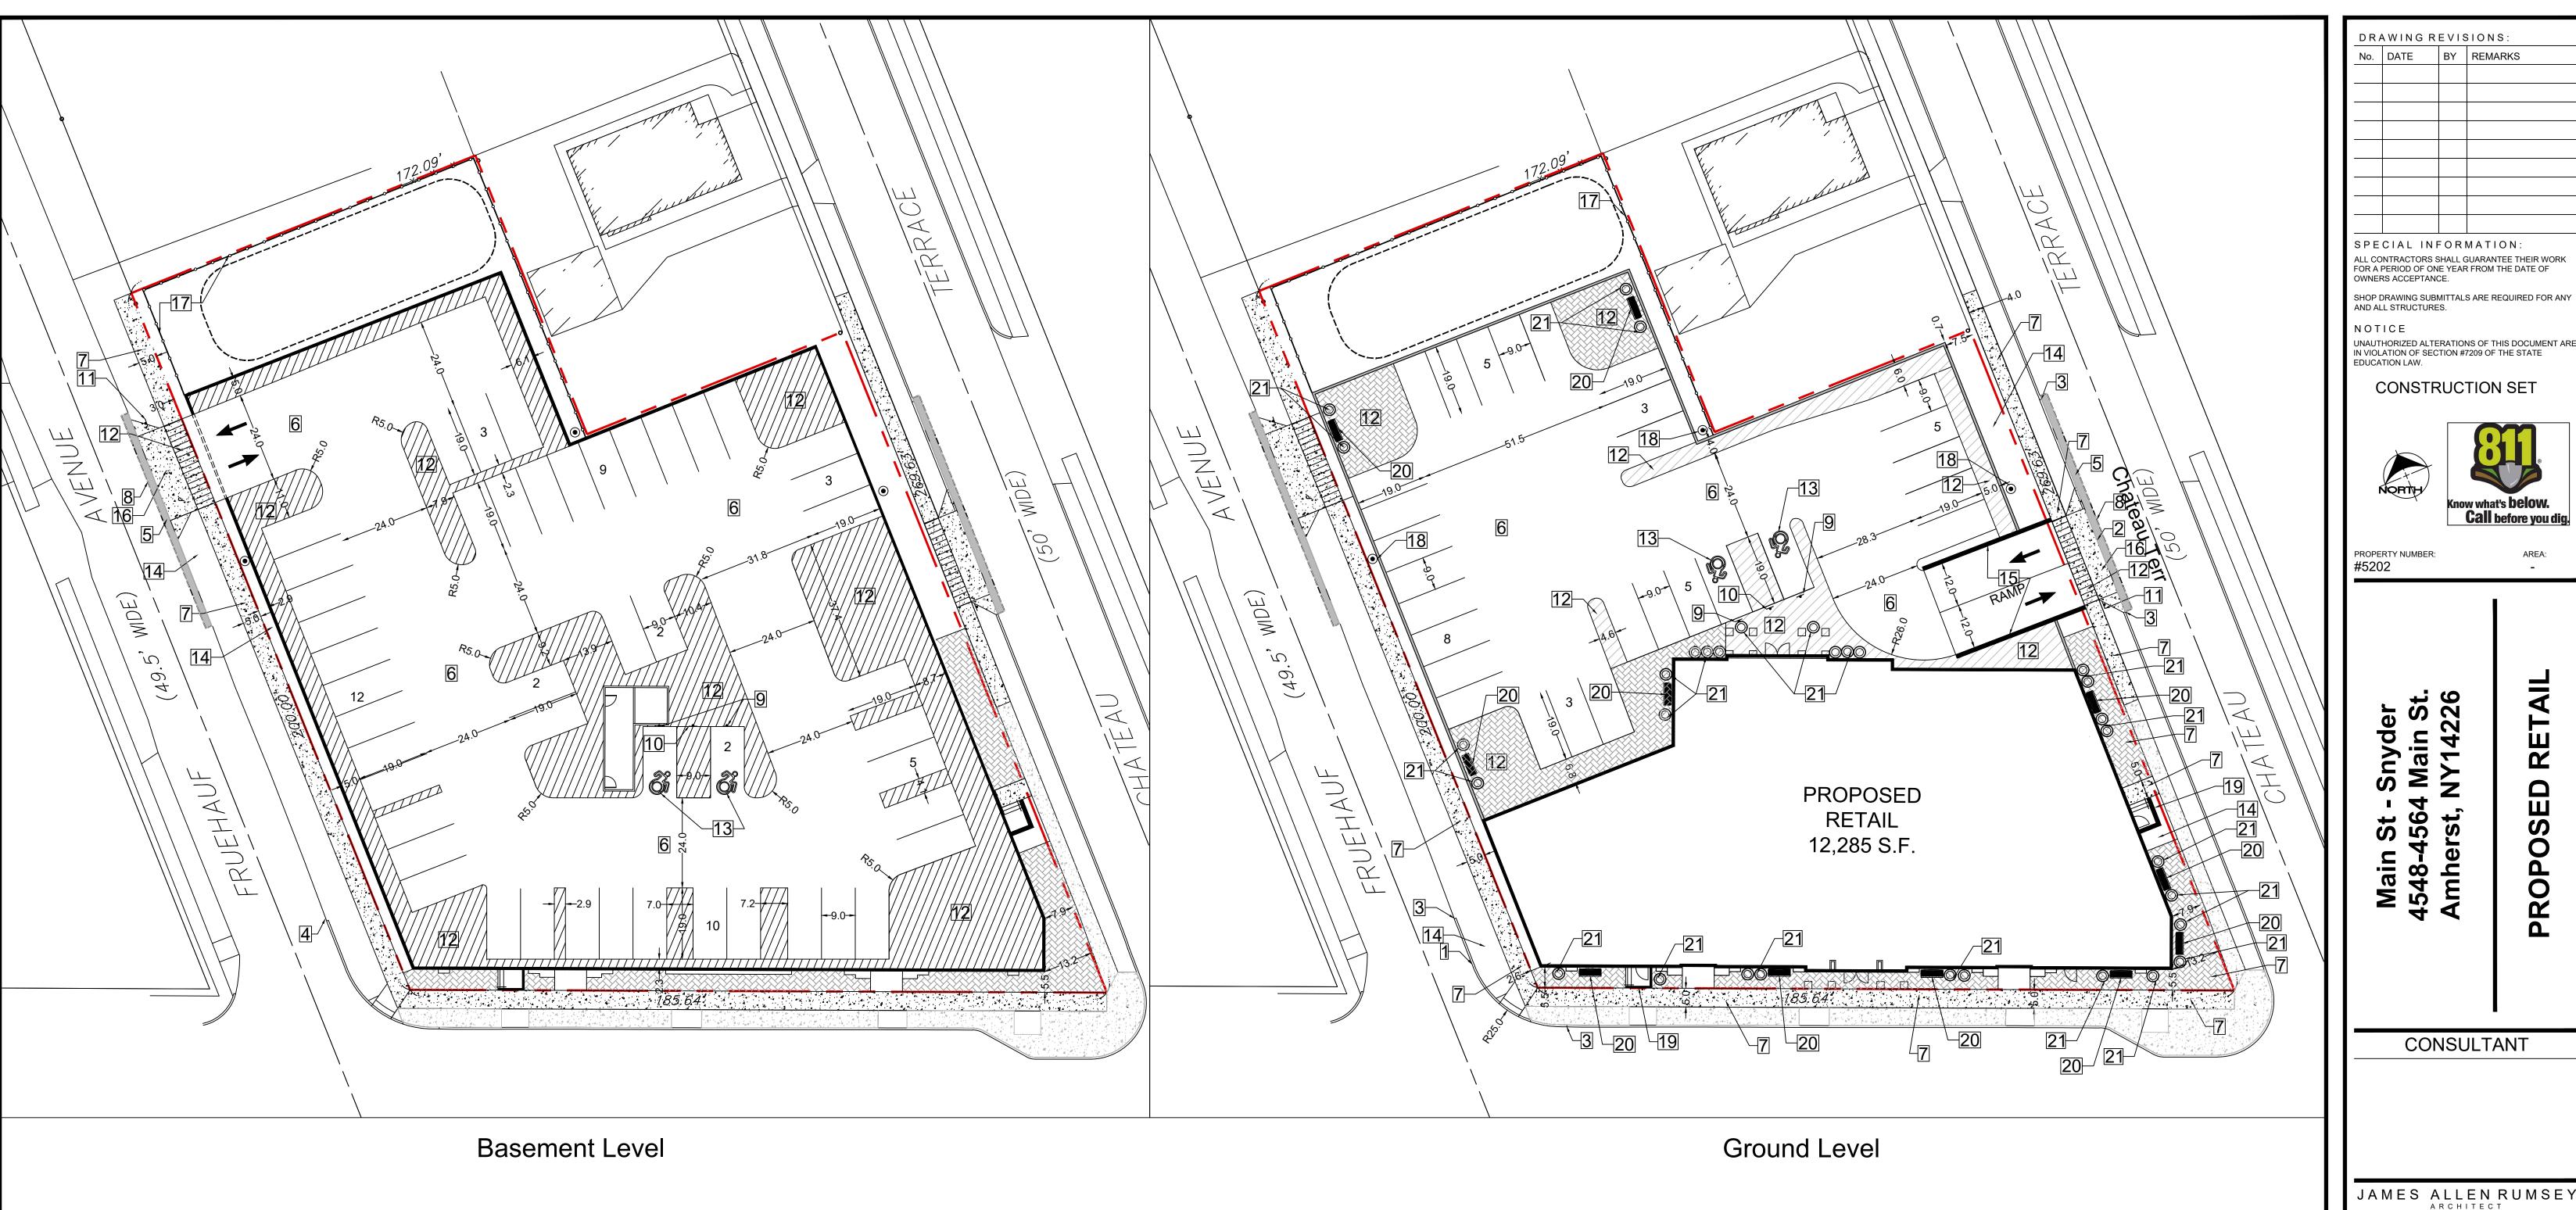

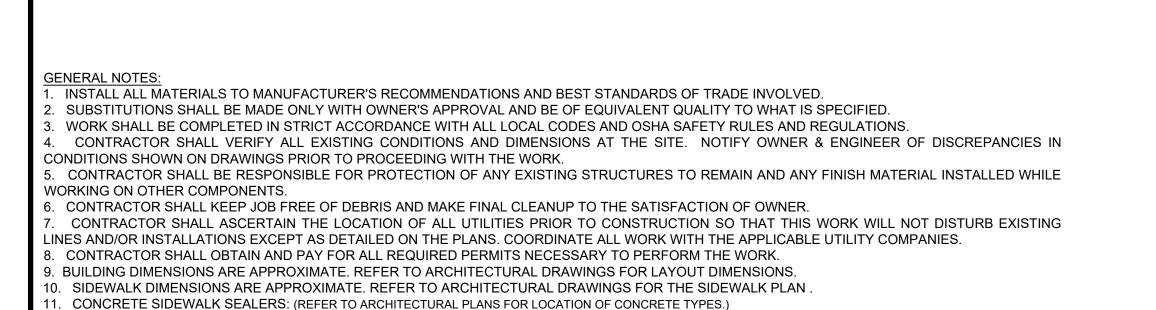


11.1. GREY CONCRETE SIDEWALKS SHALL HAVE CHEMMASTERS - SILENCURE WITHIN 2HRS AFTER FINAL FINISHING OF CONCRETE AND ALL 11.2. EXPOSED AGGREGATE/STAMPED CONCRETE SIDEWALKS SHALL HAVE ONE (x1) COAT CHEMMASTERS - SILENCURE AS SOON AS CONCRETE HAS DRIED AFTER PRESSURE-WASHING THE RELEASE AGENT OFF. APRX 30 DAYS AFTER THIS (IF WEATHER PERMITS) APPLY ONE (x1) COAT OF

12. LIGHTING FIXTURE ARROW SYMBOLS REFER TO THE DIRECTION THAT THE FIXTURES ARE REQUIRED TO FACE. SPECIFIC MOUNT BRACKETS WILL BE REQUIRED DEPENDING ON ORIENTATION AND FIXTURE COUNT.

13. CURB ISLAND DIMENSIONS ARE FROM INSIDE OF CURB TO INSIDE OF CURB.

14. CONTRACTOR TO PROVIDE NEW PAVEMENT THAT CONFORMS TO THE GRADING PLAN WHILE MAINTAINING, AS A MINIMUM, THE EXISTING STONE BASE. THE MEANS AND METHODS OF OBTAINING NEW GRADES IS LEFT UP TO THE CONTRACTOR AND CAN BE OBTAINED VIA SHIMMING THE PAVEMENT AND THEN A NEW TOP COAT, REMOVING EXISTING ASPHALT PAVEMENT AND REGRADING EXISTING STONE BASE, A COMBINATION OF THESE TWO OR ANOTHER METHOD OF THE CONTRACTORS CHOOSING. FINAL PAVEMENT WORK PLAN SHALL BE PROVIDED TO OWNER AND ENGINEER FOR REVIEW AND APPROVAL

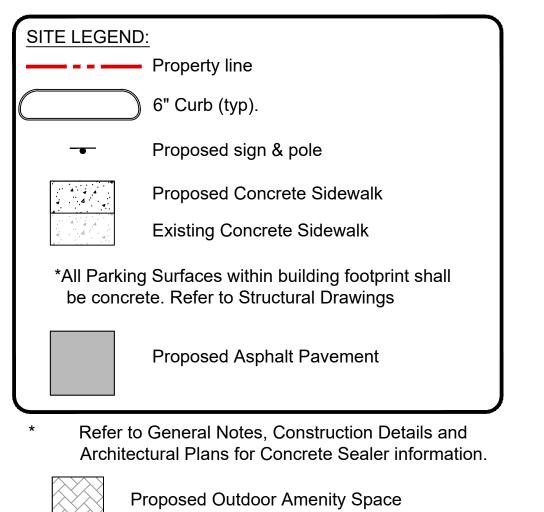

1. Proposed 6" concrete Curb. 2. Proposed Flush Concrete Curb. 3. Match into Existing Curb or runout over 2'. 4. Proposed Edge of Pavement. 5. Proposed Standard Duty Pavement. 6. Proposed Concrete Deck / Pavement. Refer to Structural Drawings Proposed Concrete Sidewalk. Match into Existing Pavement. Proposed "Handicapped Parking Only" sign. 10. Proposed "No Parking" sign. 11. Proposed STOP Sign. 12. 4" Yellow Pavement Stripe (at 2' c-c in no parking 13. Proposed White Pavement symbol (stop bar, directional arrows, accessibility symbol, text) 14. Proposed Landscape Area. 15. Proposed Ramp Retaining Wall (Refer to Structural Plans) 16. Proposed Concrete Driveway. 17. Proposed Board on Board Fence 18. Proposed Light Pole base. 19. Proposed Stairs with retaining wall. 20. Proposed Pedestrian Bench 21. Proposed Circular Landscape Planter

OFFICIAL TOWN USE ONLY


SITE NOTES: #

CONSULTANT JAMES ALLEN RUMSEY ARCHITECT **BENDERSON** 570 DELAWARE AVE., BUFFALO, NY 14202 (716) 886-0211 SEAL Detailed Site Plan 1" = 20' DRAWN BY: DRAWING NO. DMZ DATE: **04.16.2025**

No. DATE BY REMARKS

CONSTRUCTION SET

0

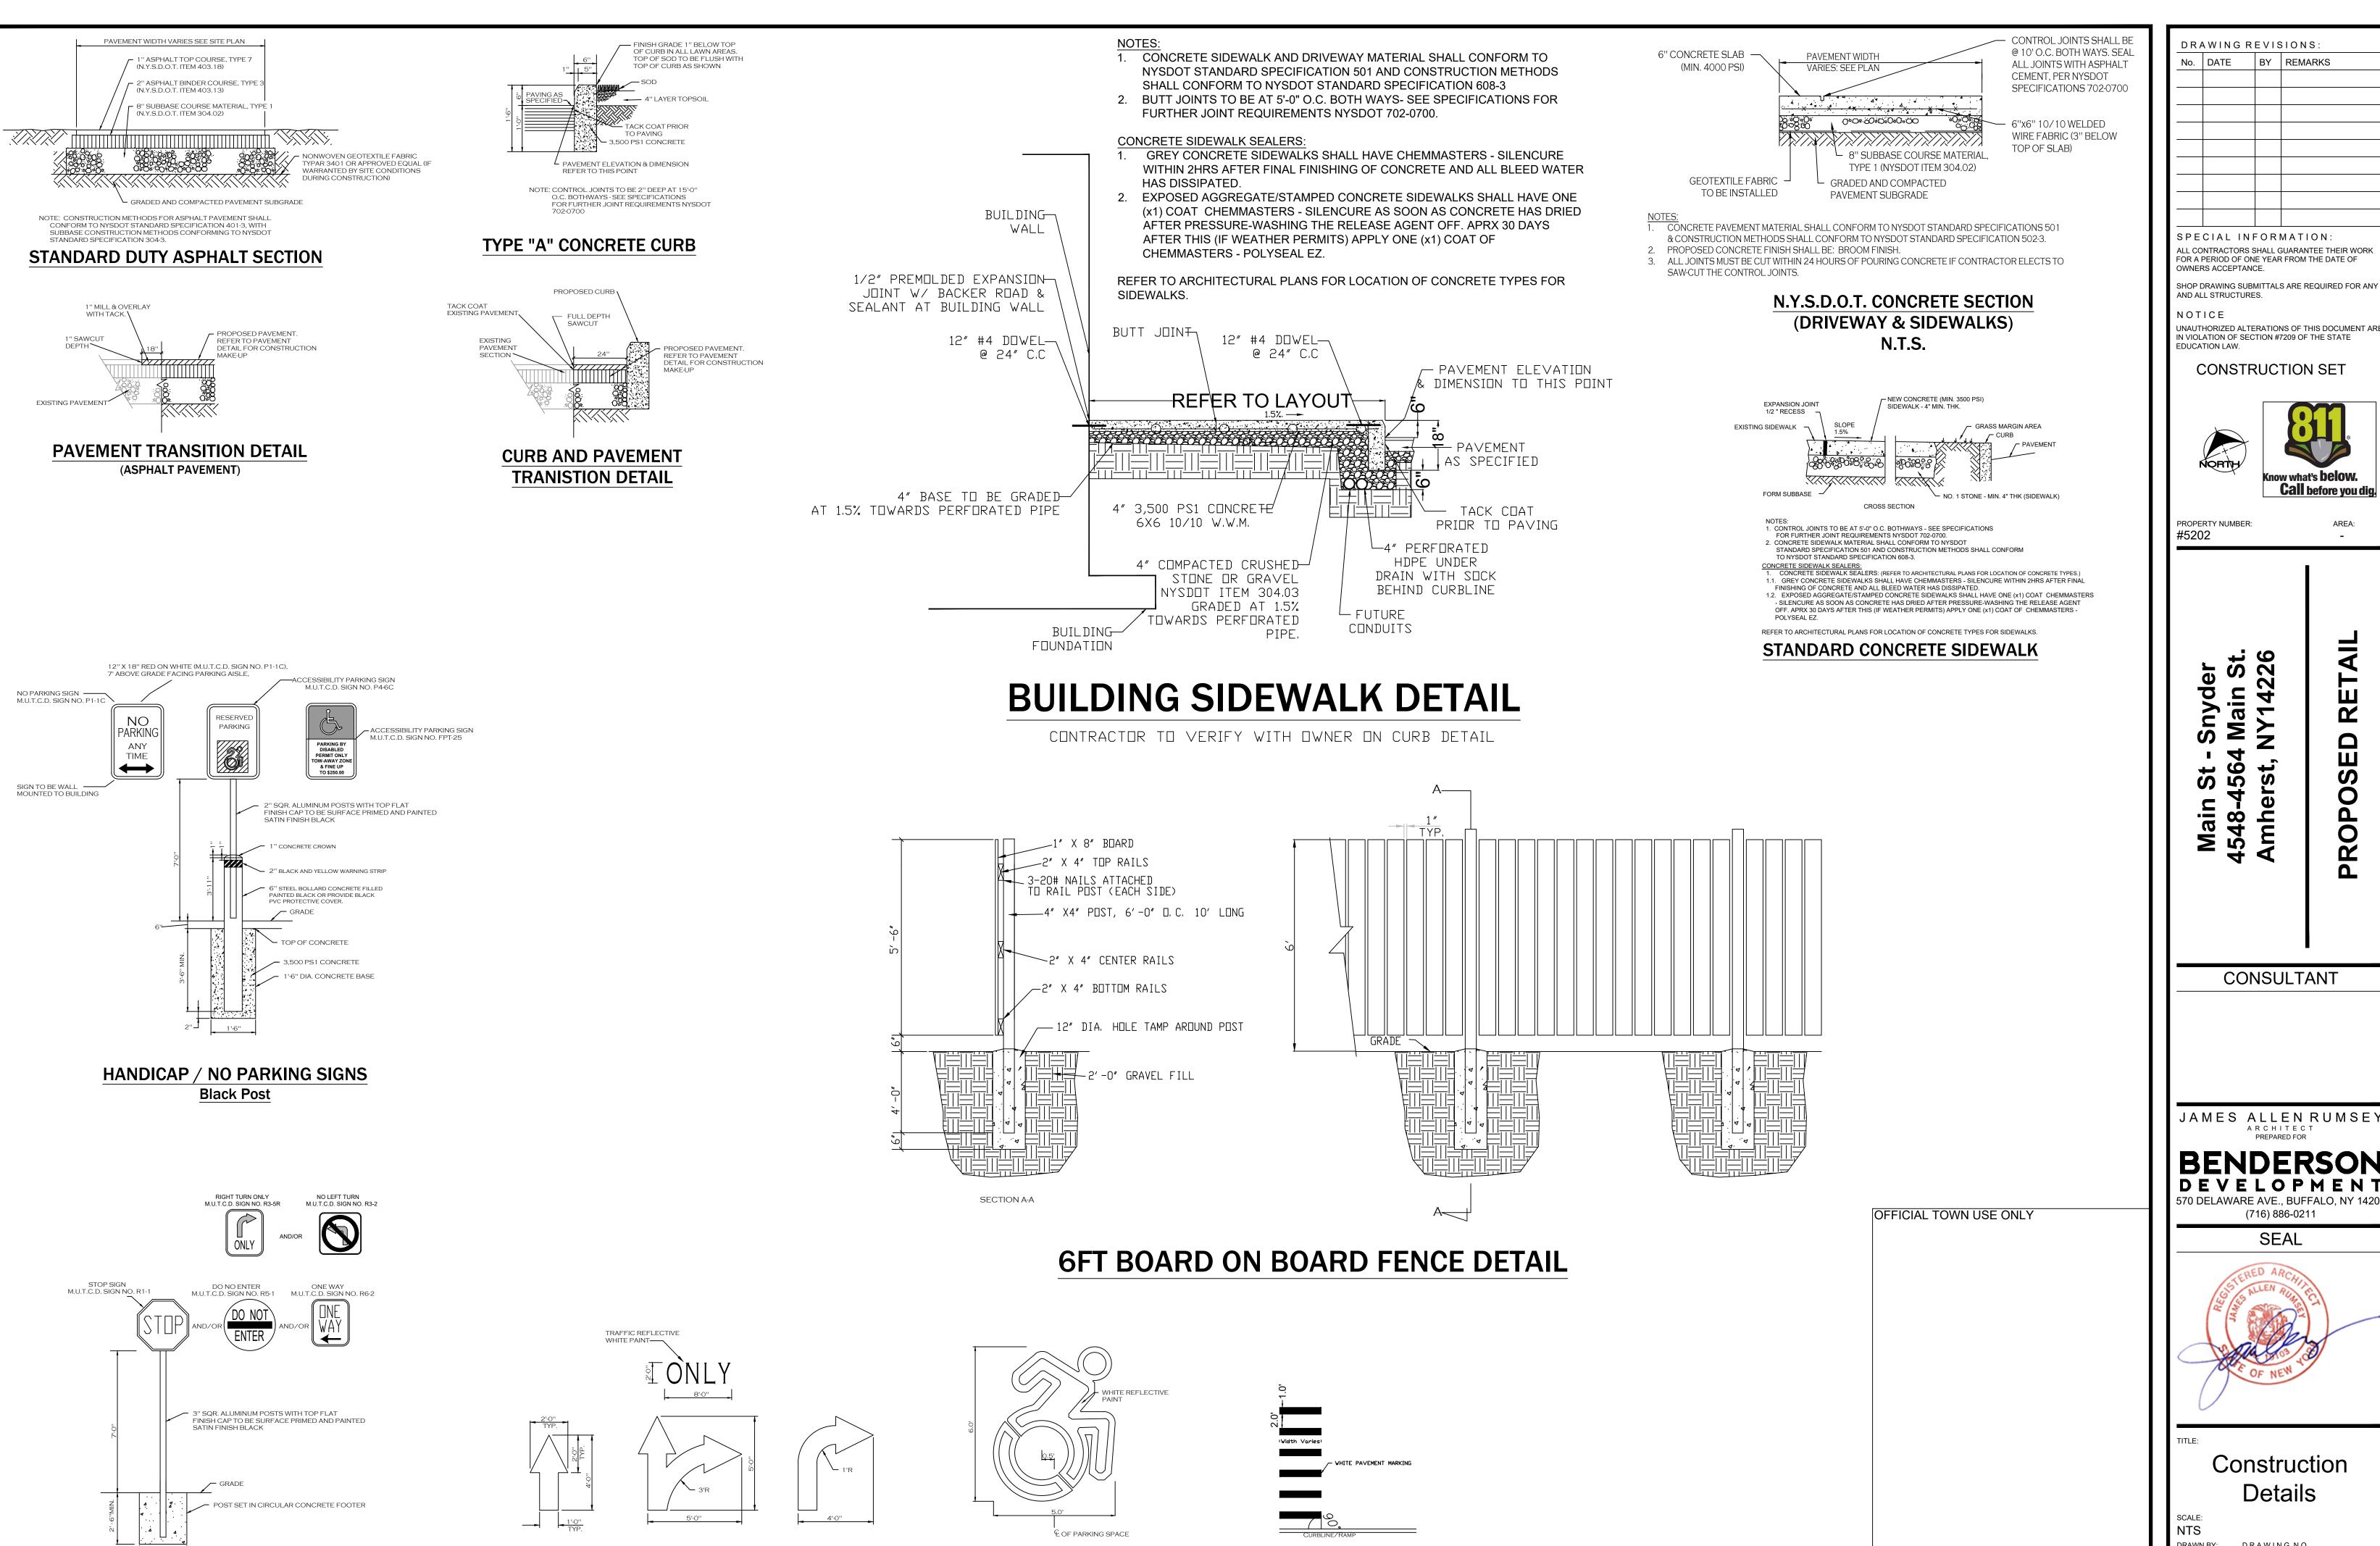

INTERNATIONAL ACCESSIBILITY

SYMBOL

PAINTED TRAFFIC ARROWS

"STOP" / "NO ENTRY" / "ONE WAY" SIGNS

Black Post and Footer

PEDESTRIAN CROSSWALK

DRAWING REVISIONS: No. DATE BY REMARKS

> SPECIAL INFORMATION ALL CONTRACTORS SHALL GUARANTEE THEIR WORK FOR A PERIOD OF ONE YEAR FROM THE DATE OF OWNERS ACCEPTANCE.

AND ALL STRUCTURES.

UNAUTHORIZED ALTERATIONS OF THIS DOCUMENT ARE IN VIOLATION OF SECTION #7209 OF THE STATE

CONSTRUCTION SET





AREA:

S

0

PROPERTY NUMBER:

CONSULTANT

JAMES ALLEN RUMSEY


SEAL





Construction Details

DRAWING NO. DRAWN BY:

04.16.2025

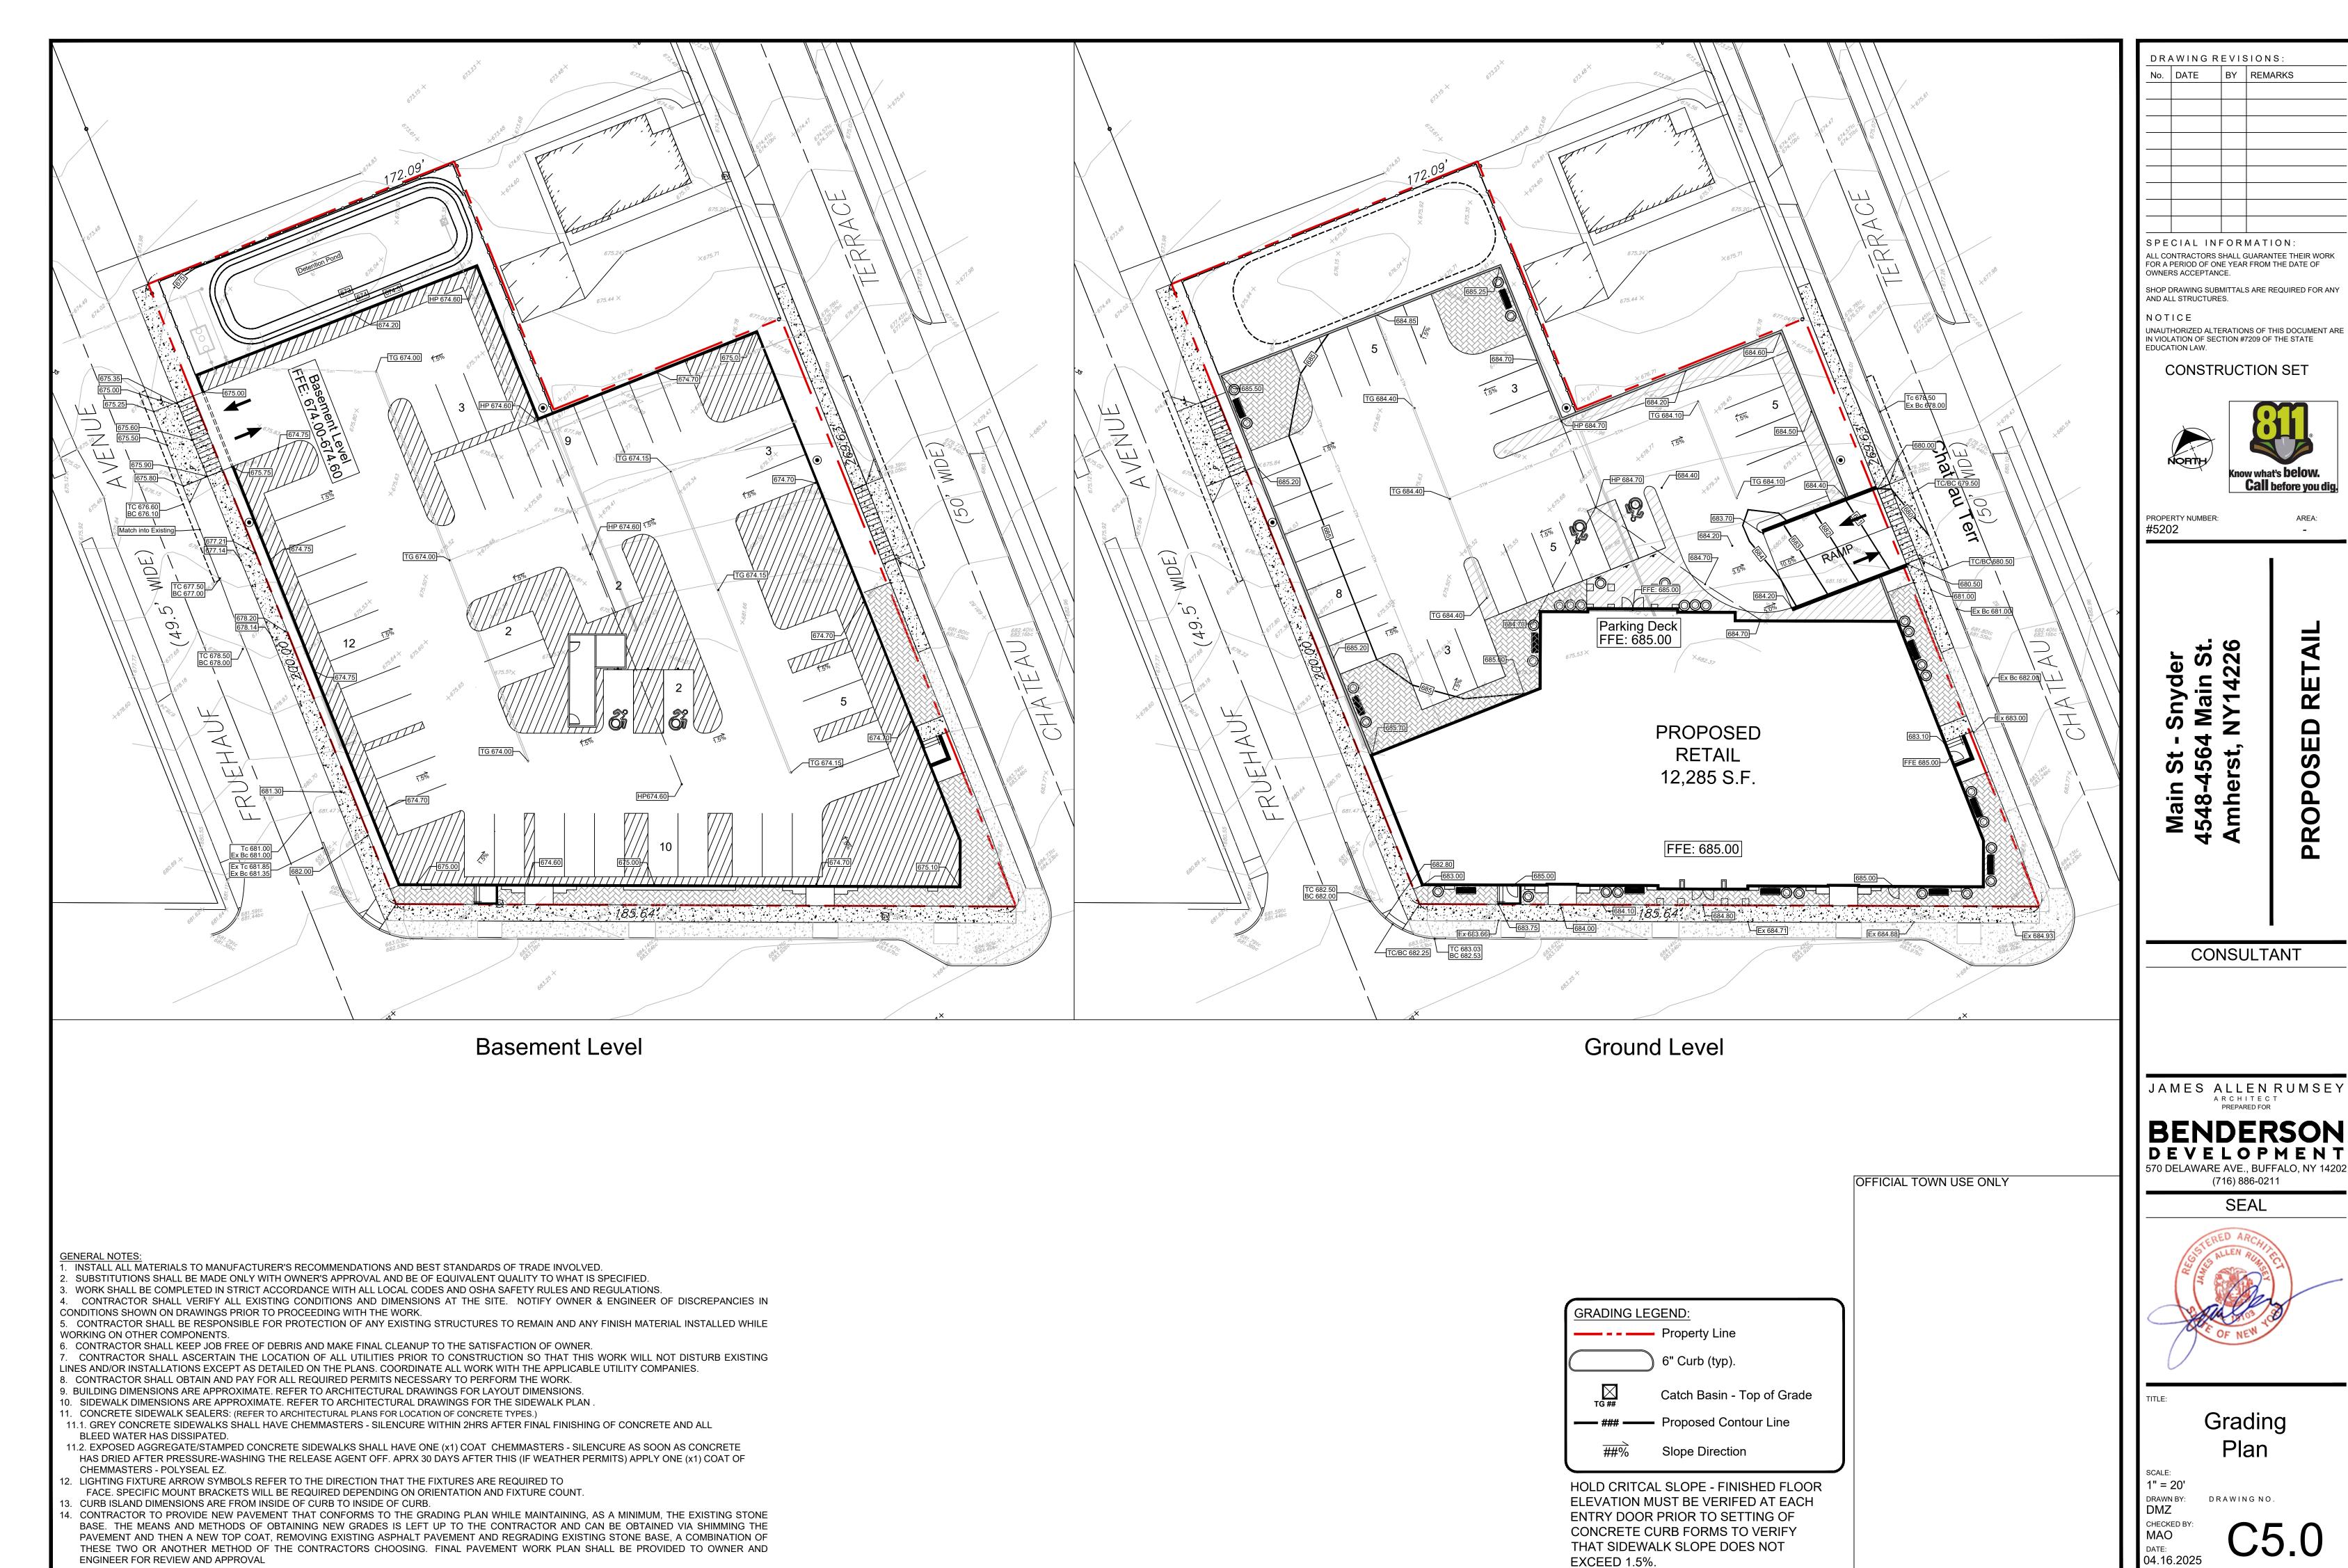

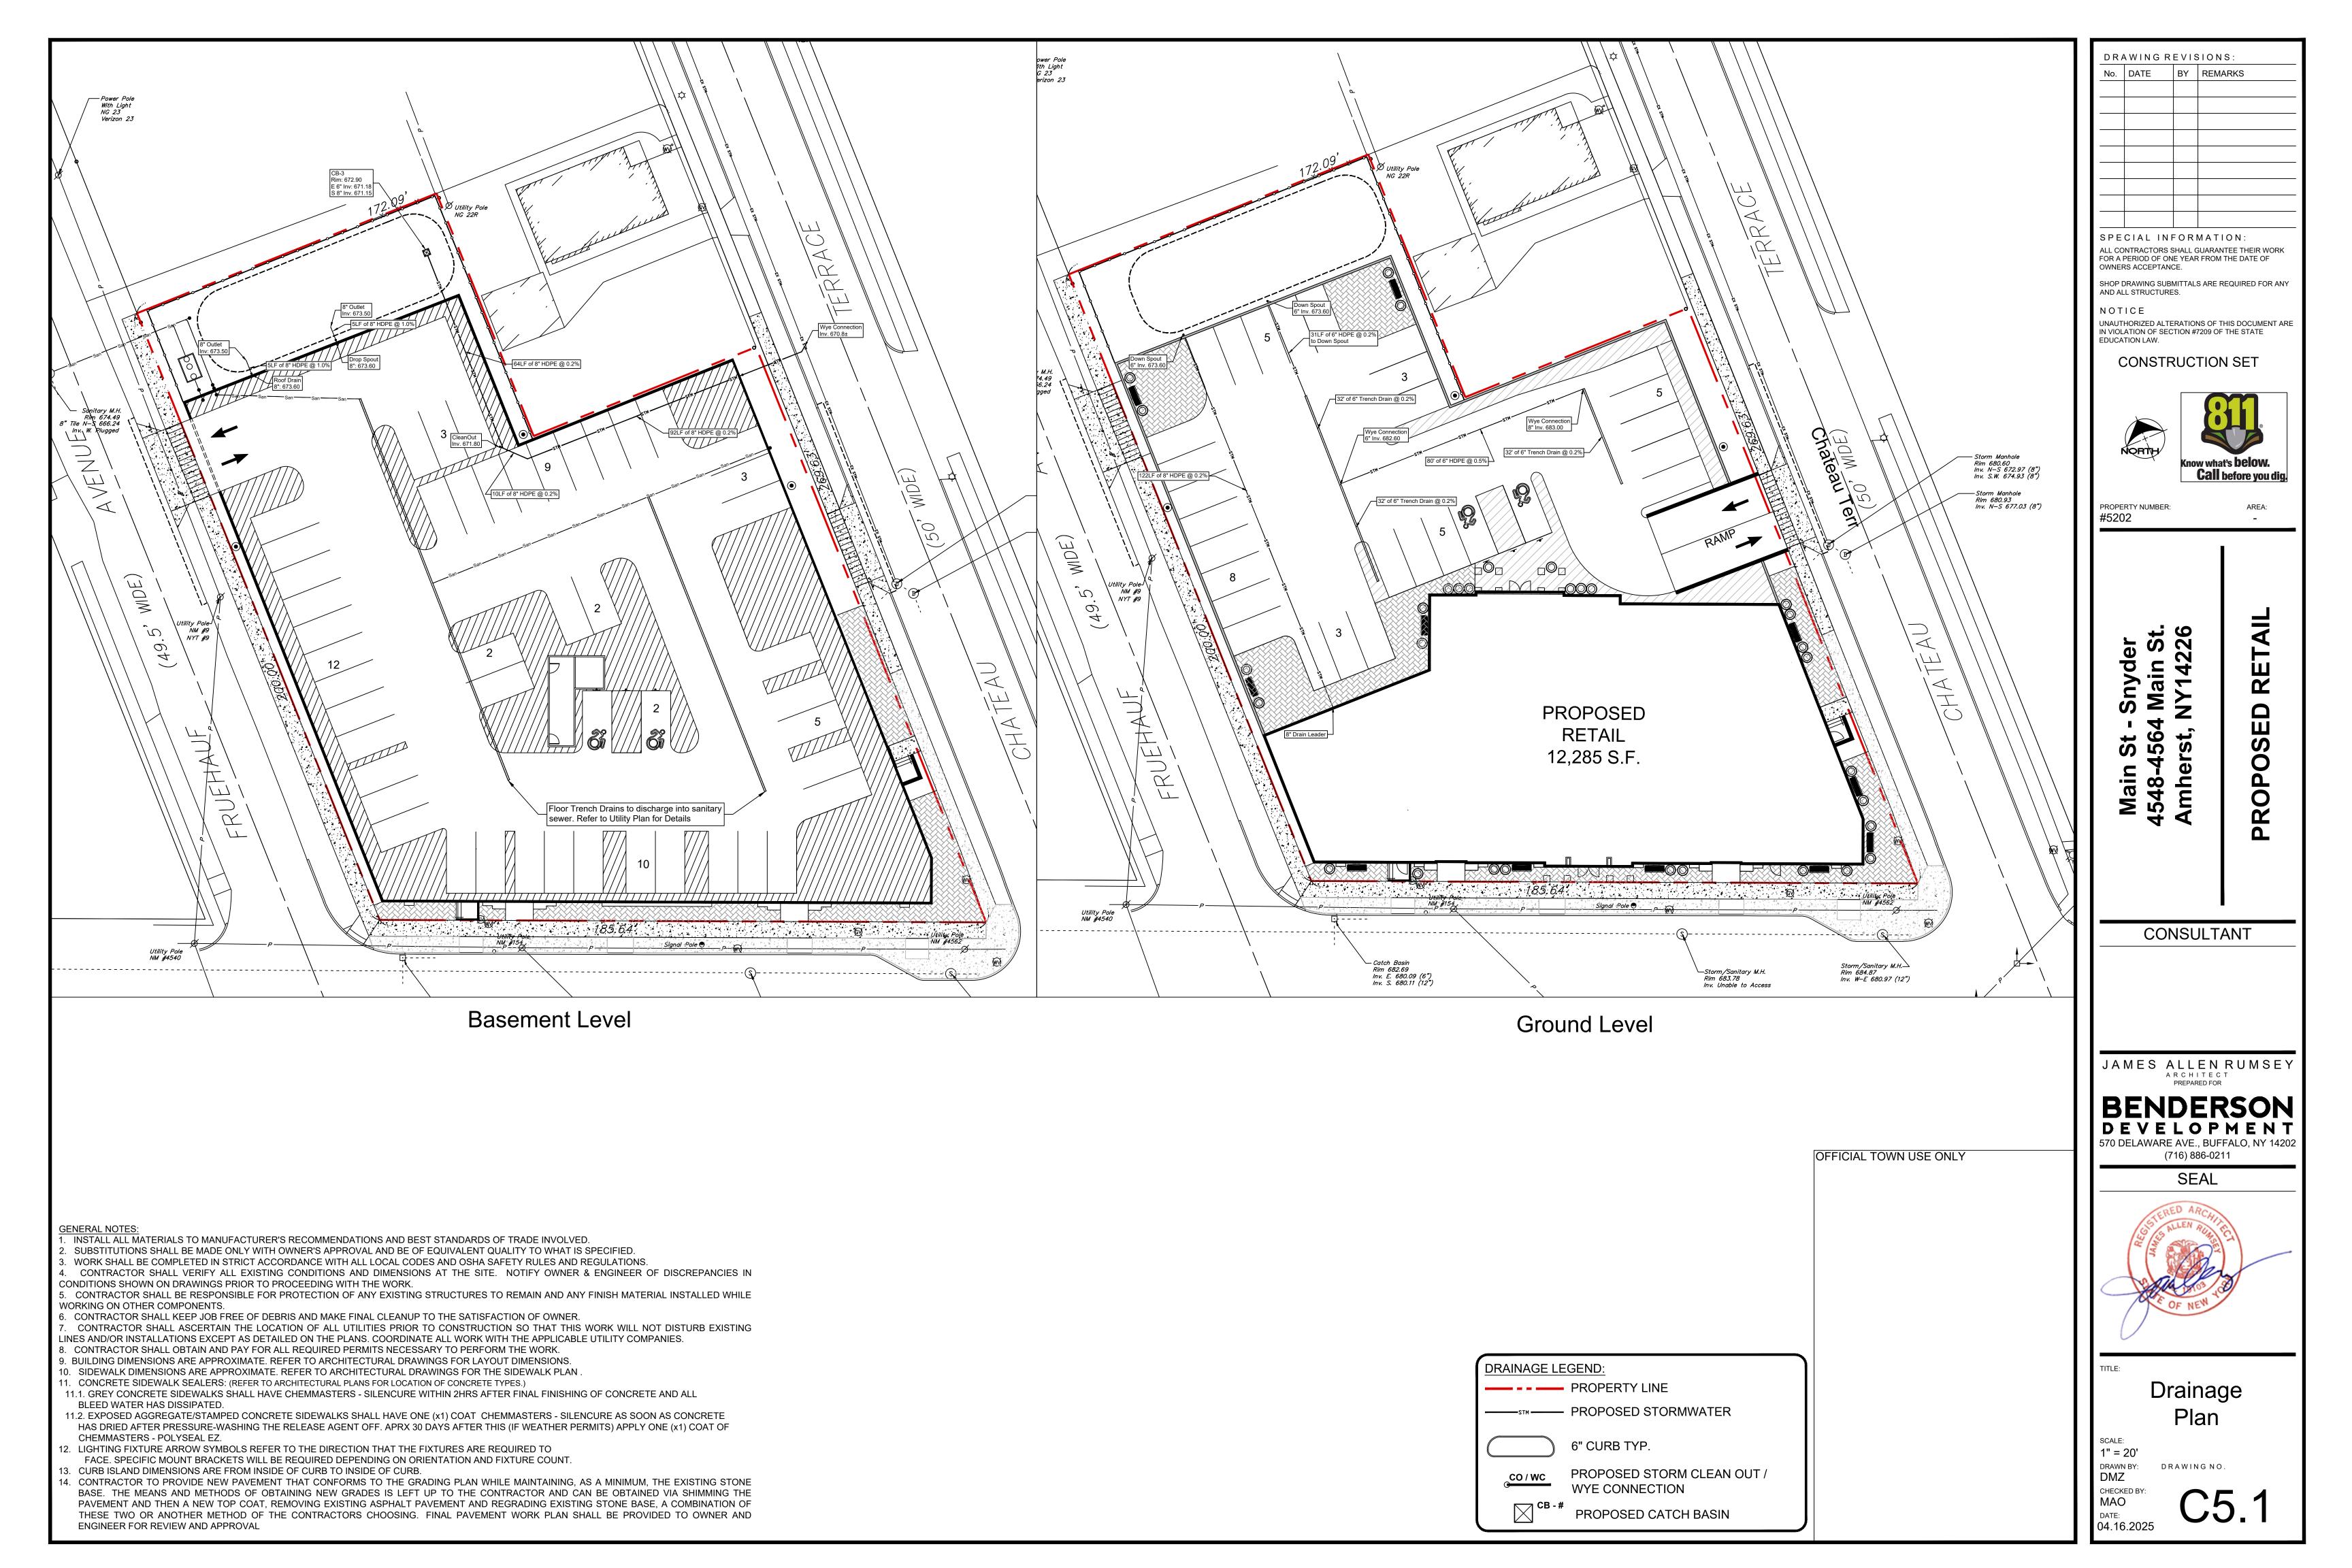

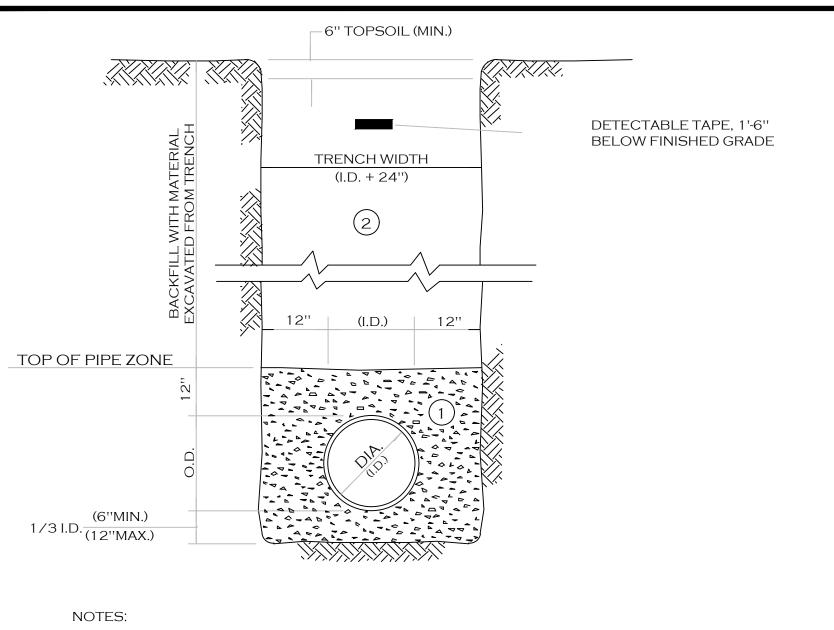

- A. PIPE INSTALLATION SHALL BE IN ACCORDANCE WITH MANUFACTURERS RECOMMENDATIONS.
- B. TRENCHING OPERATIONS SHALL INCLUDE ALL NECESSARY DEWATERING.
- C. TRENCH DETAILS ARE ONLY SHOWN FOR PURPOSES OF MATERIAL PLACEMENT AND MAXIMUM PAY LIMITS.
- D. AN OSHA APPROVED MOVABLE PROTECTIVE TRENCH SHIELD SHALL BE USED IN ALL UNSHEETED TRENCH AREAS.

MATERIALS


PIPE BEDDING MATERIAL (NYSDOT 1985 EDITION)

NO. 1 CRUSHED STONE OR CRUSHED GRAVEL WITH A GRADATION CONFORMING WITH NYSDOT SECTION 703-02. THE MATERIAL SHALL BE WELL GRADED WITH NO PARTICLES LARGER THAN ONE INCH AND HAVING A MAXIMUM GRADATION MEETING THE LIMITS DESCRIBED IN THE SPECIFICATIONS. THE BEDDING SHALL BE COMPACTED IN 6" LIFTS WITH EQUIPMENT ACCEPTABLE TO THE PIPE MANUFACTURER.


NO SLAG SHALL BE ALLOWED FOR MATERIAL 1

(2) BACKFILL MATERIAL COMPACTED IN 6" LIFTS. BACKFILL MATERIAL SHALL BE NATIVE SOIL CONTAINING NO UNSUITABLE MATERIAL


TRENCH SECTION **IN UNPAVED AREAS**

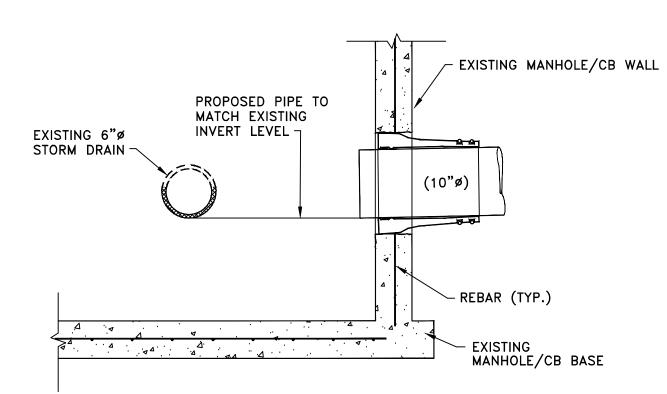

- 1. CORE DRILL ENTRANCE HOLE IN PRECAST MANHOLE BARREL, BASE AND/OR BENCH FOR REQUIRED PIPE CLEARANCE. PER MANUFACTURERS
- 2. DOES NOT APPLY TO HOUSE LATERALS.
- 3. WATERTIGHT PIPE TO MANHOLE BOOT SEAL REQUIRED FOR ALL CORE DRILLED ENTRANCE HOLES IN MANHOLE BARREL AS SHOWN BELOW.

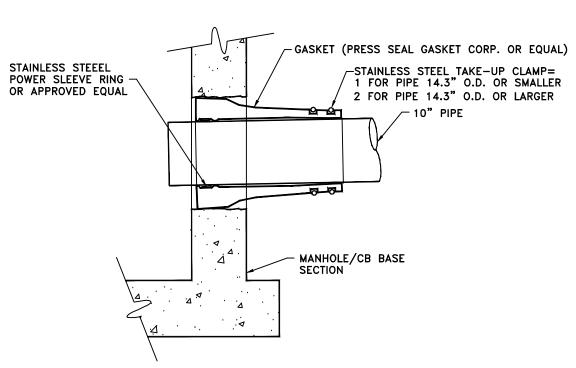

CONNECTION TO EXISTING MANHOLE/CB

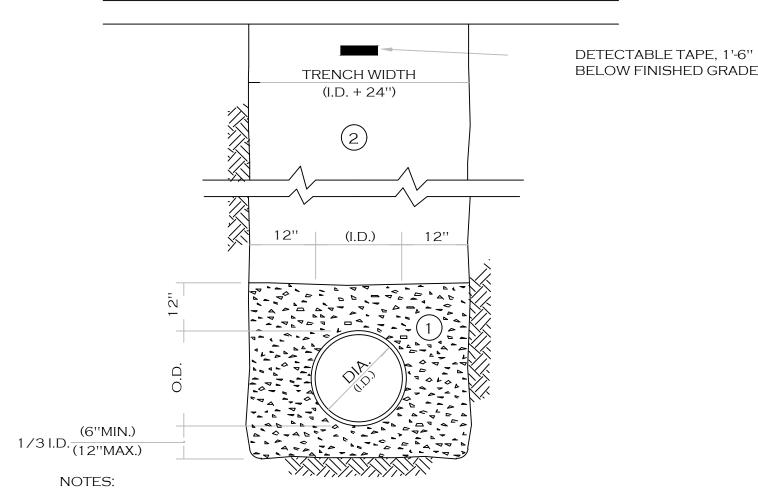

A. PIPE INSTALLATION SHALL BE IN ACCORDANCE WITH MANUFACTURERS RECOMMENDATIONS.

B. TRENCHING OPERATIONS SHALL INCLUDE ALL NECESSARY DEWATERING.

- C. TRENCH DETAILS ARE ONLY SHOWN FOR PURPOSES OF MATERIAL PLACEMENT AND MAXIMUM PAY LIMITS.
- D. AN OSHA APPROVED MOVABLE PROTECTIVE TRENCH SHIELD SHALL BE USED IN ALL UNSHEETED TRENCH AREAS.

MATERIALS

PIPE BEDDING MATERIAL (NYSDOT 1985 EDITION)

NO. 1 CRUSHED STONE OR CRUSHED GRAVEL WITH A GRADATION CONFORMING WITH NYSDOT SECTION 703-02. THE MATERIAL SHALL BE WELL GRADED WITH NO PARTICLES LARGER THAN ONE INCH AND HAVING A MAXIMUM GRADATION MEETING THE LIMITS DESCRIBED IN THE SPECIFICATIONS. THE BEDDING SHALL BE COMPACTED IN 6" LIFTS WITH EQUIPMENT ACCEPTABLE TO THE PIPE MANUFACTURER.

NO SLAG SHALL BE ALLOWED FOR MATERIAL (1)

TYPE 2 CRUSHED STONE OR CRUSHED GRAVEL WITH A GRADATION CONFORMING WITH NYSDOT SECTION 304-2.02 TYPE 2. THE MATERAIL SHALL BE WELL GRADED WITH NO PARTICLES LARGER THAN TWO INCHES AND HAVING A MAXIMUM GRADATION MEETING THE LIMITS DESCRIBED IN THE SPECIFICATIONS. THE BEDDING SHALL BE COMPACTED IN 6" LIFTS WITH EQUIPMENT ACCEPTABLE TO THE PIPE MANUFACTURER.

PLACE LIGHT STONE FILL

- 12" OF LIGHT STONE FILL NYSDOT ITEM 620.03

NO SLAG SHALL BE ALLOWED FOR MATERIAL (2)

TRENCH SECTION IN PAVED AREAS

STANDARD END SECTIONS-

<u>PLAN VIEW</u>

ELEVATION

A: 6" DIA = 2FT

B: 12" DIA = 4FT C: 18" DIA = 6FT

TYPICAL PIPE OUTLET W/END SECTION & RIP RAP


STORM PIPE W/END SECTIONS (SEE PLANS FOR SIZE AND TYPE)

NEW CULVERT W/END SECTIONS (SEE PLANS FOR SIZE AND TYPE)

PIPE BEDDING, SEE

TRENCH SECTION

NOT TO SCALE

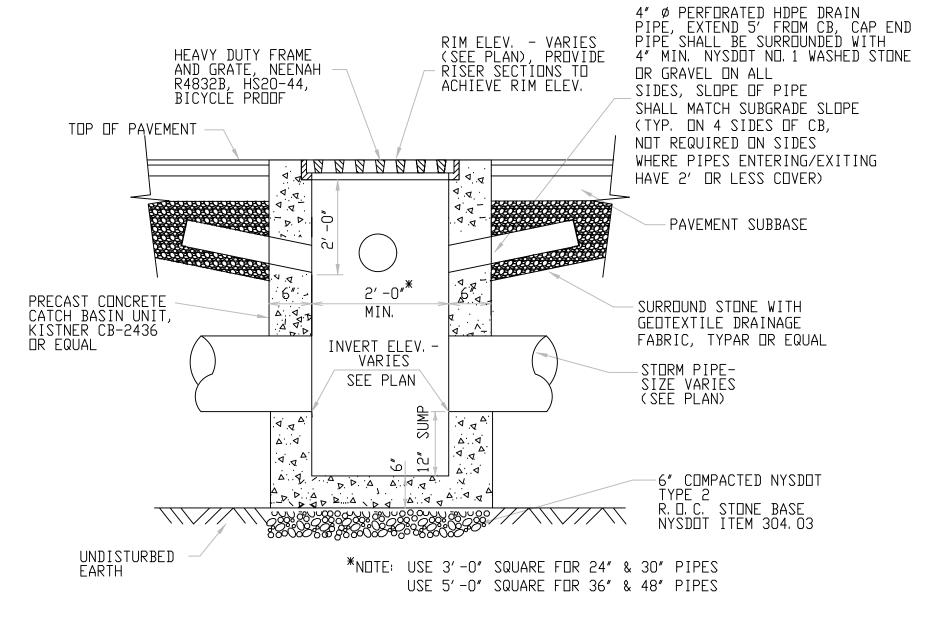

TYPICAL PRECAST CATCH BASIN

Dimensional data (inches and [mm]) are subject to manufacturing tolerances and change without notic 4 [102] MIN. 4 [102] MIN. -- OR SLAB - OR SLAB -THICKNESS **→** 4 [102] **→** 1³/₄ [44.5] $-5\frac{5}{8}$ [142.9]— $-6\frac{3}{8}$ [161.9] OR SLAB THICKNESS Z886 X-SECTION INSTALLATION GUIDE: -Install top of trench to final grade including grate

-Install channel guides

⚠WARNING: Cancer and Reproductive Harm - www.P65Warnings.ca.gov ♠ ADVERTENCIA: Cáncer y daño reproductivo - www.P65Warnings.ca.gov AVERTISSEMENT: Cancer et effets néfastes sur la reproduction - www.P65Warnings.ca.gov Zurn Industries, LLC | Specification Drainage Operation 1801 Pittsburgh Avenue, Erie, PA U.S.A. 16502 · Ph. 855-663-9876, Fax 814-454-7929 Date: 6/1/2018 C.N. No. 140094 In Canada | **Zurn Industries Limited** 3544 Nashua Drive, Mississauga, Ontario L4V 1L2 · Ph. 905-405-8272, Fax 905-405-1292

Form No. FT865

OFFICIAL TOWN USE ONLY

JAMES ALLEN RUMSEY ARCHITECT

CONSULTANT

DRAWING REVISIONS: No. DATE BY REMARKS

SPECIAL INFORMATION:

OWNERS ACCEPTANCE.

AND ALL STRUCTURES.

PROPERTY NUMBER:

Snyder *ain St.

#5202

ALL CONTRACTORS SHALL GUARANTEE THEIR WORK

SHOP DRAWING SUBMITTALS ARE REQUIRED FOR ANY

UNAUTHORIZED ALTERATIONS OF THIS DOCUMENT ARE IN VIOLATION OF SECTION #7209 OF THE STATE

Know what's **below.**

Call before you dig.

AREA:


Δ.

CONSTRUCTION SET

FOR A PERIOD OF ONE YEAR FROM THE DATE OF

570 DELAWARE AVE., BUFFALO, NY 14202 (716) 886-0211

SEAL

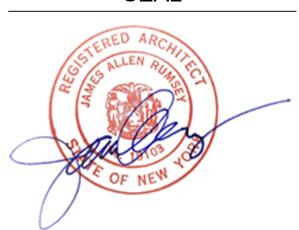



Drainage Details


NTS DRAWN BY: DMZ

DRAWING NO. CHECKED BY MAO DATE: 04.16.2025


DOTINSTALLATION GUIDE

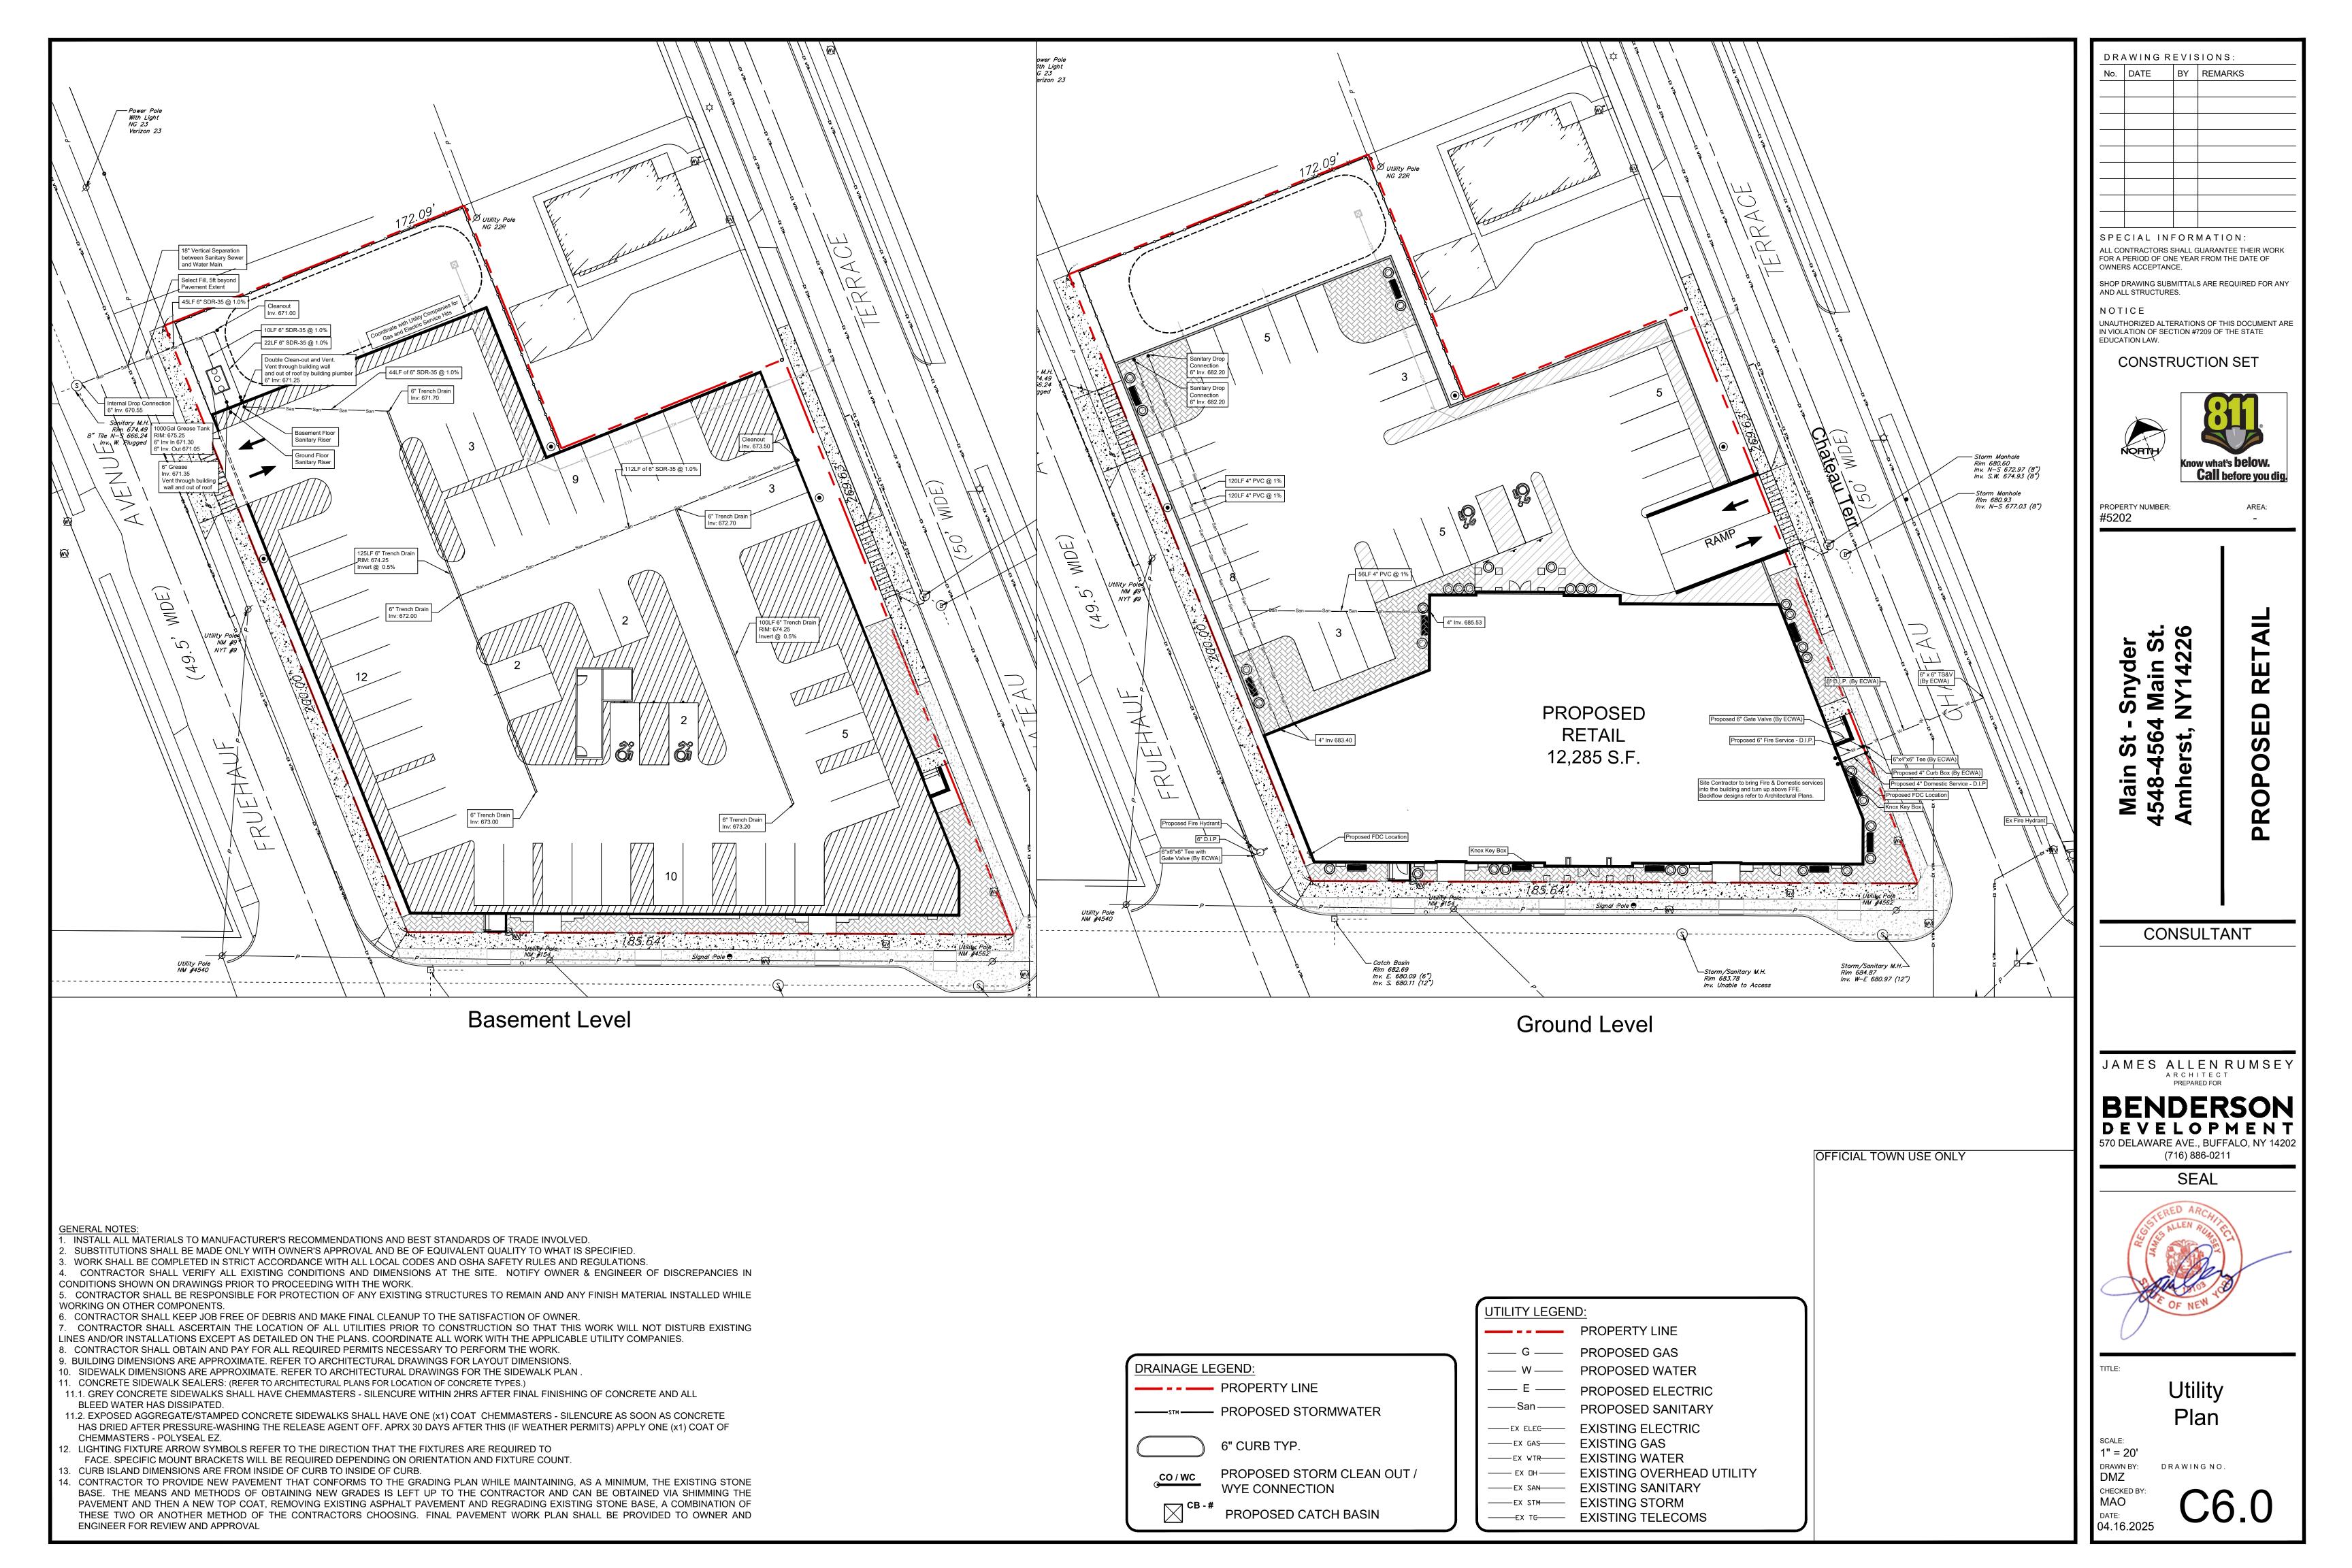

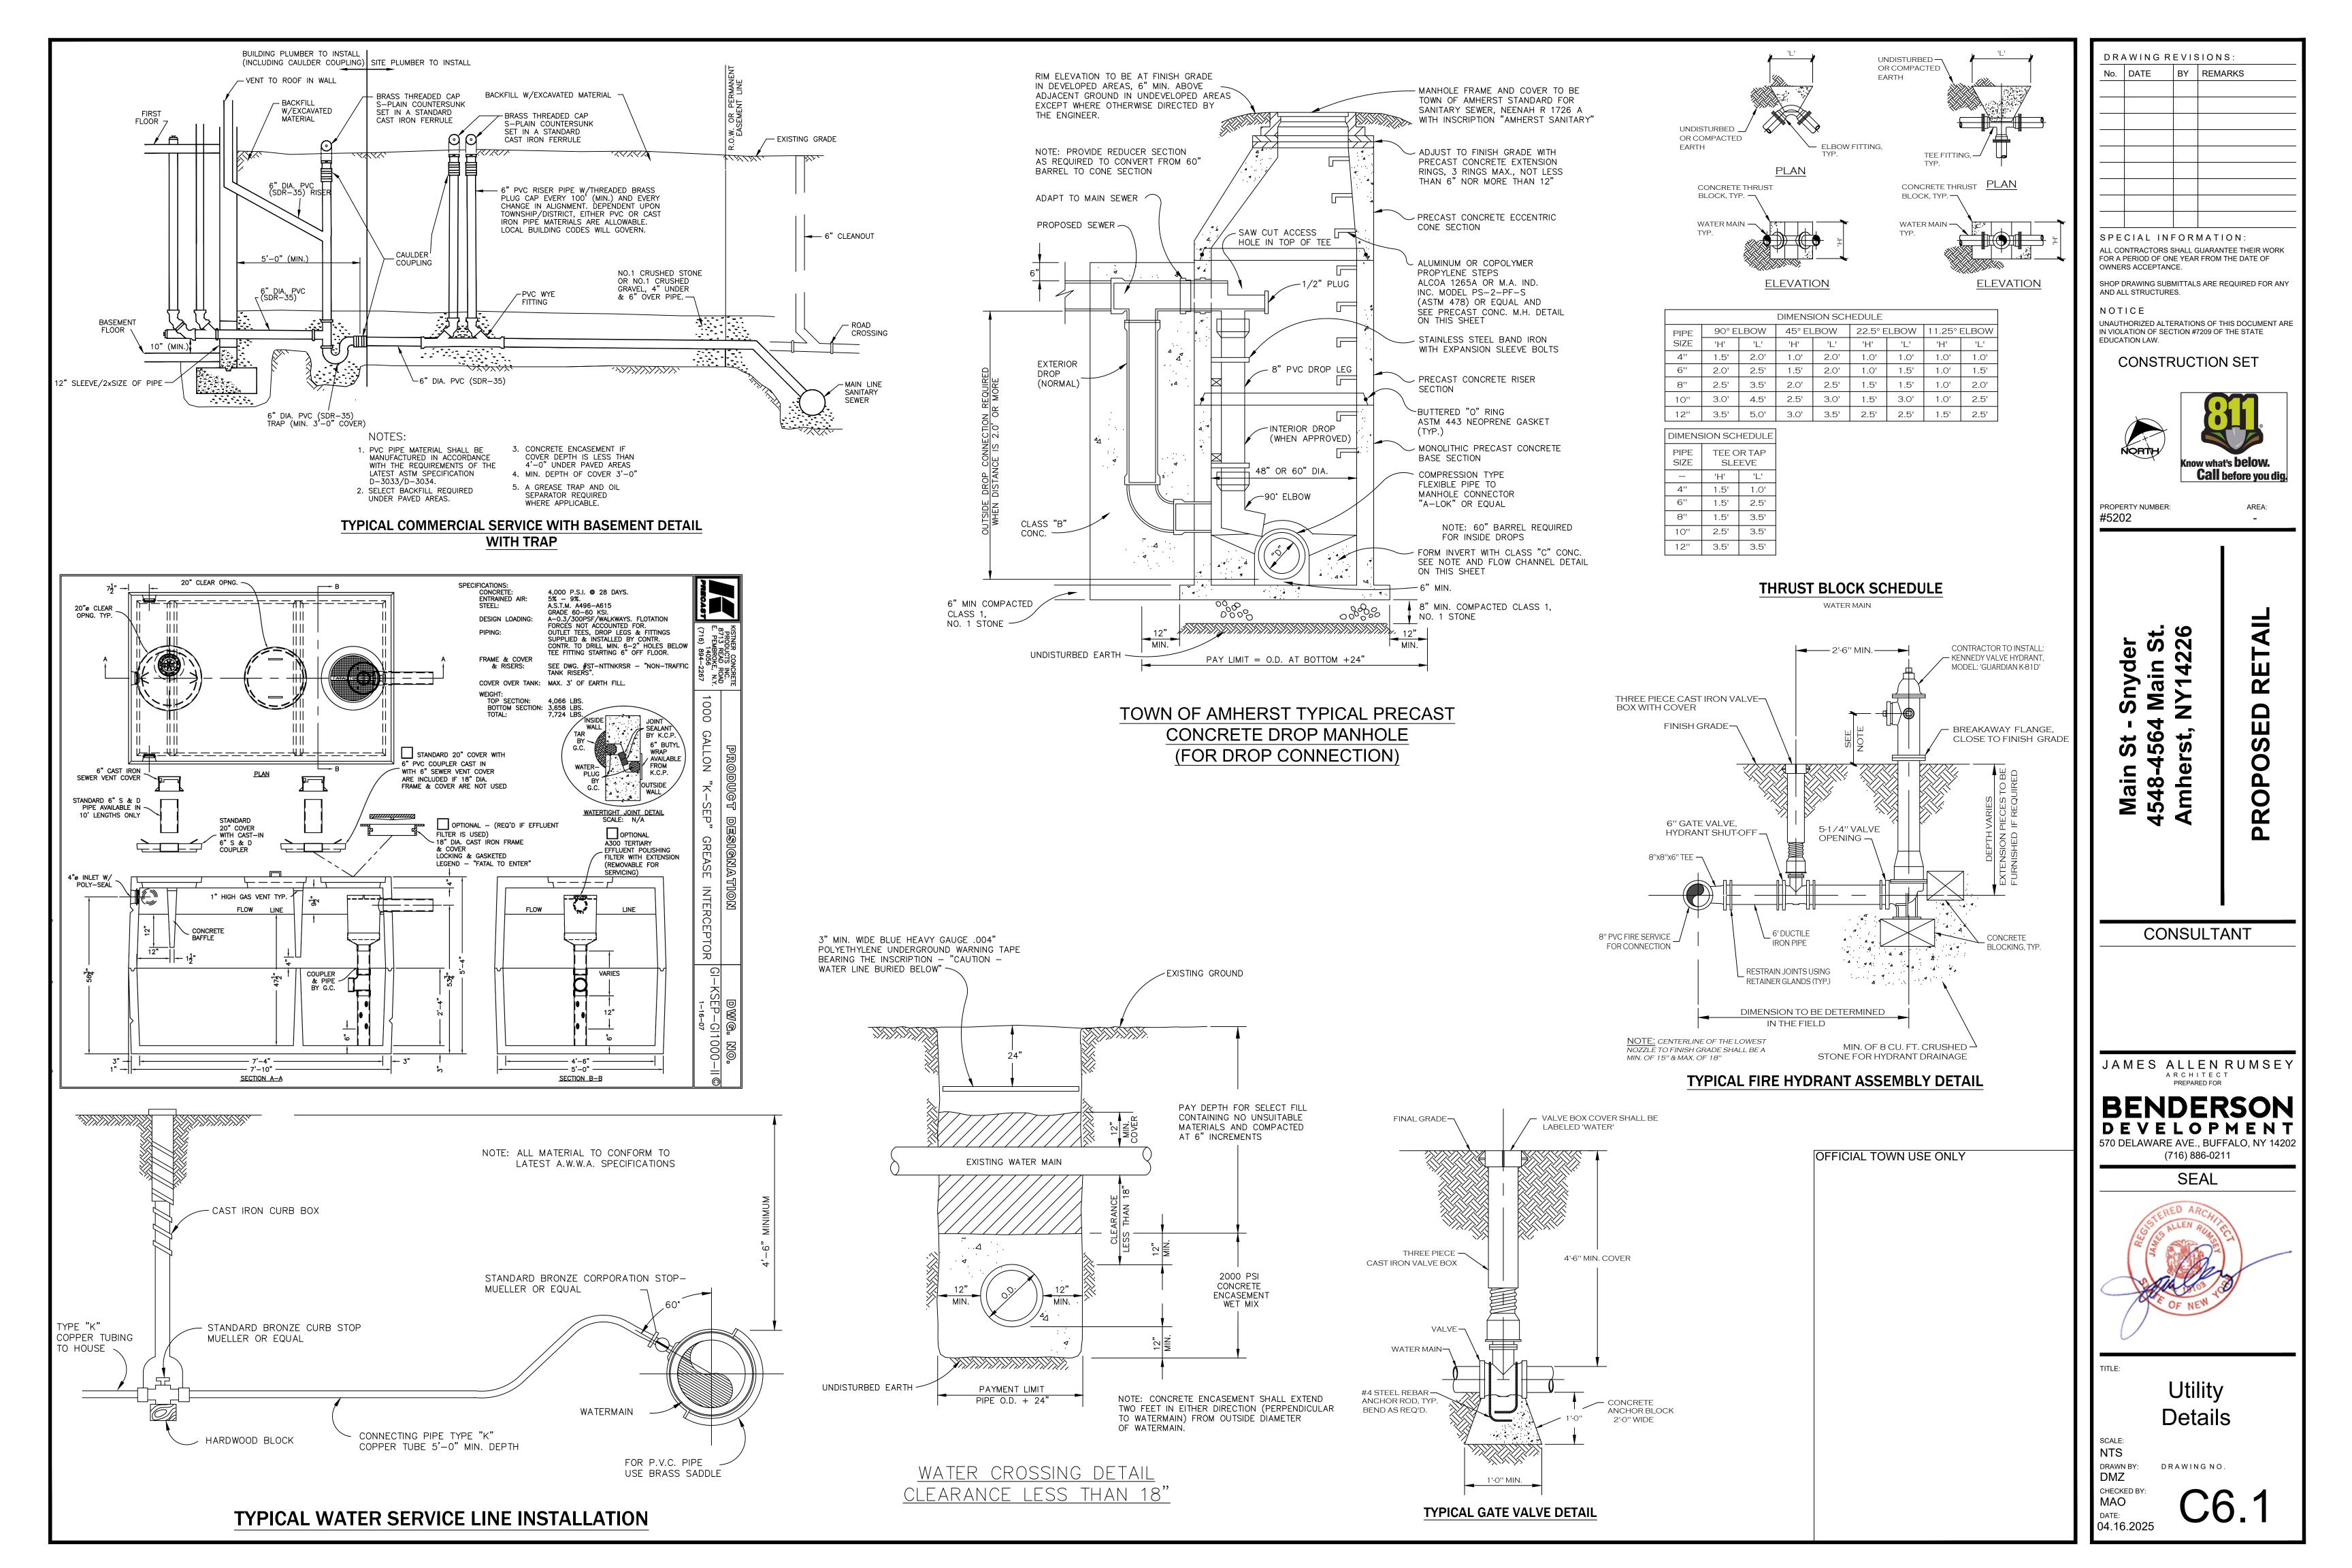

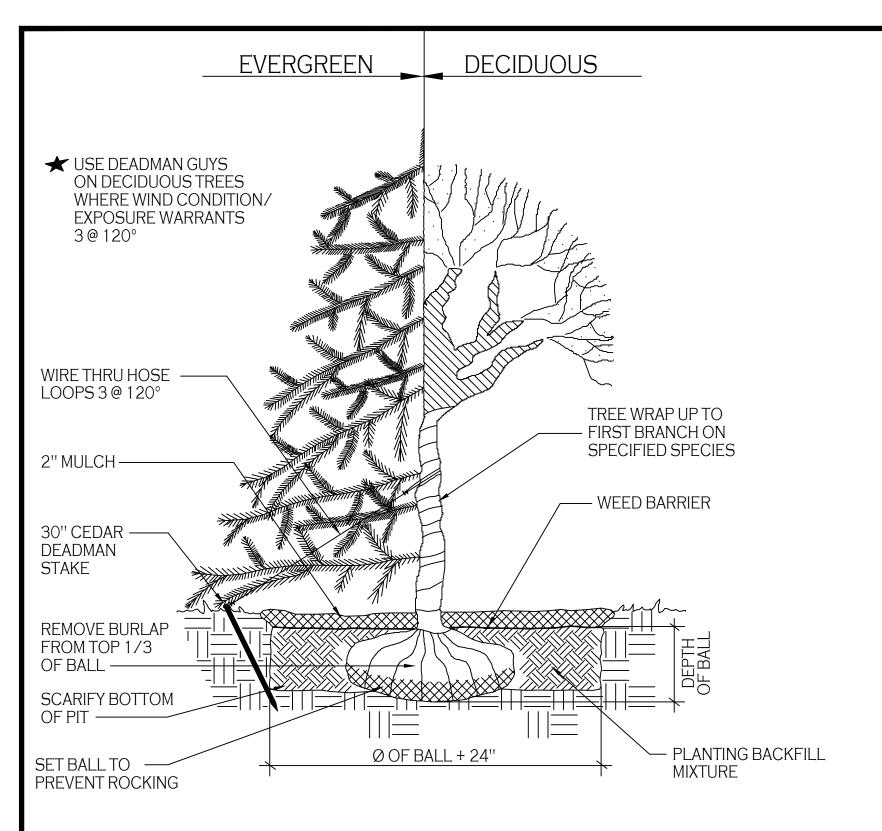

STD. TREE PLANTING

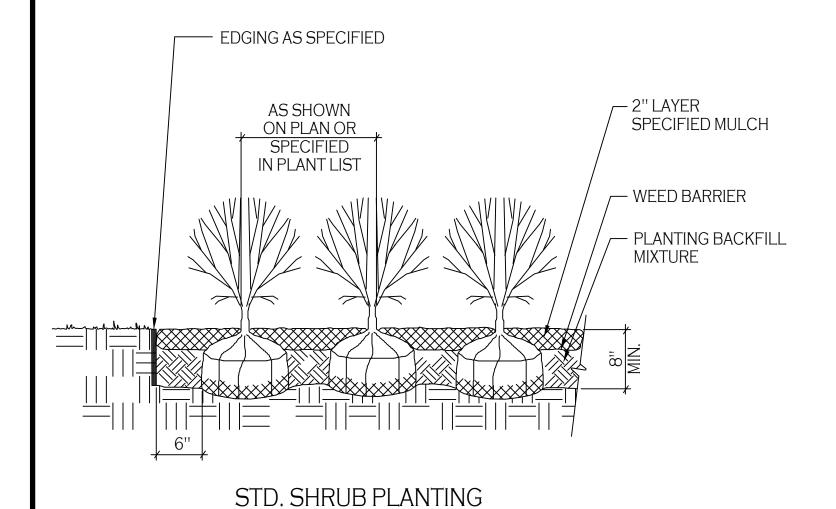




- ALL PLANTS INSTALLED SHALL MEET OR EXCEED THE MINIMUM REQUIREMENTS AS NOTED ON THE PLANS AND IN THE LATEST EDITION ON THE AMERICAN STANDARD FOR NURSERY STOCK, BY THE AMERICAN ASSOCIATION OF NURSERYMEN, ANSI 260.1
- THE CONTRACTOR SHALL BE RESPONSIBLE FOR HIS OWN QUANTITY TAKEOFF, THE QUANTITIES SHOWN ARE A MINIMUM AND ARE FOR REFERENCE PROPOSED PLANTING MATERIAL LOCATIONS IDENTIFIED ON THE PLANS CONVEY DESIGN INTENT ONLY. PRIOR TO INSTALLATION, THE CONTRACTOR SHALL COMPLETE A FIELD STAKEOUT OF ALL PROPOSED PLANTING MATERIAL LOCATIONS FOR THE OWNER'S REPRESENTATIVE'S INITIAL REVIEW. THE
- INSTALLATION. THE CONTRACTOR IS HEREBY NOTIFIED THAT IF UNDERGROUND UTILITIES EXIST IN THE VICINITY OF THE PLANTINGS, ALL PROPOSED PLANTINGS SHALL BE INSTALLED A MINIMUM OF 5' FROM ANY UNDERGROUND UTILITY, CONTACT THE OWNERS FIELD REPRESENTATIVE IF PLANTINGS SHOWN ON

FINAL LOCATION OF ALL PROPOSED PLANTING MATERIALS WILL REQUIRE THE APPROVAL OF THE OWNER'S REPRESENTATIVE AT THE TIME OF

- THE PLANS VIOLATE THIS SITUATION. ALL TREES SHALL BE INSTALLED A MINIMUM OF 20' FROM ANY OVERHEAD ELECTRIC LINES.
- PLANTING BACKFILL MIXTURE SHALL CONSIST OF 4 PARTS TOPSOIL, 1 PART PEAT MOSS, 1/3 PART WELL ROTTED MANURE, 10 LBS 5-10-5 PLANTING
- FERTILIZER THOROUGHLY MIXED PER CUBIC YARD.
- STAKE AND WRAP TREES IMMEDIATELY FOLLOWING INSTALLATION. ALL PLANTED AREAS SHALL RECEIVE A MAX. 2" LAYER OF COCOA BROWN MULCH. WEED MAT EQUAL TO "WEEDBLOCK" BY EASY GARDENER OR DEWITT WEED BARRIER.
- ALL DISTURBED AREAS NOT RECEIVING PLANTINGS (INCLUDING RIGHT-OF-WAYS) SHALL BE PROVIDED WITH SOD. SEED PERMITTED AT RETENTION POND IF PLANTED EARLY ENOUGH TO ESTABLISH.
- 0. THE AREAS ON THE PLAN TO BE SEEDED SHALL HAVE 4" MINIMUM OF TOPSOIL, DISK PLOWED, LEVELED AND HAND RAKED SMOOTH. SURFACE SHALL BE ROLLED TO REMOVE LUMPS.
- 1. ALL SEEDED AREAS SHALL BE HYDROSEEDED IN ACCORDANCE WITH THE SPECIFICATION INDICATED. WHERE REQUIRED BY CLIMATIC CONDITIONS. SLOPE OR SEASON OF PLANTING. HYDROSEED SPEC: 20% RYE, 20% BLUE GRASS, 60% TURF TYPE FESCUE.
- SOD MAY BE SUBSTITUTED FOR SEEDING IN ORDER TO ACHIEVE THE REQUIRED COVERAGE (REFER TO CONTRACTOR FOR SOD/SEED COVERAGE).
- 12. THE CONTRACTOR SHALL BE RESPONSIBLE FOR WATERING, MOWING AND OTHER MAINTENANCE TO SEEDED AREAS UNTIL THE PROJECT IS ACCEPTED BY THE OWNER, THIS SHALL INCLUDE WATERING DAILY FOR 15 DAYS OR AS REQUIRED BY WEATHER CONDITIONS AND RE-SEEDING OF THIN SPOTS FOLLOWING THE GERMINATION OF THE SEEDS.
- 13. CONTRACTOR IS RESPONSIBLE TO PROTECT ALL EXISTING TREES ONSITE AND OFFSITE, WHICH ARE TO BE PRESERVED, FROM ALL POSSIBLE TYPES OF ROOT, TRUNK, AND LIMB DAMAGE. 14. CONTRACTOR TO PROVIDE A ONE YEAR GUARANTEE ON ALL NEW PLANTING MATERIALS, INCLUDING LAWNS, STARTING AT THE DATE OF FINAL
- ACCEPTANCE.

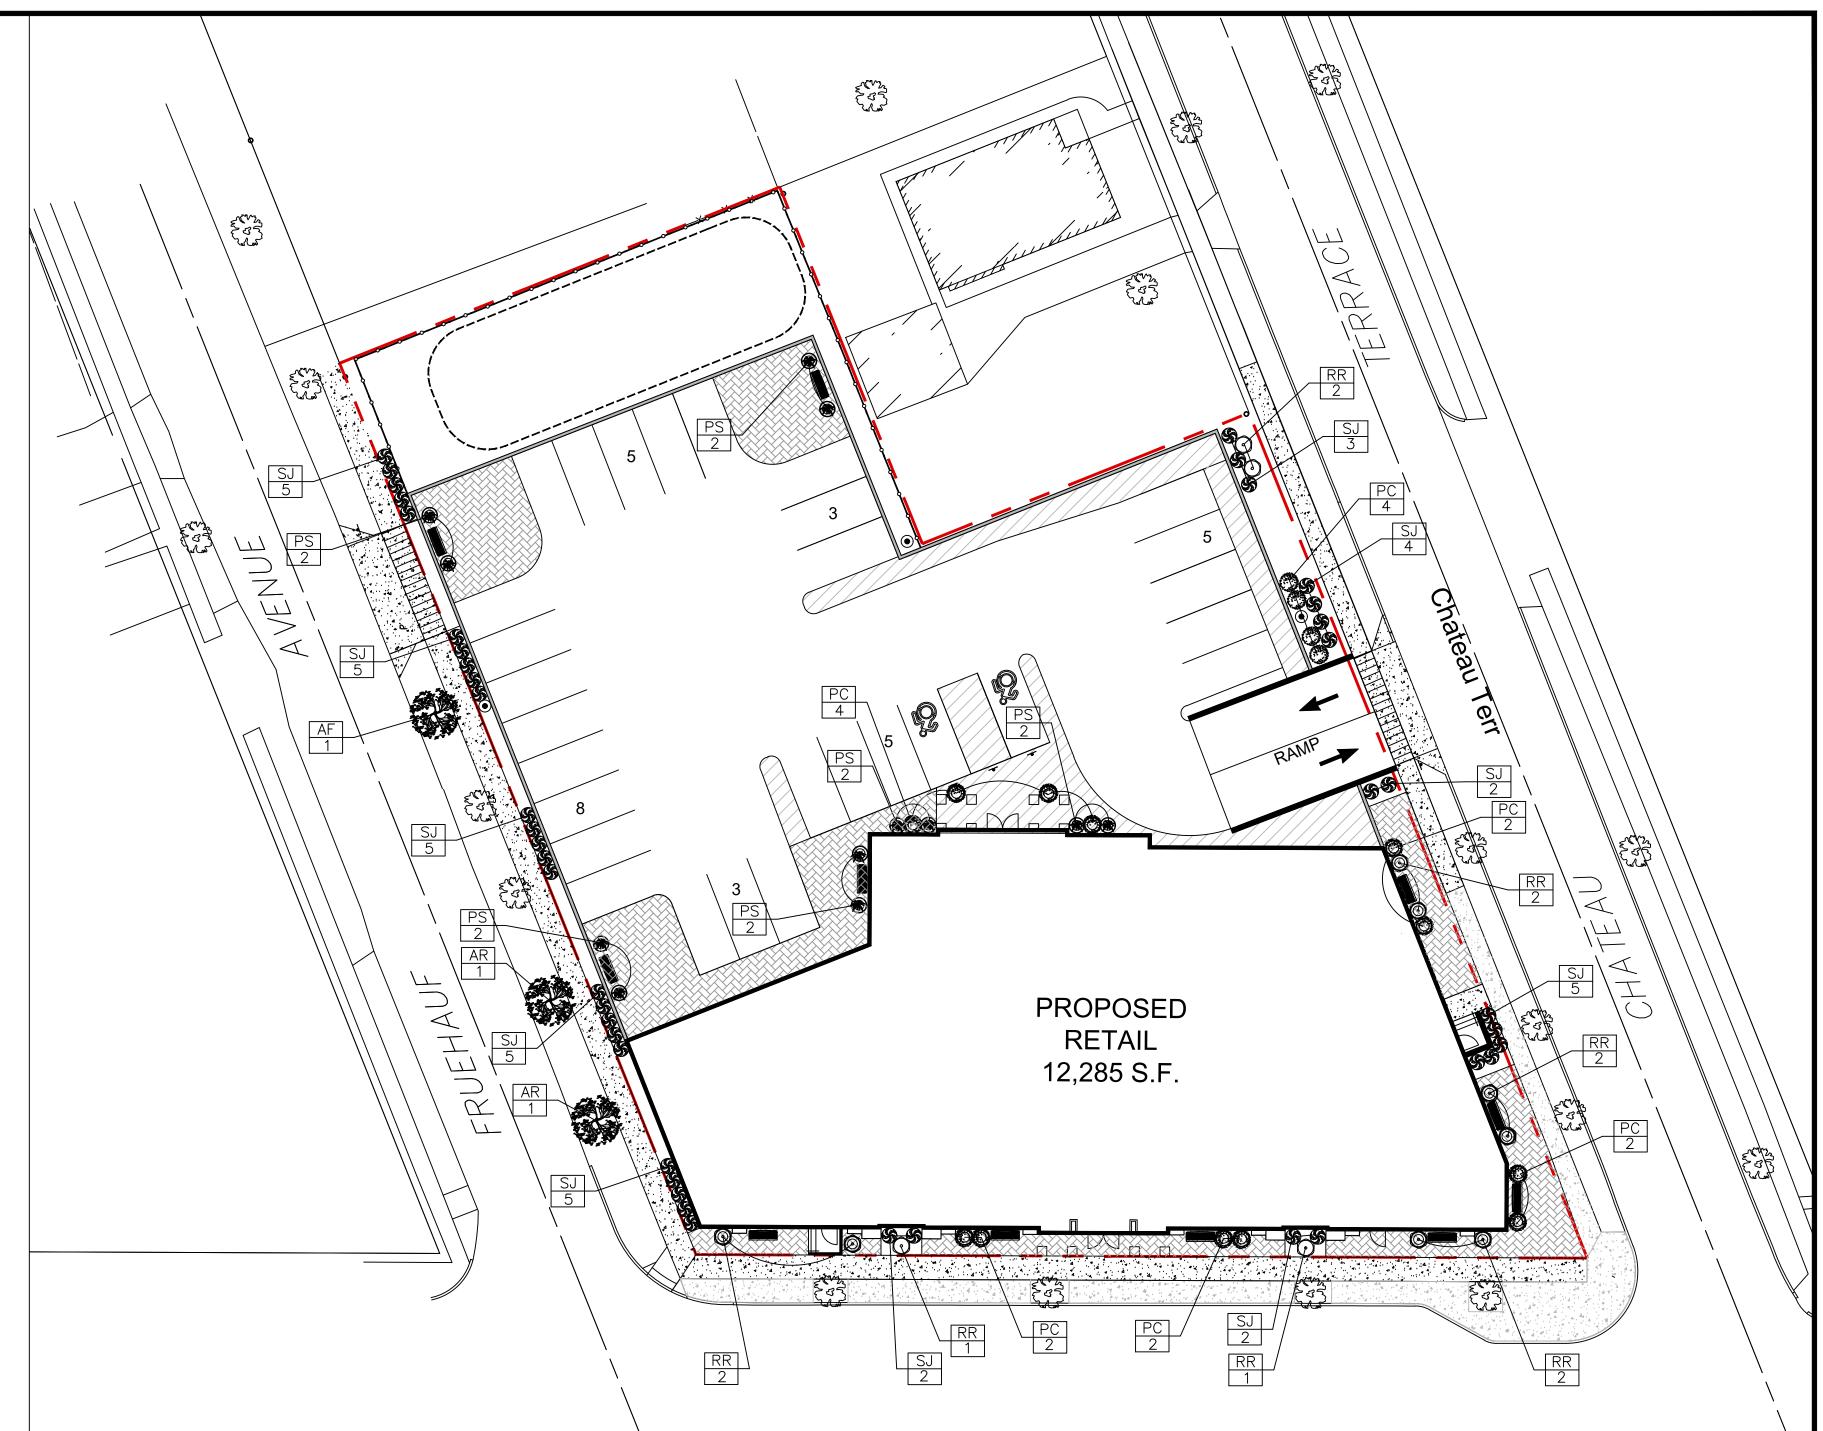

OFFICIAL TOWN USE ONLY

		I	ANDSCAPING	INDEX			
SYMBOL	KEY	BOTANICAL NAME	COMMON NAME	CAL.	SIZE	ROOT	QTY.
		I	[TREES]				
	AF	Acer x Freemanii	ARMSTRONG MAPLE	2-1/2"		B&B	3
	1		[SHRUBS & GR/	ASS]			
S	SJ	Spiraea japonica 'Gold Mound'	GOLD MOUND SPIRAEA		24"	3 GAL.	43
0	PC	Prunus x cistena	PURPLELEAF SAND CHERRY		24"	3 GAL.	16
\bigcirc	RR	Rosa 'Radrazz'	KNOCK OUT ROSES	-	24"	3 GAL.	10
	PS	Pennisetum setaceum	FOUNTAIN GRASS	-	24"	3 GAL.	12

DRAWING REVISIONS: No. DATE BY REMARKS SPECIAL INFORMATION

ALL CONTRACTORS SHALL GUARANTEE THEIR WORK FOR A PERIOD OF ONE YEAR FROM THE DATE OF OWNERS ACCEPTANCE.

SHOP DRAWING SUBMITTALS ARE REQUIRED FOR ANY AND ALL STRUCTURES.

UNAUTHORIZED ALTERATIONS OF THIS DOCUMENT ARE IN VIOLATION OF SECTION #7209 OF THE STATE

CONSTRUCTION SET



PROPERTY NUMBER: #5202

AREA:

S

0

CONSULTANT

JAMES ALLEN RUMSEY ARCHITECT

570 DELAWARE AVE., BUFFALO, NY 14202

(716) 886-0211




Overall Landscaping Plan

1" = 20' DRAWN BY:


DRAWING NO. DMZ CHECKED BY:

MAO DATE: 04.16.2025

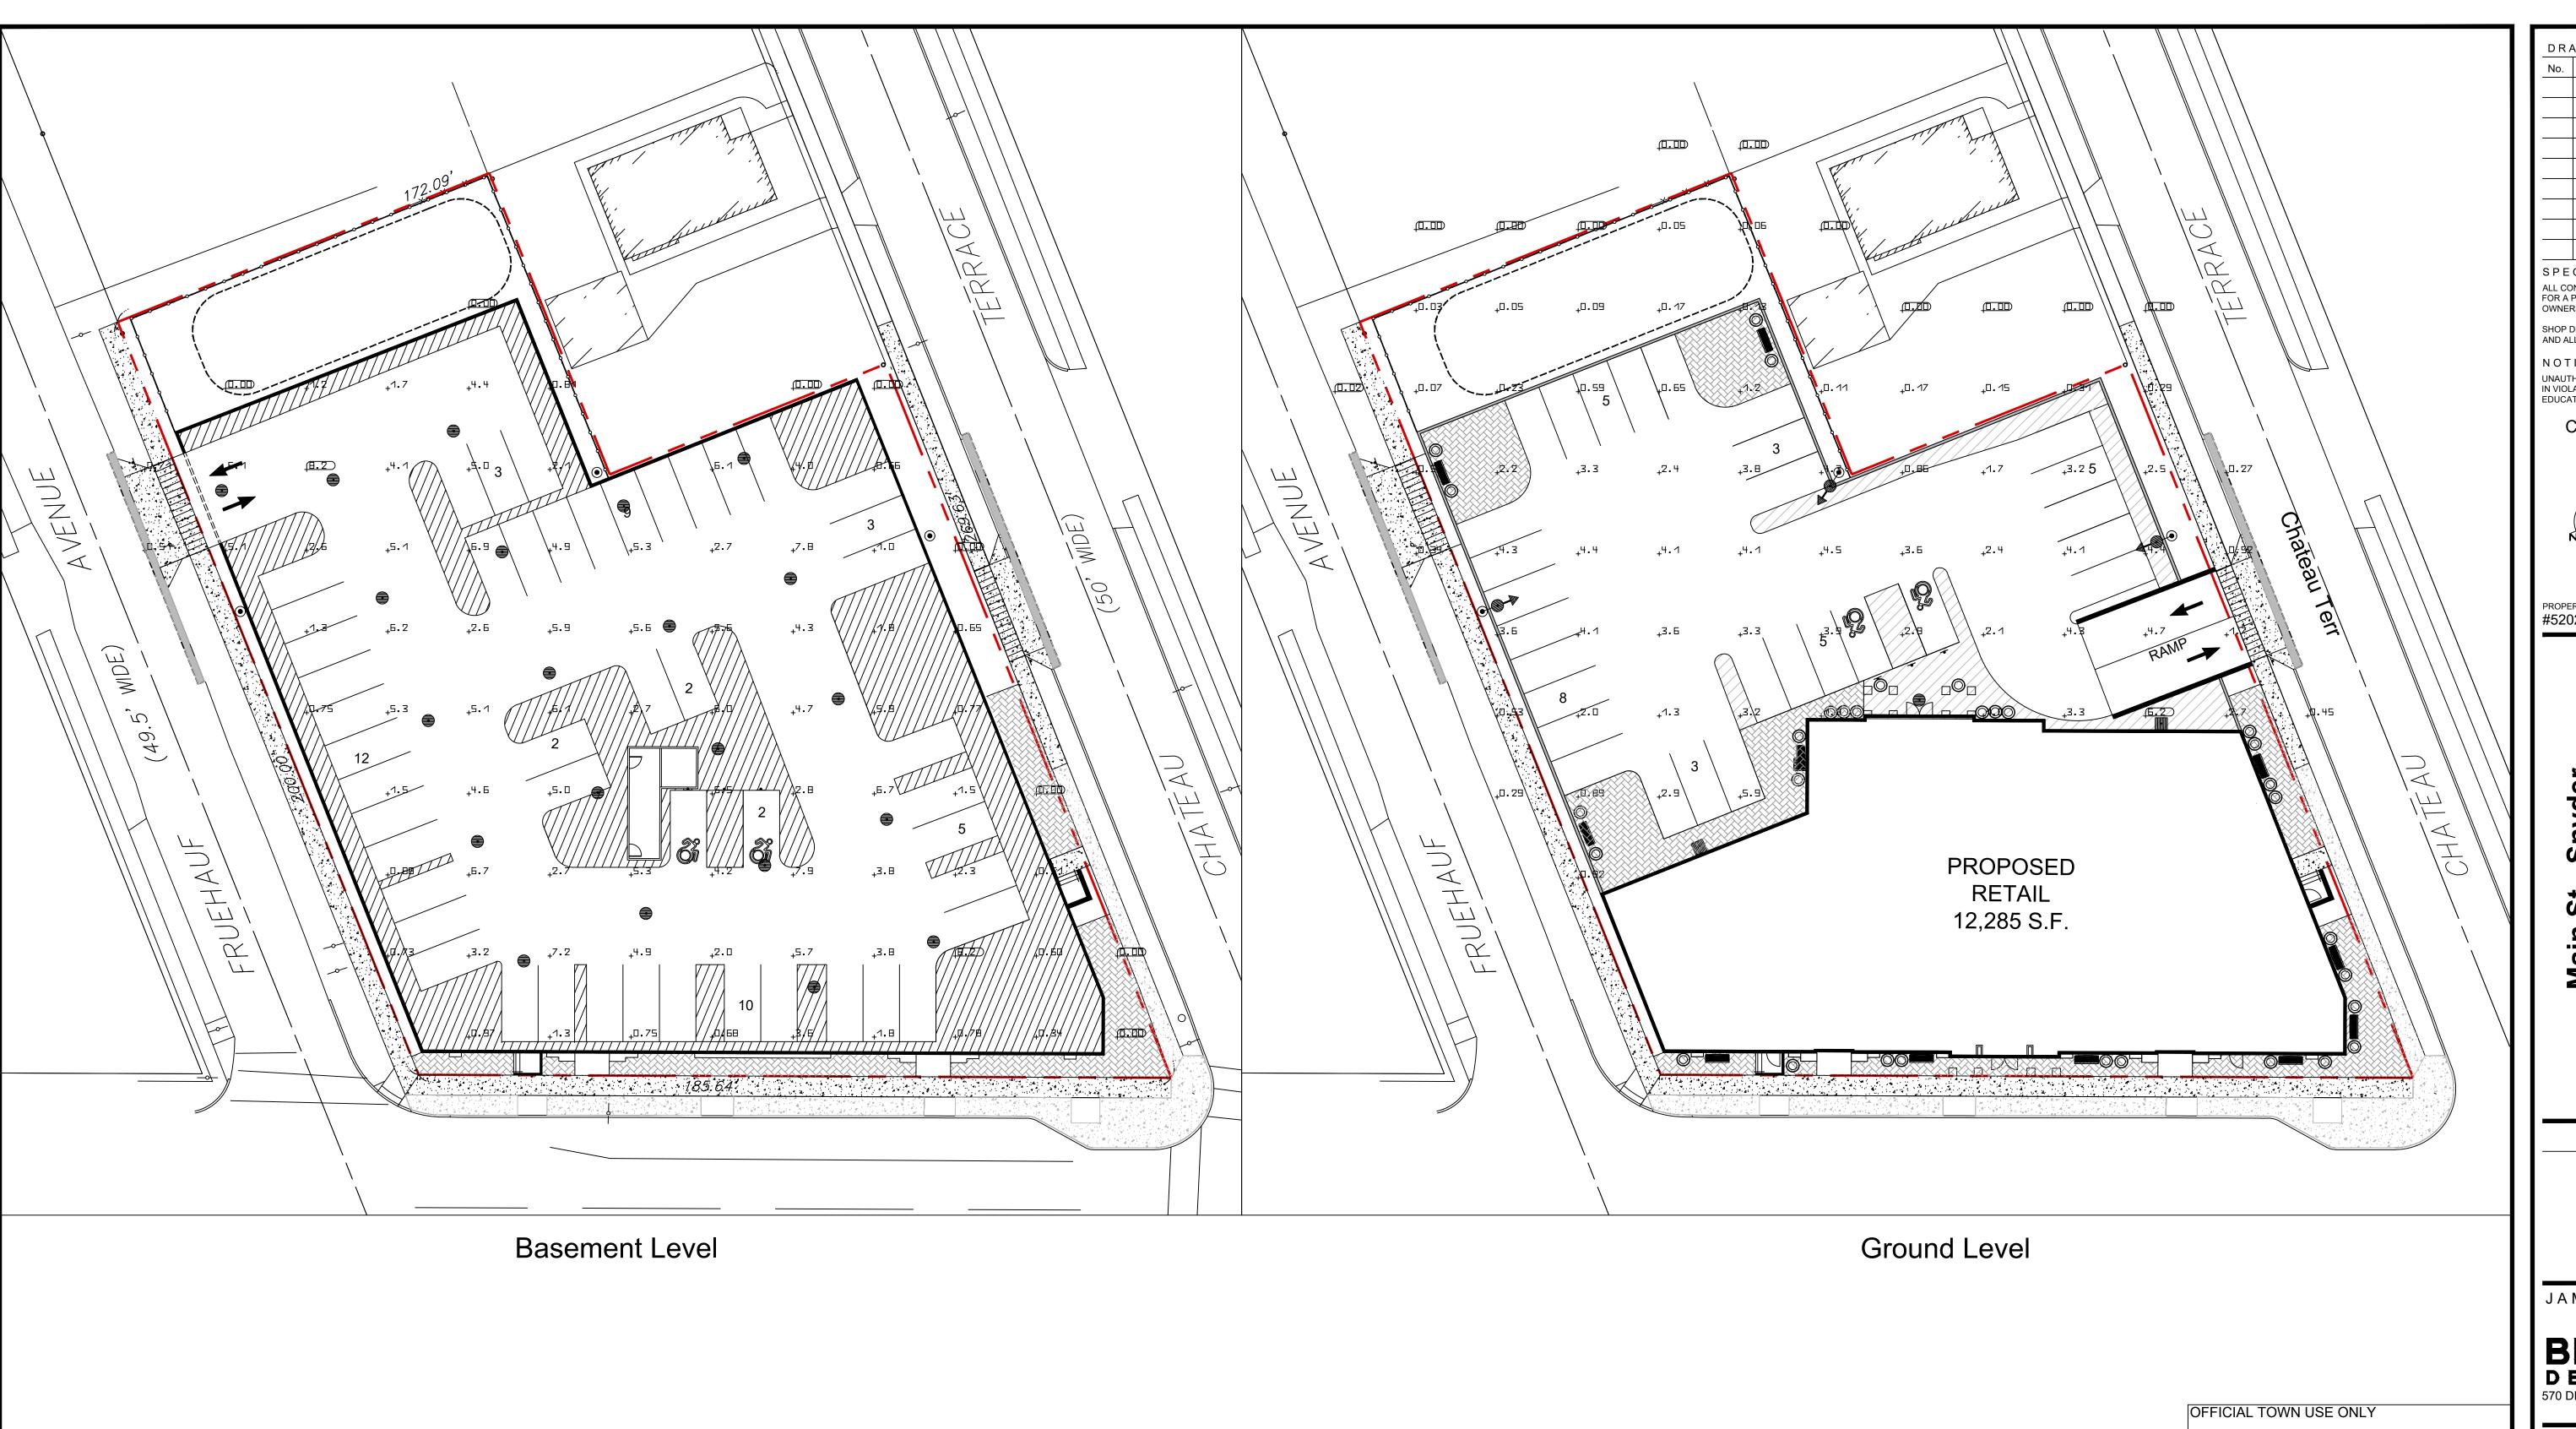

Luminaire Schedule							
Index	Manufacturer	Luminaire type	Item number	Luminous flux	Mounting Height	Connected load	Quantity
	C-Lite	C-Lite Full Cutoff Wall Pack, A Series, 09 Lumen, 40K CCT	C-WP-A-FCA-09-4 0K-DB	9000 Lm	15 Ft	62 W	3
	Cree Inc.	Cree IG Series Parking Garage Luminaire, Type V , 7L Input Power Designator, 4000K	IG-B-NM-5S-7L- 40K8-UL	7550 Lm	10 Ft	60 W	22
	Cree Inc	Cree OSQ Series Luminaire, 22L Power, 4000K, Type 4M distribution with backlight shield	OSQL-C-22L-40K7 -4M-NM-w/ BLSF	12000 Lm	25 Ft	130 W	3


			LE LEVELS AT GRAI	1	
#	Name	Parameter	Min	Max	Average
1	Non-Residential Parking Area	Ground Level Parking and Site	0.51 fc Code: 0.2 fc	6.23 fc Code: 10.0 fc	1.47 fc Code: 1.5 fc
2	Canopy Area	Basement Parking Area	2.10 fc Code: 2.0 fc	8.21 fc Code: 15.0 fc	3.67 fc Code: 10.0 fc

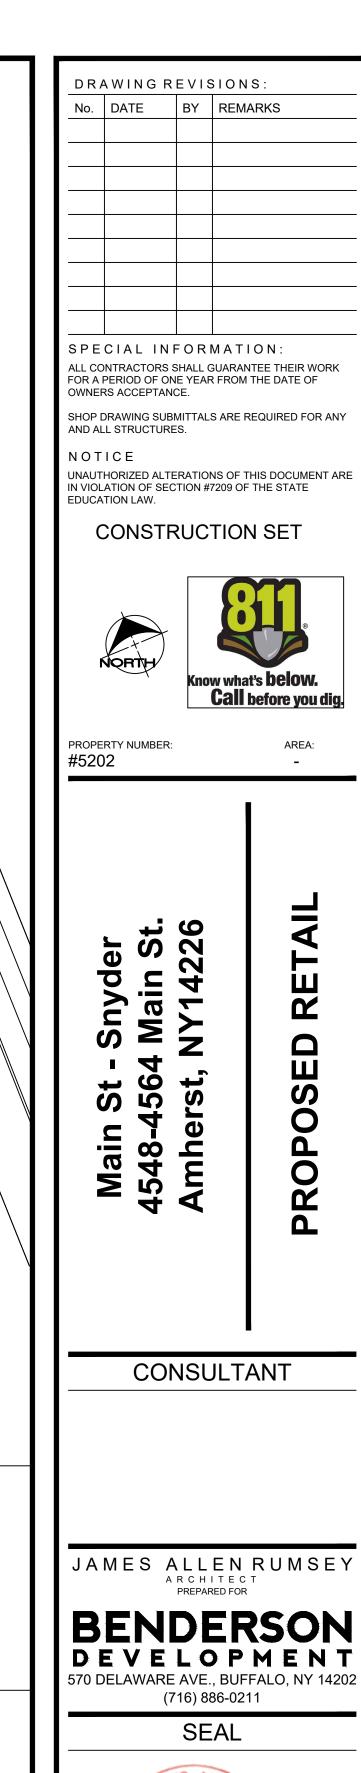



Lighting Plan


SCALE: 1" = 20' DRAWN BY: DRAWING NO. DMZ

CHECKED BY:
MAO
DATE:
04.16.2025

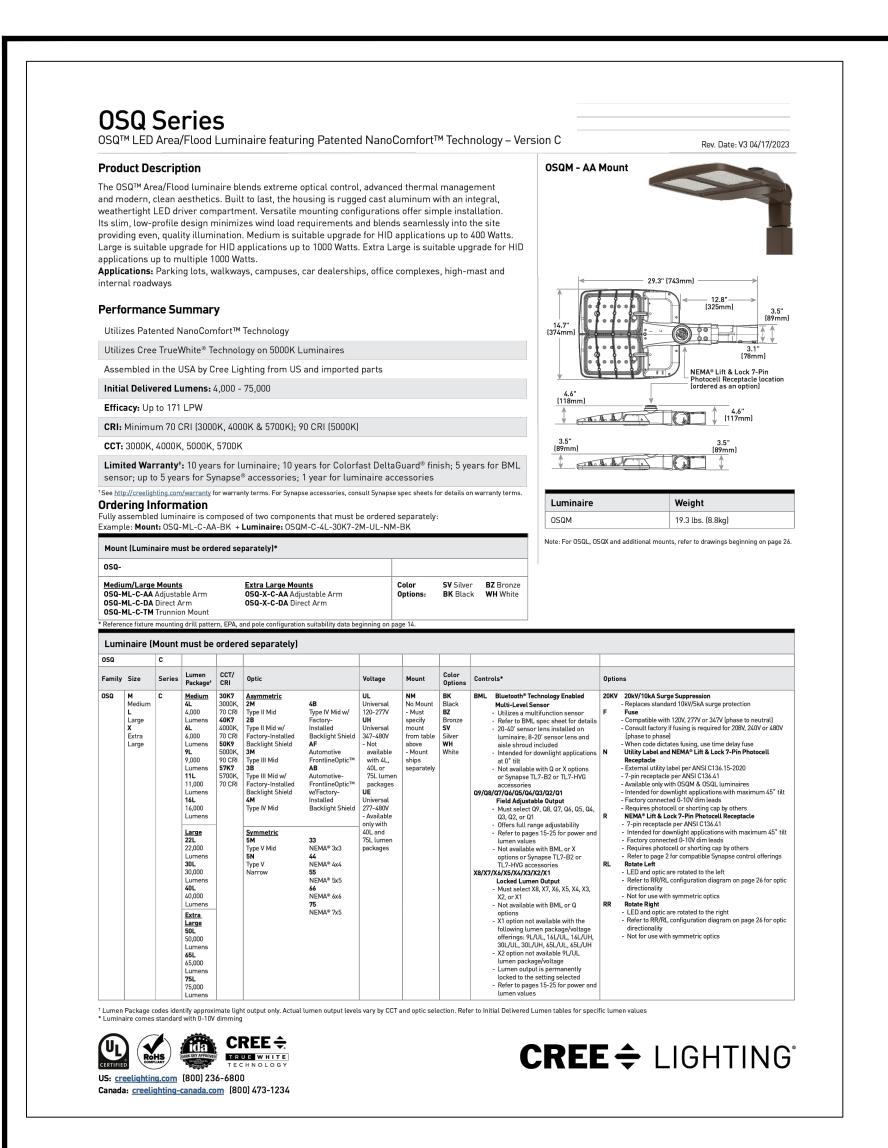

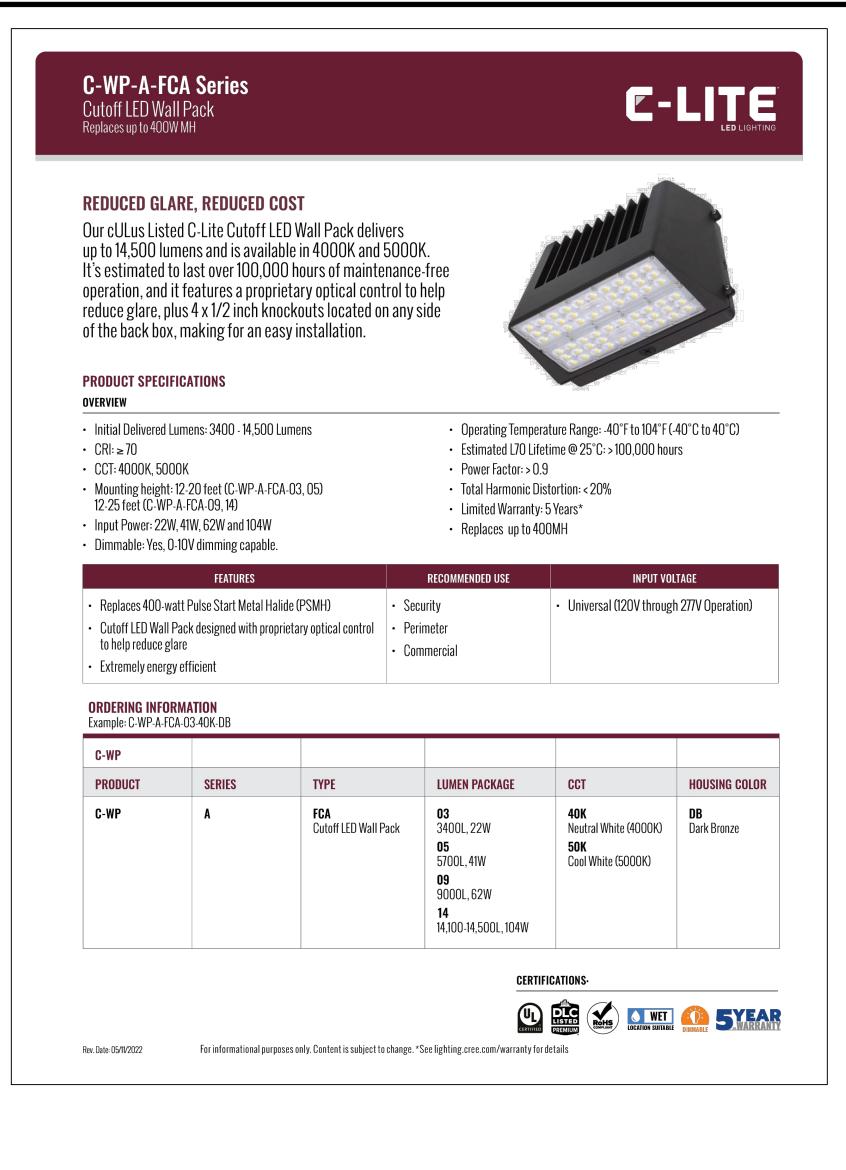

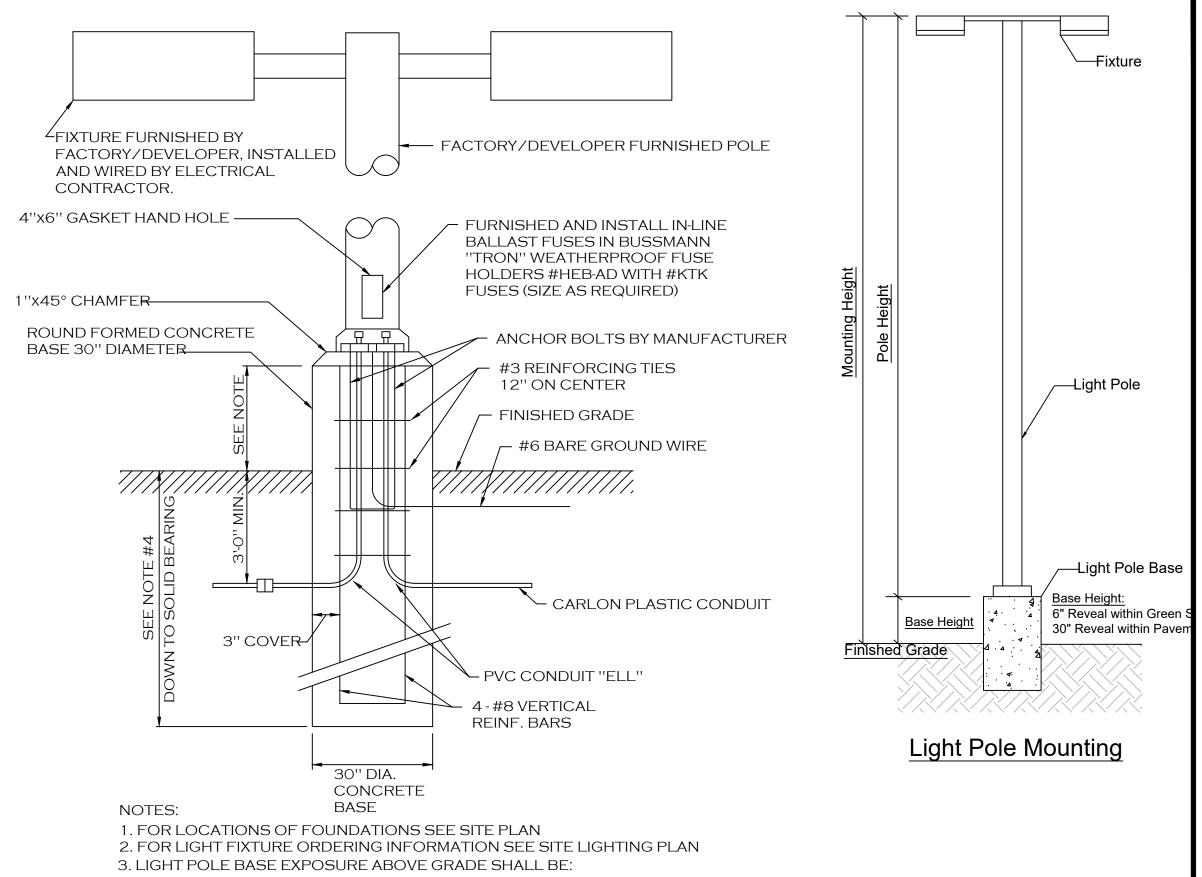

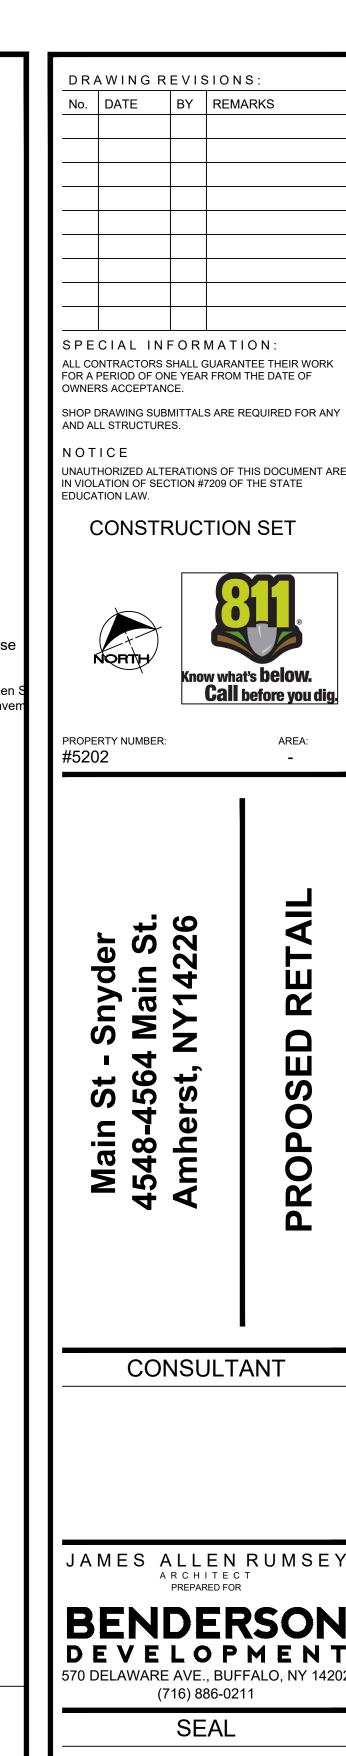

0 Ω

AREA:

S


0

JAMES ALLEN RUMSEY ARCHITECT

570 DELAWARE AVE., BUFFALO, NY 14202 (716) 886-0211

SEAL

OFFICIAL TOWN USE ONLY

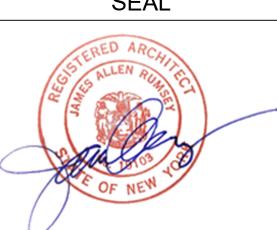

Lighting **Details**

NTS DRAWING NO. DRAWN BY: DMZ CHECKED BY

MAO

DATE: 04.16.2025

