PROPOSED RETAIL

Main St. - Snyder 4548-4564 Main Street Town of Amherst, NY 14226 BDC Property # 5202


INDEX OF DRAWINGS

<u>DWG.#</u>	DRAWING NAME	REVISION	DATE
C1.0	COVER SHEET	4	07.14.2025
C2.0	EXISTING SURVEY		
C3.0	DEMOLITION AND EROSION CONTROL PLAN	2	05.27.2025
C3.1	DEMOLITION AND EROSION CONTROL DETAILS		
C4.0	OVERALL SITE PLAN	4	07.14.2025
C4.1	DETAILED SITE PLAN	4	07.14.2025
C4.2	CONSTRUCTION DETAILS	3	06.04.2025
C5.0	GRADING PLAN	4	07.14.2025
C5.1	DRAINAGE PLAN	4	07.14.2025
C5.2	DRAINAGE DETAILS		
C6.0	UTILITY PLAN	4	07.14.2025
C6.1	UTILITY DETAILS		
C7.0	LANDSCAPING PLAN	4	07.14.2025
C8.0	LIGHTING PLAN	4	07.14.2025
C8.1	LIGHTING DETAILS	3	06.04.2025

OWNER/DEVELOPER:

NAME: BENDERSON DEVELOPMENT COMPANY, LLC ADDRESS: 570 DELAWARE AVENUE, BUFFALO, NY 14202

CONTACT: DAVID ZUPPELLI PHONE: 716 - 878 - 9683

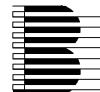

BENDERSON DEVELOPMENT COMPANY, LLC

570 Delaware Ave. Buffalo, New York 14202

SURVEYOR

PHONE:

NAME: TRUE NORTH SURVEYING ADDRESS: 150 AERO DRIVE, BUFFALO NY 14225

716-631-5140

CONTACT: CHRISTOPHER BARR

UTILITIES:

WATER DEPARTMENT

NAME/TITLE: ADAM MASSARO

COMPANY/DEPT: ERIE COUNTY WATER AUTHORITY ADDRESS: 3030 UNION RD, CHEEKTOWAGA, NY

PHONE: 716 - 685-8207

BUILDING & PLUMBING DEPARTMENT

NAME/TITLE:

TOWN OF AMHERST, NY - BUILDING DPT COMPANY/DEPT: ADDRESS: 5583 MAIN STREET, WILLIAMSVILLE, NY 14221

716 - 631 - 7080

NATURAL GAS

NAME/TITLE: WILLIAM SCHNEIDER COMPANY/DEPT: NATURAL FUEL GAS **ADDRESS**

PHONE: 716 - 696 - 6460

TELEPHONE COMPANY

JOHN HECKMAN COMPANY/DEPT:

ADDRESS: PHONE: 716 - 840 - 8603

ELECTRIC

NAME/TITLE:

COMPANY/DEPT: NATIONAL GRID

ADDRESS:

PHONE:

DIG SAFELY NEW YORK

PHONE: 1 - 800 - 962 - 7962 OR (811)

AGENCIES:

ENGINEERING DEPARTMENT

NAME/TITLE: JEFF BURROUGHS

COMPANY/DEPT: TOWN OF AMHERST, NY - ENGINEERING DPT ADDRESS: 1100 NORTH FOREST RD, WILLIAMSVILLE, NY

PHONE: 716 - 631 - 7154 EX 7418

PLANNING DEPARTMENT

NAME/TITLE: DAN HOWARD

COMPANY/DEPT: TOWN OF AMHERST, NY - PLANNING DPT

5583 MAIN STREET, WILLIAMSVILLE, NY 14221 ADDRESS:

PHONE: 716 - 631 - 7051


NYSDOT - HIGHWAY & UTILITY PERMITS

NAME/TITLE: ALFRED I. OYOYO, ASSISTANT RESIDENT ENGINEER COMPANY/DEPT: NEW YORK STATE DEPARTMENT OF TRANSPORTATION

(NORTH ERIE RESIDENCY)

ADDRESS: 111 INDIAN ROAD. DEPEW, NEW YORK 14043

PHONE: 716 - 683 - 3476 (EXT - 27)

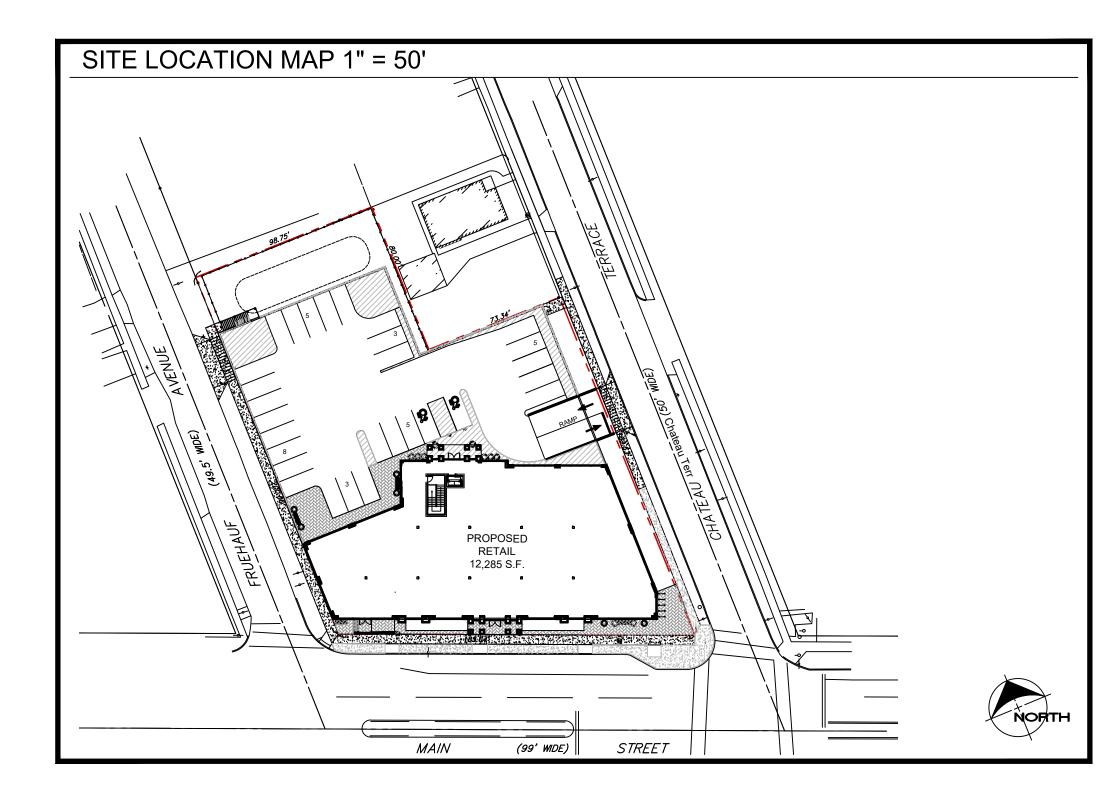



OFFICIAL TOWN USE ONLY

DRAWING REVISIONS: No. DATE BY REMARKS 04.29.2025 DZ Arch Updates 05.27.2025 DZ Coordination Notes 06.04.2025 DZ Town Meeting Update 07.14.2025 DZ Site Updates

> ALL CONTRACTORS SHALL GUARANTEE THEIR WORK FOR A PERIOD OF ONE YEAR FROM THE DATE OF

UNAUTHORIZED ALTERATIONS OF THIS DOCUMENT AR IN VIOLATION OF SECTION #7209 OF THE STATE

CONSTRUCTION SET



PROPERTY NUMBER:

CONSULTANT

JAMES ALLEN RUMSEY

570 DELAWARE AVE., BUFFALO, NY 14202


SEAL



COVER **SHEET**

DRAWN BY:

DRAWING NO. DATE: 04.16.2025

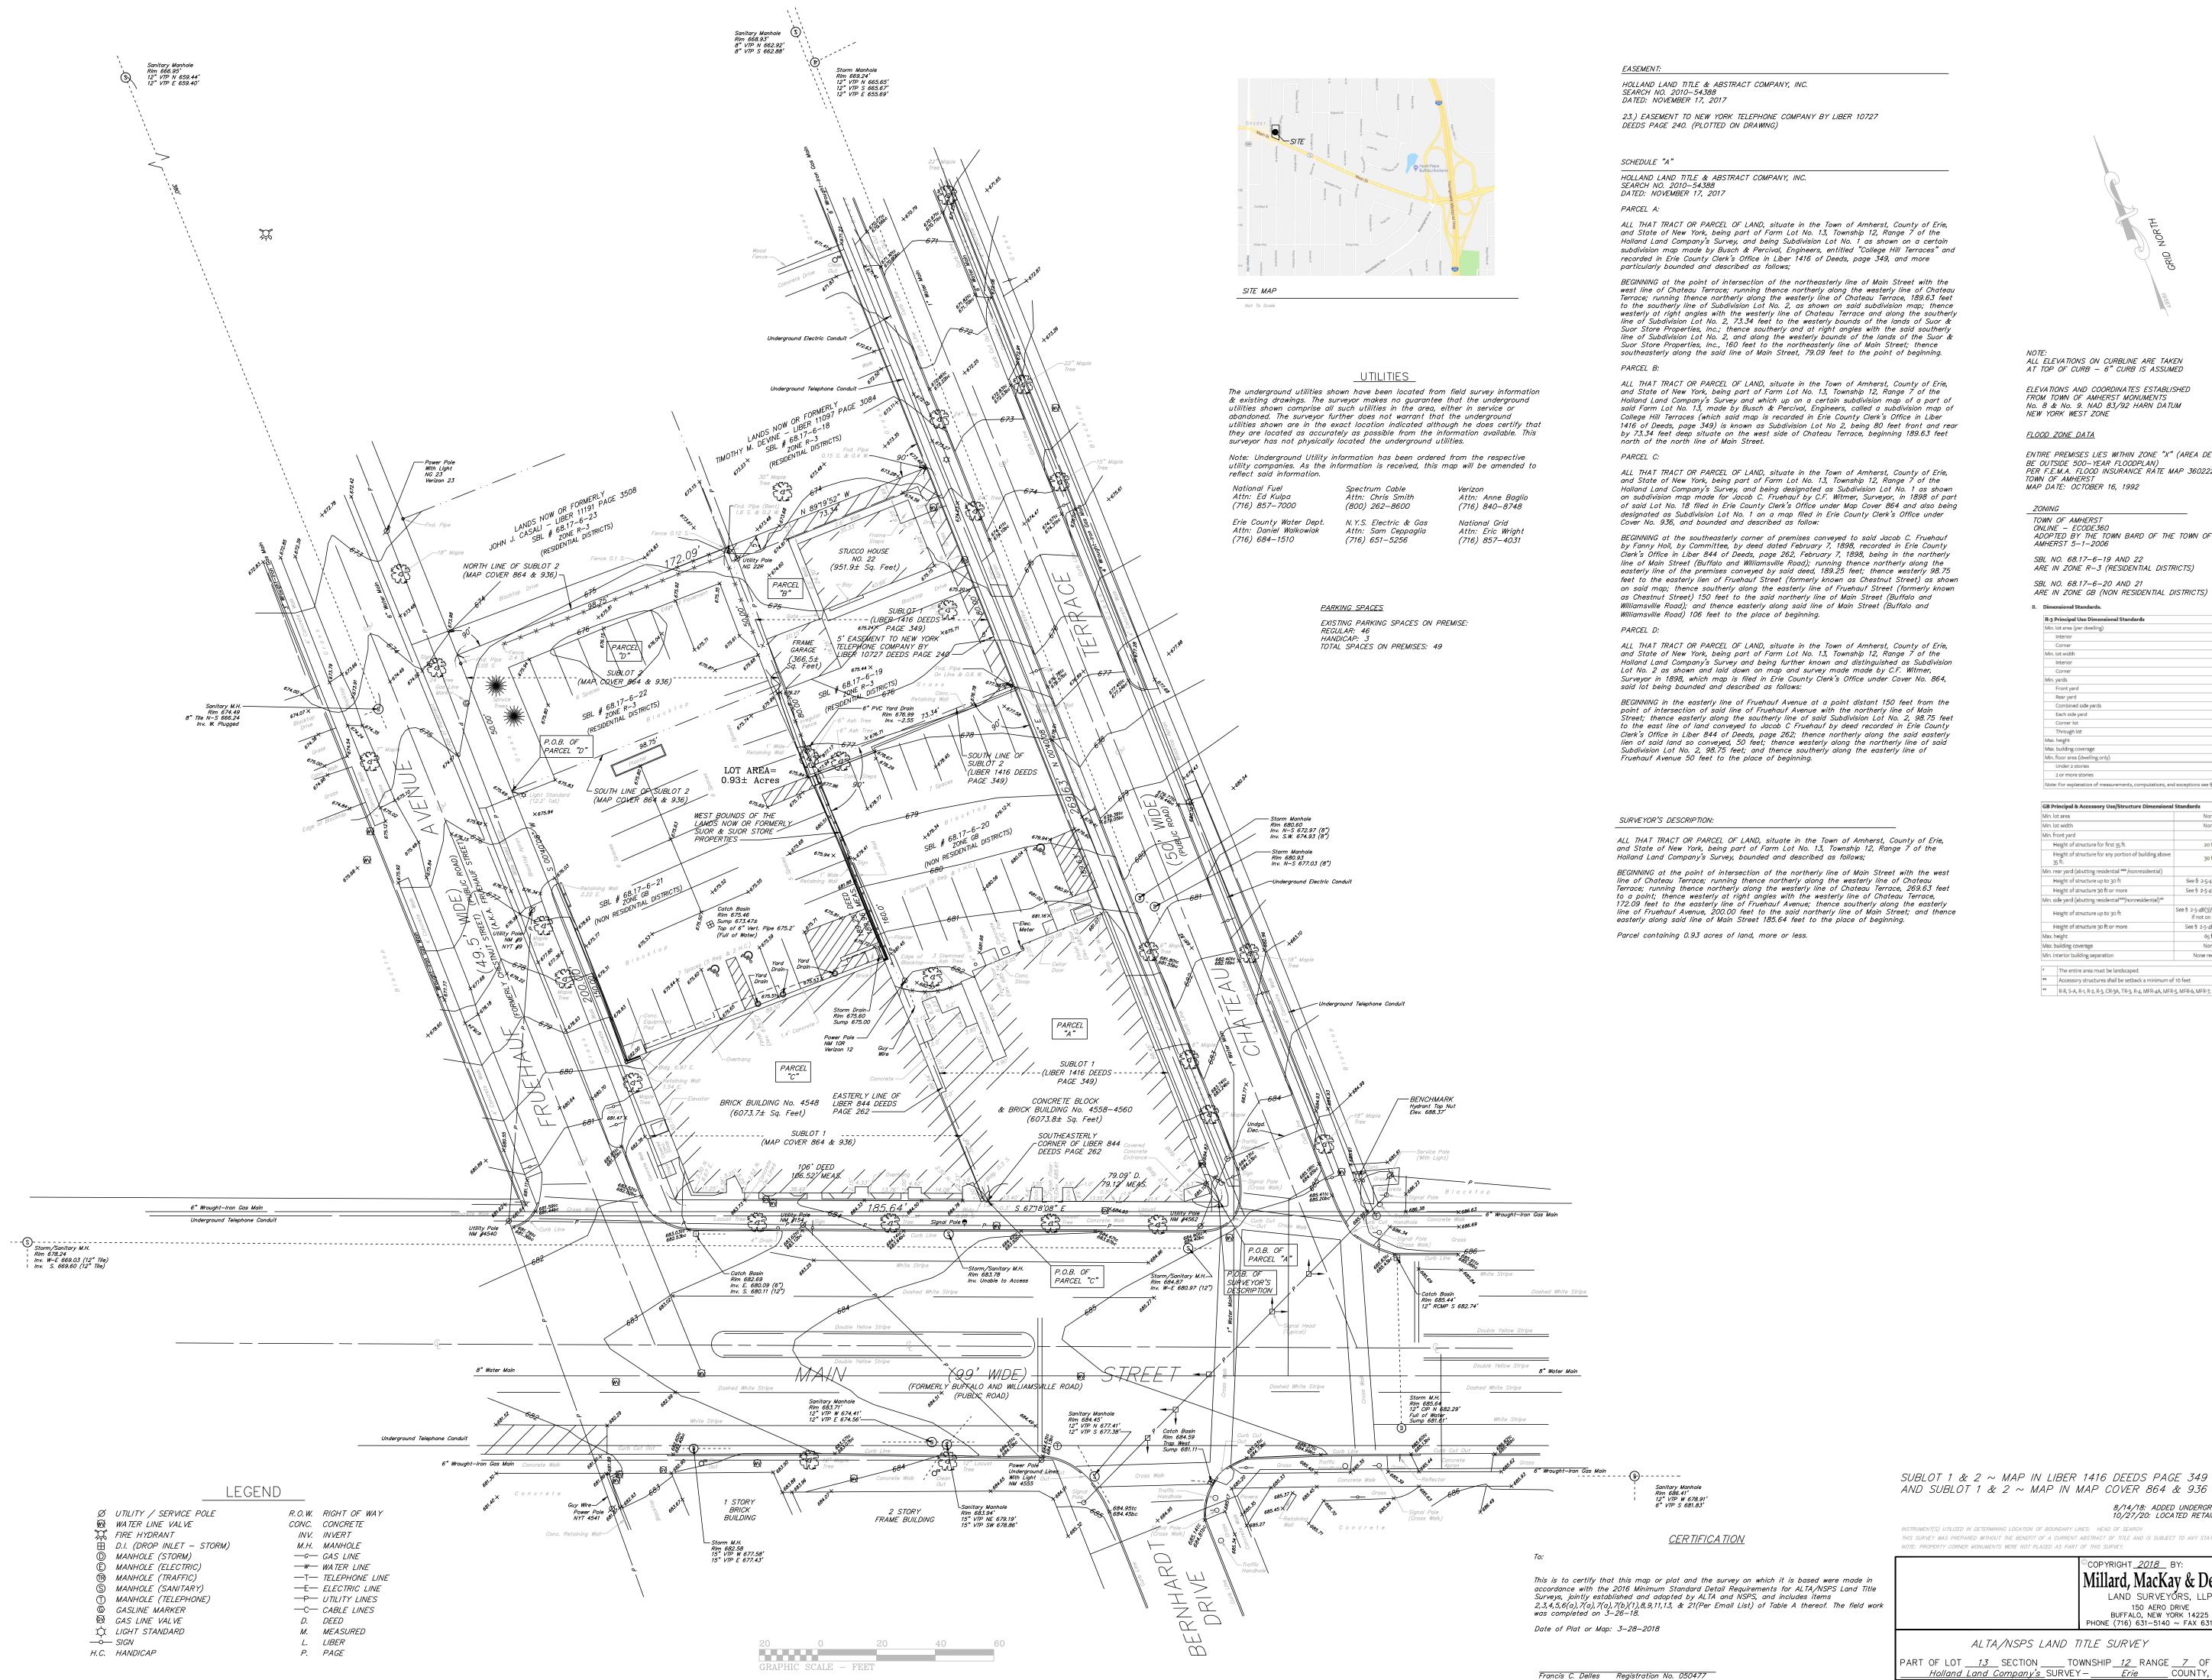



ALL ELEVATIONS ON CURBLINE ARE TAKEN AT TOP OF CURB — 6" CURB IS ASSUMED

ELEVATIONS AND COORDINATES ESTABLISHED FROM TOWN OF AMHERST MONUMENTS No. 8 & No. 9. NAD 83/92 HARN DATUM NEW YORK WEST ZONE

FLOOD ZONE DATA

ENTIRE PREMISES LIES WITHIN ZONE "X" (AREA DETERMINED TO BE OUTSIDE 500-YEAR FLOODPLAN) PER F.E.M.A. FLOOD INSURANCE RATE MAP 3602226 0012 E, MAP DATE: OCTOBER 16, 1992

TOWN OF AMHERST ONLINE — ECODE360

ADOPTED BY THE TOWN BARD OF THE TOWN OF AMHERST 5-1-2006

SBL NO. 68.17-6-19 AND 22 ARE IN ZONE R-3 (RESIDENTIAL DISTRICTS)

SBL NO. 68.17-6-20 AND 21 ARE IN ZONE GB (NON RESIDENTIAL DISTRICTS)

P. 2 Principal Use Dimensional Standards

Min. lot area (per dwelling)	
Interior	8,450 sf
Corner	9,750 sf
Min. lot width	
Interior	65 ft
Corner	75 ft
Min. yards	
Front yard	30 ft
Rear yard	30 ft
Combined side yards	10 ft
Each side yard	5 ft
Corner lot	See § 2-5-2A(5)
Through lot	See § 2-5-2A(2)
Max. height	2 stories (up to 35 ft)
Max. building coverage	35%
Min. floor area (dwelling only)	
Under 2 stories	1,000 sf
2 or more stories	1,200 sf
Note: For explanation of measurements, computations, and excep	otions see § 2-5. ^[1]

Vehicle Use Area 15 ft*/5 ft* See § 2-5-4B(3)/ None or 10 ft 15 ft*/5 ft* Height of structure up to 30 ft

See § 2-5-4B(3) / 25 ft

15 ft*/5 ft*

Max. building coverage Min. interior building separation The entire area must be landscaped.

R-R, S-A, R-1, R-2, R-3, CR-3A, TR-3, R-4, MFR-4A, MFR-5, MFR-6, MFR-7, PRD, PDD, PRD, NCD^[1]

SUBLOT 1 & 2 ~ MAP IN LIBER 1416 DEEDS PAGE 349

8/14/18: ADDED UNDERGROUND UTILITIES 10/27/20: LOCATED RETAINING WALL & GASLINE MARKER

INSTRUMENT(S) UTILIZED IN DETERMINING LOCATION OF BOUNDARY LINES: HEAD OF SEARCH THIS SURVEY WAS PREPARED WITHOUT THE BENEFIT OF A CURRENT ABSTRACT OF TITLE AND IS SUBJECT TO ANY STATE OF FACTS THAT MAY BE REVEALED IN SAI

> COPYRIGHT <u>2018</u> BY: AMEND: Millard, MacKay & Delles SURVEY DATE: 3-26-18 DRAWING DATE: 3-28-18 LAND SURVEYÕRS, LLP 150 AERO DRIVE SCALE: 1" = 20'BUFFALO, NEW YORK 14225 PHONE (716) 631–5140 ~ FAX 631–3811 "ALL RIGHTS RESERVED


ALTA/NSPS LAND TITLE SURVEY

PART OF LOT 13 SECTION TOWNSHIP 12 RANGE 7 OF THE:

Holland Land Company's SURVEY Erie COUNTY, N.Y.

ENDOSED WITH NEW YORK STATE LICENSED LAND SURVEYOR'S SEAL ALTERING ANY ITEM ON THIS MAP IS A VIOLATION OF THE LAW EXCEPT AS PROVIDED IN SECTION 7209, PART 2, OF THE NEW YORK STATE EDUCATION LAW. SURVEY OF: 22 Chateau Terrace, 4564 & 4548 Main Street and 17 Fruehauf Avenue, Town of Amherst SBL No. 68.17–6–219,20,21&2



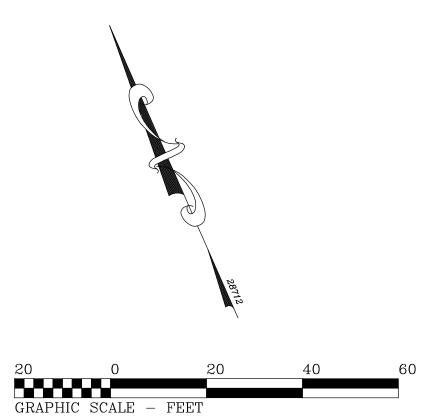

LEGEND

Ø UTILITY / SERVICE POLE W WATER LINE VALVE FIRE HYDRANT \boxplus D.I. (DROP INLET - STORM) D MANHOLE (STORM) E MANHOLE (ELECTRIC) ® MANHOLE (TRAFFIC) S MANHOLE (SANITARY) (T) MANHOLE (TELEPHONE)

GASLINE MARKER M GAS LINE VALVE \times LIGHT STANDARD

—॑— *SIGN* H.C. HANDICAP R.O.W. RIGHT OF WAY

CONC. CONCRETE INV. INVERT M.H. MANHOLE

—G— GAS LINE ─₩─ WATER LINE

—T— TELEPHONE LINE —E— ELECTRIC LINE

—P— *UTILITY LINES* —C— CABLE LINES


D. DEED M. MEASURED

L. LIBER

P. PAGE

SUBLOT 1 & 2 ~ MAP IN LIBER 1416 DEEDS PAGE 349 AND SUBLOT 1 & 2 ~ MAP IN MAP COVER 864 & 936

INSTRUMENT(S) UTILIZED IN DETERMINING LOCATION OF BOUNDARY LINES: HEAD OF SEARCH THIS SURVEY WAS PREPARED WITHOUT THE BENEFIT OF A CURRENT ABSTRACT OF TITLE AND IS SUBJECT TO ANY STATE OF FACTS THAT MAY BE REVEALED IN SAID ABSTRACT. NOTE: PROPERTY CORNER MONUMENTS WERE NOT PLACED AS PART OF THIS SURVEY.

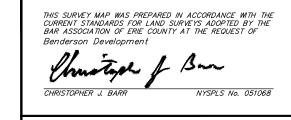

COPYRIGHT_2024_ BY:	
A TRUE NOI	RTH
LAND SURVEYING	à, PLLC
150 AERO DRIVE	
BUFFALO, NEW YORK 14	225
716)631-5140 ~ Truenortholl	c@aol.com

AMEND:

SURVEY DATE: 5-16-24 $^{\odot}$ DRAWING DATE: 5-17-24

"ALL RIGHTS RESERVED"

SCALE: 1" = 20'

SURVEY OF: 22 Chateau Terrace, 4564 & 4548 Main Street and 17 Fruehauf Avenue, Town of Amherst SBL No. 68.17-6-219,20,21&22


0.15 S. & 0.4 W. With Light NG 23 Verizon 23 30" Maple Tree 1.6 S. & 0.2 W. Fence 0.12 S.-Fnd. Pipe On Line & 0.6 V 10' x 20' concrete wash area, Grasslined with a polyethylene sheet. location subject to change Construction Entrance Inv. S.W. 674.93 (8") Rim 680.93 Inv. N-S 677.03 (8") Temporary "Construction Site Entrance Only" Sign Catch Basin Rim 675.46 Sump 673.47 49 5 J. J. **(5)** 185.64' Signal, Polo 🗣 🚽 P 🧸 -----*\$*-----\3 (12) Storm/Sanitary M.H.— Rim 684.87 Inv. W−E 680.97 (12") <u>Inv</u>. Unable to A<u>ccess</u>

DEMOLITION & EROSION NOTES

- 1. USE NOTED ENTRANCE FOR CONSTRUCTION ENTRANCE
- 2. INSTALL TEMPORARY EROSION CONTROL DEVICES AS DIRECTED WITHIN THE WORKING AREA TO PREVENT SEDIMENT MIGRATION. ALL EROSION CONTROL DEVICES SHALL BE INSTALLED IN ACCORDANCE WITH THE
- 3. ALL EROSION CONTROL DEVICES SHALL BE REPLACED WHEREVER THEY BECOME INOPERABLE.
- 4. THE CONTRACTOR SHALL BE RESPONSIBLE FOR MAINTENANCE AND REMOVAL OF TEMPORARY 5. THE CONTRACTOR MUST CONTROL DUST DURING CONSTRUCTION, DURING EARTHWORK OPERATIONS,
- WATER-SPREADING EQUIPMENT SHALL BE PROVIDED BY THE CONTRACTOR, AND WATER SPREAD AS NECESSARY AND AS DIRECTED IN ORDER TO CONTROL DUST.
- 6. DIRT OR DEBRIS LEFT ON LOCAL PUBLIC ROADS AS A RESULT OF THIS CONSTRUCTION PROJECT SHALL BE REMOVED AND ROAD SURFACES CLEANED BY THE CONTRACTORS ON A DAILY BASIS, OR MORE FREQUENTLY IF DEEMED NECESSARY 7. ALL DISTURBED AREAS (EXCEPT AREAS TO BE PAVED OR BUILT UPON) SHALL BE TOPSOILED TO A MINIMUM
- OF 4" DEPTH AND SEEDED IMMEDIATELY AFTER FINE GRADING TAKES PLACE AND AS SOON AS PHYSICALLY 8. THE CONTRACTOR IS RESPONSIBLY FOR THE MAINTENANCE OF DOWNSTREAM STORM SEWERS, DITCHES AND CULVERTS. SILT BUILDUP FOUND TO BE A RESULT OF THIS SITE CONSTRUCTION WORK SHALL BE REMOVED FROM DOWNSTREAM CULVERTS, DETENTION PONDS, BY THE CONTRACTOR AT NO ADDITIONAL
- EXPENSE TO THE OWNER OR CITY. 9. ALL SOIL EROSION AND SEDIMENT CONTROL DEVICES AND MATERIALS SHALL BE IN PLACE PRIOR TO BEGINNING EARTHWORK OPERATIONS AND SHALL BE MAINTAINED UNTIL THE ALL GRADING WORKS ARE

COMPLETE.

- INSTALL ALL MATERIALS TO MANUFACTURER'S RECOMMENDATIONS AND BEST STANDARDS OF TRADE INVOLVED.
- . SUBSTITUTIONS SHALL BE MADE ONLY WITH OWNER'S APPROVAL AND BE OF EQUIVALENT QUALITY TO WHAT IS SPECIFIED.
- . WORK SHALL BE COMPLETED IN STRICT ACCORDANCE WITH ALL LOCAL CODES AND OSHA SAFETY RULES AND REGULATIONS. 4. CONTRACTOR SHALL VERIFY ALL EXISTING CONDITIONS AND DIMENSIONS AT THE SITE. NOTIFY OWNER & ENGINEER OF DISCREPANCIES IN
- CONDITIONS SHOWN ON DRAWINGS PRIOR TO PROCEEDING WITH THE WORK. 5. CONTRACTOR SHALL BE RESPONSIBLE FOR PROTECTION OF ANY EXISTING STRUCTURES TO REMAIN AND ANY FINISH MATERIAL INSTALLED WHILE
- WORKING ON OTHER COMPONENTS. 6. CONTRACTOR SHALL KEEP JOB FREE OF DEBRIS AND MAKE FINAL CLEANUP TO THE SATISFACTION OF OWNER.
- . CONTRACTOR SHALL ASCERTAIN THE LOCATION OF ALL UTILITIES PRIOR TO CONSTRUCTION SO THAT THIS WORK WILL NOT DISTURB EXISTING LINES AND/OR INSTALLATIONS EXCEPT AS DETAILED ON THE PLANS. COORDINATE ALL WORK WITH THE APPLICABLE UTILITY COMPANIES.
- B. $\,$ CONTRACTOR SHALL OBTAIN AND PAY FOR ALL REQUIRED PERMITS NECESSARY TO PERFORM THE WORK.
- BUILDING DIMENSIONS ARE APPROXIMATE. REFER TO ARCHITECTURAL DRAWINGS FOR LAYOUT DIMENSIONS.
- 10. SIDEWALK DIMENSIONS ARE APPROXIMATE. REFER TO ARCHITECTURAL DRAWINGS FOR THE SIDEWALK PLAN. CONCRETE SIDEWALK SEALERS: (REFER TO ARCHITECTURAL PLANS FOR LOCATION OF CONCRETE TYPES.)
- 11.1. GREY CONCRETE SIDEWALKS SHALL HAVE CHEMMASTERS SILENCURE WITHIN 2HRS AFTER FINAL FINISHING OF CONCRETE AND ALL
- 11.2. EXPOSED AGGREGATE/STAMPED CONCRETE SIDEWALKS SHALL HAVE ONE (x1) COAT CHEMMASTERS SILENCURE AS SOON AS CONCRETE
- HAS DRIED AFTER PRESSURE-WASHING THE RELEASE AGENT OFF. APRX 30 DAYS AFTER THIS (IF WEATHER PERMITS) APPLY ONE (x1) COAT OF CHEMMASTERS - POLYSEAL EZ.
- 12. LIGHTING FIXTURE ARROW SYMBOLS REFER TO THE DIRECTION THAT THE FIXTURES ARE REQUIRED TO
- FACE. SPECIFIC MOUNT BRACKETS WILL BE REQUIRED DEPENDING ON ORIENTATION AND FIXTURE COUNT. 13. CURB ISLAND DIMENSIONS ARE FROM INSIDE OF CURB TO INSIDE OF CURB.
- 14. CONTRACTOR TO PROVIDE NEW PAVEMENT THAT CONFORMS TO THE GRADING PLAN WHILE MAINTAINING, AS A MINIMUM, THE EXISTING STONE BASE. THE MEANS AND METHODS OF OBTAINING NEW GRADES IS LEFT UP TO THE CONTRACTOR AND CAN BE OBTAINED VIA SHIMMING THE PAVEMENT AND THEN A NEW TOP COAT, REMOVING EXISTING ASPHALT PAVEMENT AND REGRADING EXISTING STONE BASE, A COMBINATION OF THESE TWO OR ANOTHER METHOD OF THE CONTRACTORS CHOOSING. FINAL PAVEMENT WORK PLAN SHALL BE PROVIDED TO OWNER AND ENGINEER FOR REVIEW AND APPROVAL

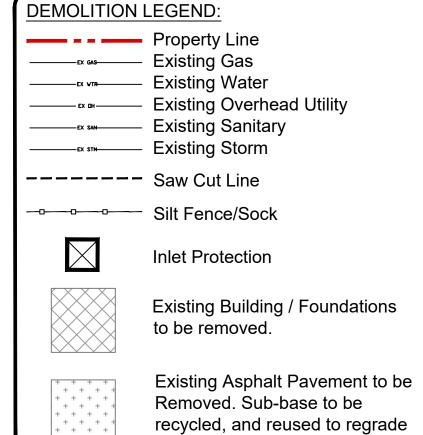

DEMOLITION NOTES: (#) Existing Building / Foundations to be Removed. Follow construction sequence for shoring removal of existing foundation walls. Existing Curb to be removed Limits of Curb Removal Existing Asphalt Pavement to be removed and regraded (Refer to General Note 14) Existing Concrete Sidewalk/ Pavement/ Structures to be removed. Existing Storm Drainage/CB to remain and be protected during Construction. Existing Storm Drainage/CB to be removed. Existing Utility Structure to remain and be protected during Construction. Existing Utility Structure to be removed. 10. Existing Fence to be removed. Existing Landscaping to be removed. 12. Existing Landscaping to Remain and be protected during construction.

CONSULTANT JAMES ALLEN RUMSEY ARCHITECT **BENDERSON** DEVELOPMENT 570 DELAWARE AVE., BUFFALO, NY 14202 (716) 886-0211 SEAL Demolition and **Erosion Control** 1" = 20' DRAWN BY: DRAWING NO. DMZ MAO DATE: 04.16.2025

OFFICIAL TOWN USE ONLY

DRAWING REVISIONS:

No. DATE BY REMARKS

SPECIAL INFORMATION:

OWNERS ACCEPTANCE.

AND ALL STRUCTURES.

PROPERTY NUMBER:

#5202

ALL CONTRACTORS SHALL GUARANTEE THEIR WORK FOR A PERIOD OF ONE YEAR FROM THE DATE OF

SHOP DRAWING SUBMITTALS ARE REQUIRED FOR ANY

UNAUTHORIZED ALTERATIONS OF THIS DOCUMENT ARE IN VIOLATION OF SECTION #7209 OF THE STATE

CONSTRUCTION SET

Know what's **below.**

AREA:


S

0

0

05.27.2025 DZ Coordination Notes


and Town Comments

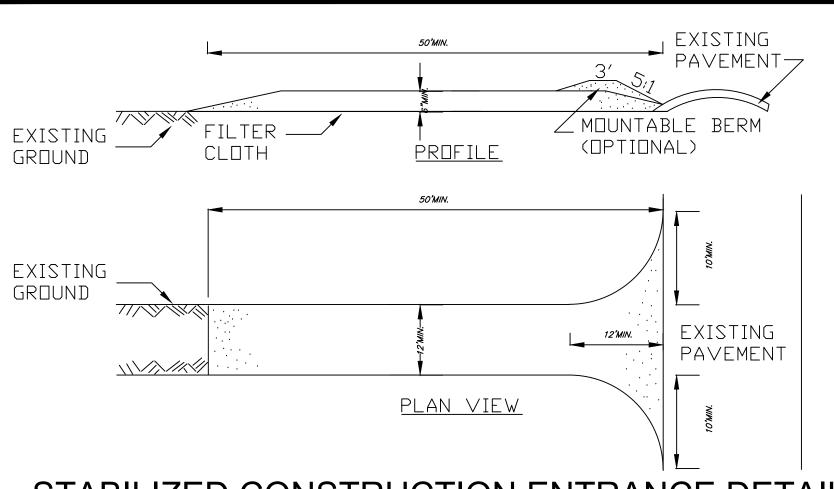



STABILIZED CONSTRUCTION ENTRANCE DETAIL

NOT TO SCALE

- 1. STONE SIZE USE 2" STONE, OR RECLAIMED OR RECYCLED CONCRETE EQUIVALENT.
- 2. LENGTH NOT LESS THAN 50 FEET (EXCEPT ON A SINGLE RESIDENCE LOT WHERE A 30 FOOT MINIMUM LENGTH WOULD APPLY).
- 3. THICKNESS NOT LESS THAN SIX (6) INCHES.
- 4. WIDTH TWELVE (12) FOOT MINIMUM, BUT NOT LESS THAN THE FULL WIDTH AT POINTS WHERE INGRESS OR EGRESS OCCURS. TWENTY-FOUR (24) FOOT IF SINGLE ENTRANCE TO SITE.
- 5. FILTER CLOTH WILL BE PLACED OVER THE ENTIRE AREA PRIOR TO PLACING OF STONE.
- 6. SURFACE WATER ALL SURFACE WATER FLOWING OR DIVERTED TOWARD CON-STRUCTION ENTRANCES SHALL BE PIPED ACROSS THE ENTRANCE. IF PIPING IS IMPRACTICAL, A MOUNTABLE BERM WITH 5:1 SLOPES WILL BE PERMITTED.
- 7. MAINTENANCE THE ENTRANCE SHALL BE MAINTAINED IN A CONDITION WHICH WILL PREVENT TRACKING OR FLOWING OF SEDIMENT ONTO PUBLIC RIGHTS-OF-WAY, ALL SEDIMENT SPILLED, DROPPED, WASHED OR TRACTED ONTO PUBLIC RIGHTS-OF-WAY MUST BE REMOVED IMMEDIATELY.
- 8. WHEN WASHING IS REQUIRED, IT SHALL BE DONE ON A AREA STABILIZED WITH STONE AND WHICH DRAINS INTO AN APPROVED SEDIMENT TRAPPING DEVICE.
- 9. PERIODIC INSPECTION AND NEEDED MAINTENANCE SHALL BE PROVIDED AFTER EACH RAIN.

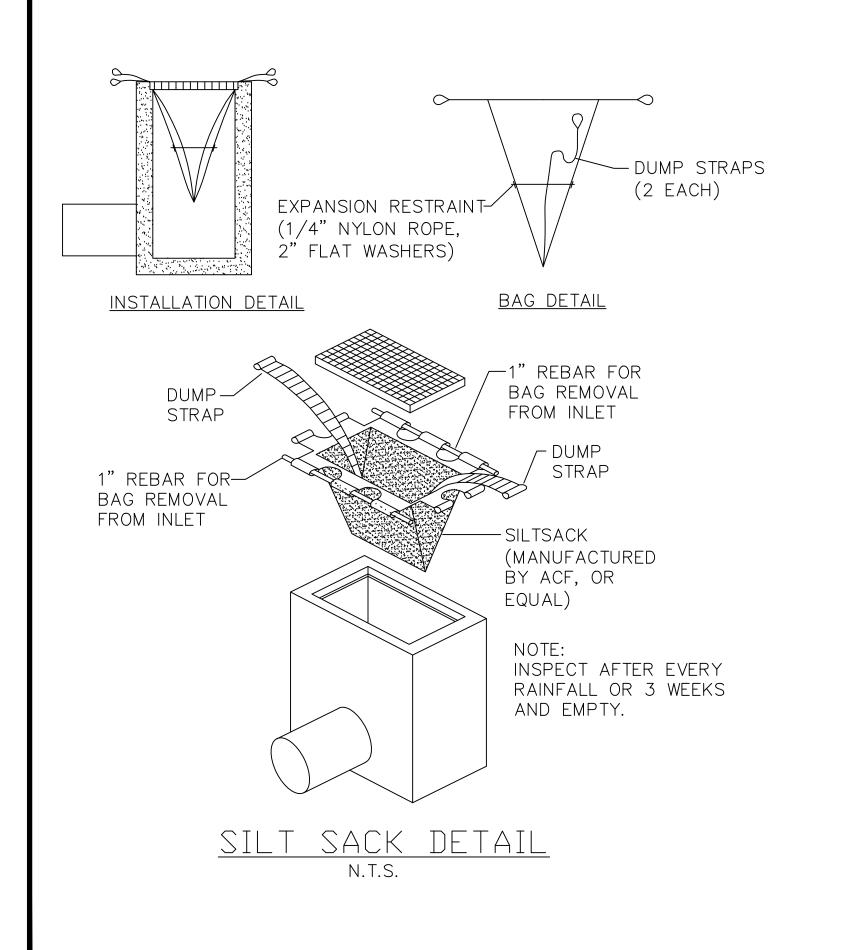


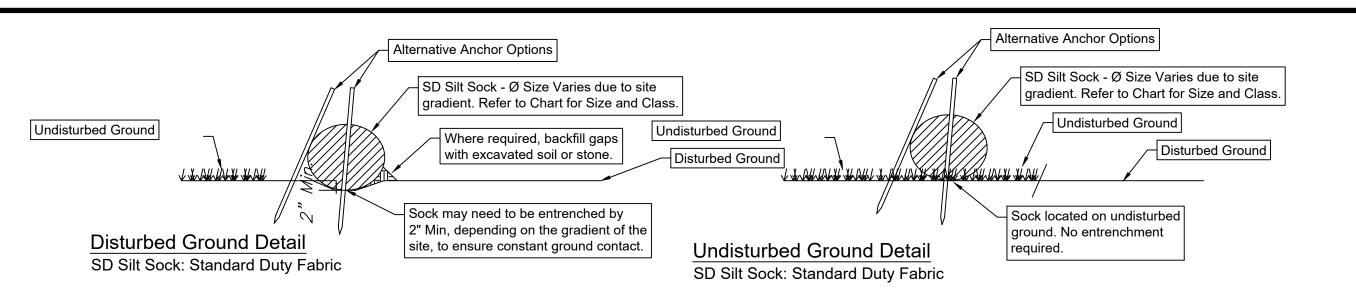

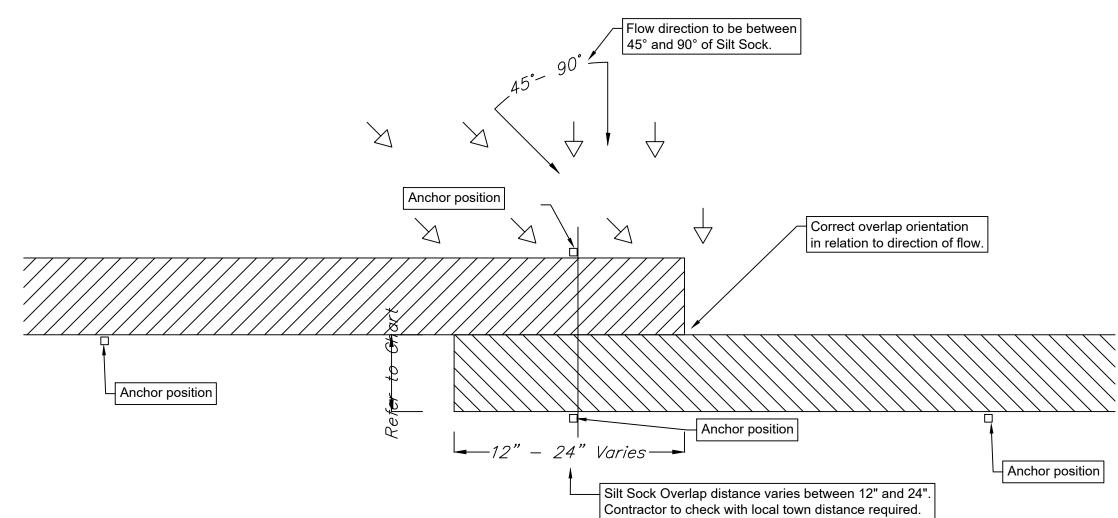


Overlap Detail - PLAN


1) Anchors required at the overlap section are to stay outside the Silt Sock and not pierce through the material. See alternative anchor positons in details above.

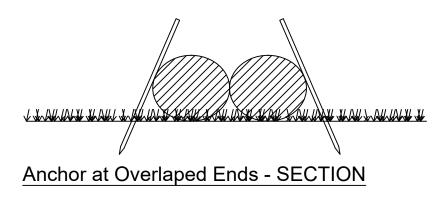

Size & Class Chart						
	D	Diameter				
Gradient	8"	12"	18"			
0 - 2%	30	55	75			
2.1 - 5%	25 40 55					
5.1 - 10%	15	30	40			
10.1 - 33%	10	15	20			
> 33%	5	10	15			

SD SILT SOCK DETAIL SD Silt Sock: Standard Duty Fabric

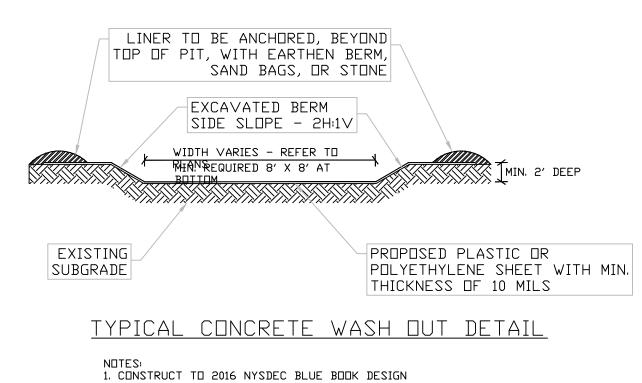

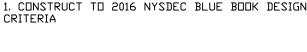


Back fill any gaps.

- 1 Do not use sock below the normal watermark or perpendicular to flow in river and where the maximum incline is greater than 50%.
- 2 Contractors should be aware of federal, state and local laws, rules regulations or permit requirements for the use of Silt Socks on site.
- 3 Sock should be positioned on the outline of the area to be protected, but must be
- installed between 45° to 90° from directions of flow. 4 - Sock may be required to be entrenched a minimum of 2" on disturbed ground to ensure constant ground contact.
- 5 All gaps and ruts must be backfilled with soil or sock material.
- 6 Sock overlap should be in the direction of the flow. Overlap amount will be between 12" and 24". Contractor to check with local town for requirements.
- 7 If sediment collects to 1/2 the height of the sock, then a second sock may be stacked immediately up slope of the original instead of removing the sediment.
- 8 Sock joint is where two sock sections meet on a level grade, overlap and adjoining ends, tightening the ends together, and anchoring through each end. Where two sections meet on un-level ground, j-hook higher elevated end, anchor, and begin new section just below.
- 9 Sock should be inspected and repaired as needed.
- 10 If ruts begin under the sock they should be backfilled with soil and compacted so that the ground and sock have continuous contact.
- 11 If sock rolls out of place, the sock should be repositioned and secured with additional
- 12 Tears in the Sock fabric may be repaired by wrapping a new piece of fabric over the sock and securing, or by place a second sock immediately up slope with the required overlap beyond deformation.
- 13 A section of sock should be replaced whenever it has weakened to such an extent that the efficiency is reduced or diminished. Weakening can occur because the natural mesh fabric breaks down over time of from being moved/dragged on site.
- 14 Sock should be replaced when sediment has built up and has been removed three
- 15 All sediment in disturbed area next to sock must be removed and correctly disposed of before the sock can be removed.

OFFICIAL TOWN USE ONLY

- 16 When removing, cut sock open and spread the filler material around. The netting
- should be removed from site.
- 17 Sock should be installed before works commence on site.

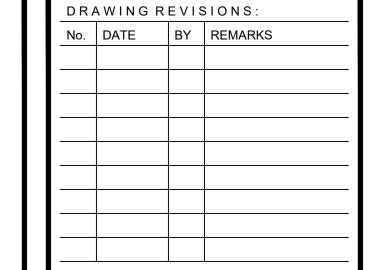

SPECIAL INFORMATION ALL CONTRACTORS SHALL GUARANTEE THEIR WORK FOR A PERIOD OF ONE YEAR FROM THE DATE OF OWNERS ACCEPTANCE.

SHOP DRAWING SUBMITTALS ARE REQUIRED FOR ANY

UNAUTHORIZED ALTERATIONS OF THIS DOCUMENT ARE IN VIOLATION OF SECTION #7209 OF THE STATE

CONSTRUCTION SET





AREA:

PROPERTY NUMBER: #5202

St.

er

nyder

Ш Ш S 0


PA

CONSULTANT

JAMES ALLEN RUMSEY

570 DELAWARE AVE., BUFFALO, NY 14202 (716) 886-0211

SEAL

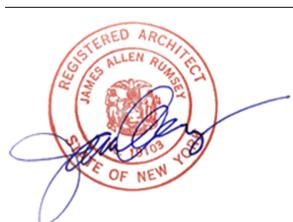


Demolition and Erosion **Control Details**

DRAWN BY:

DATE: 04.16.2025


DRAWING NO. DMZ MAO

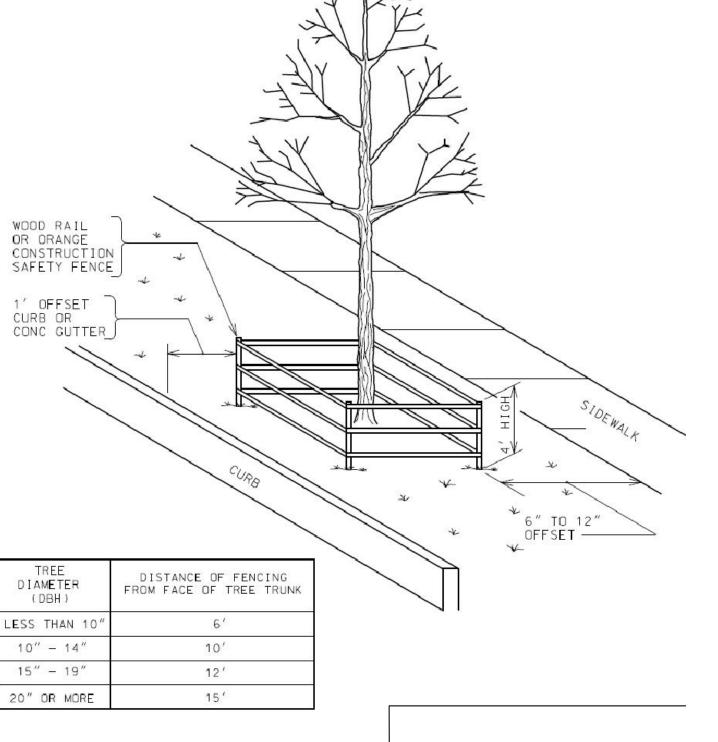

NOTE:

1. ALL TREES WITHIN THE PROJECT LIMITS THAT ARE TO REMAIN, ARE TO RECEIVE THIS TREATMENT.

DO NOT LEAVE CONSTRUCTION EQUIPMENT RUNNING (IDLING) UNDER TREE CANDPY.

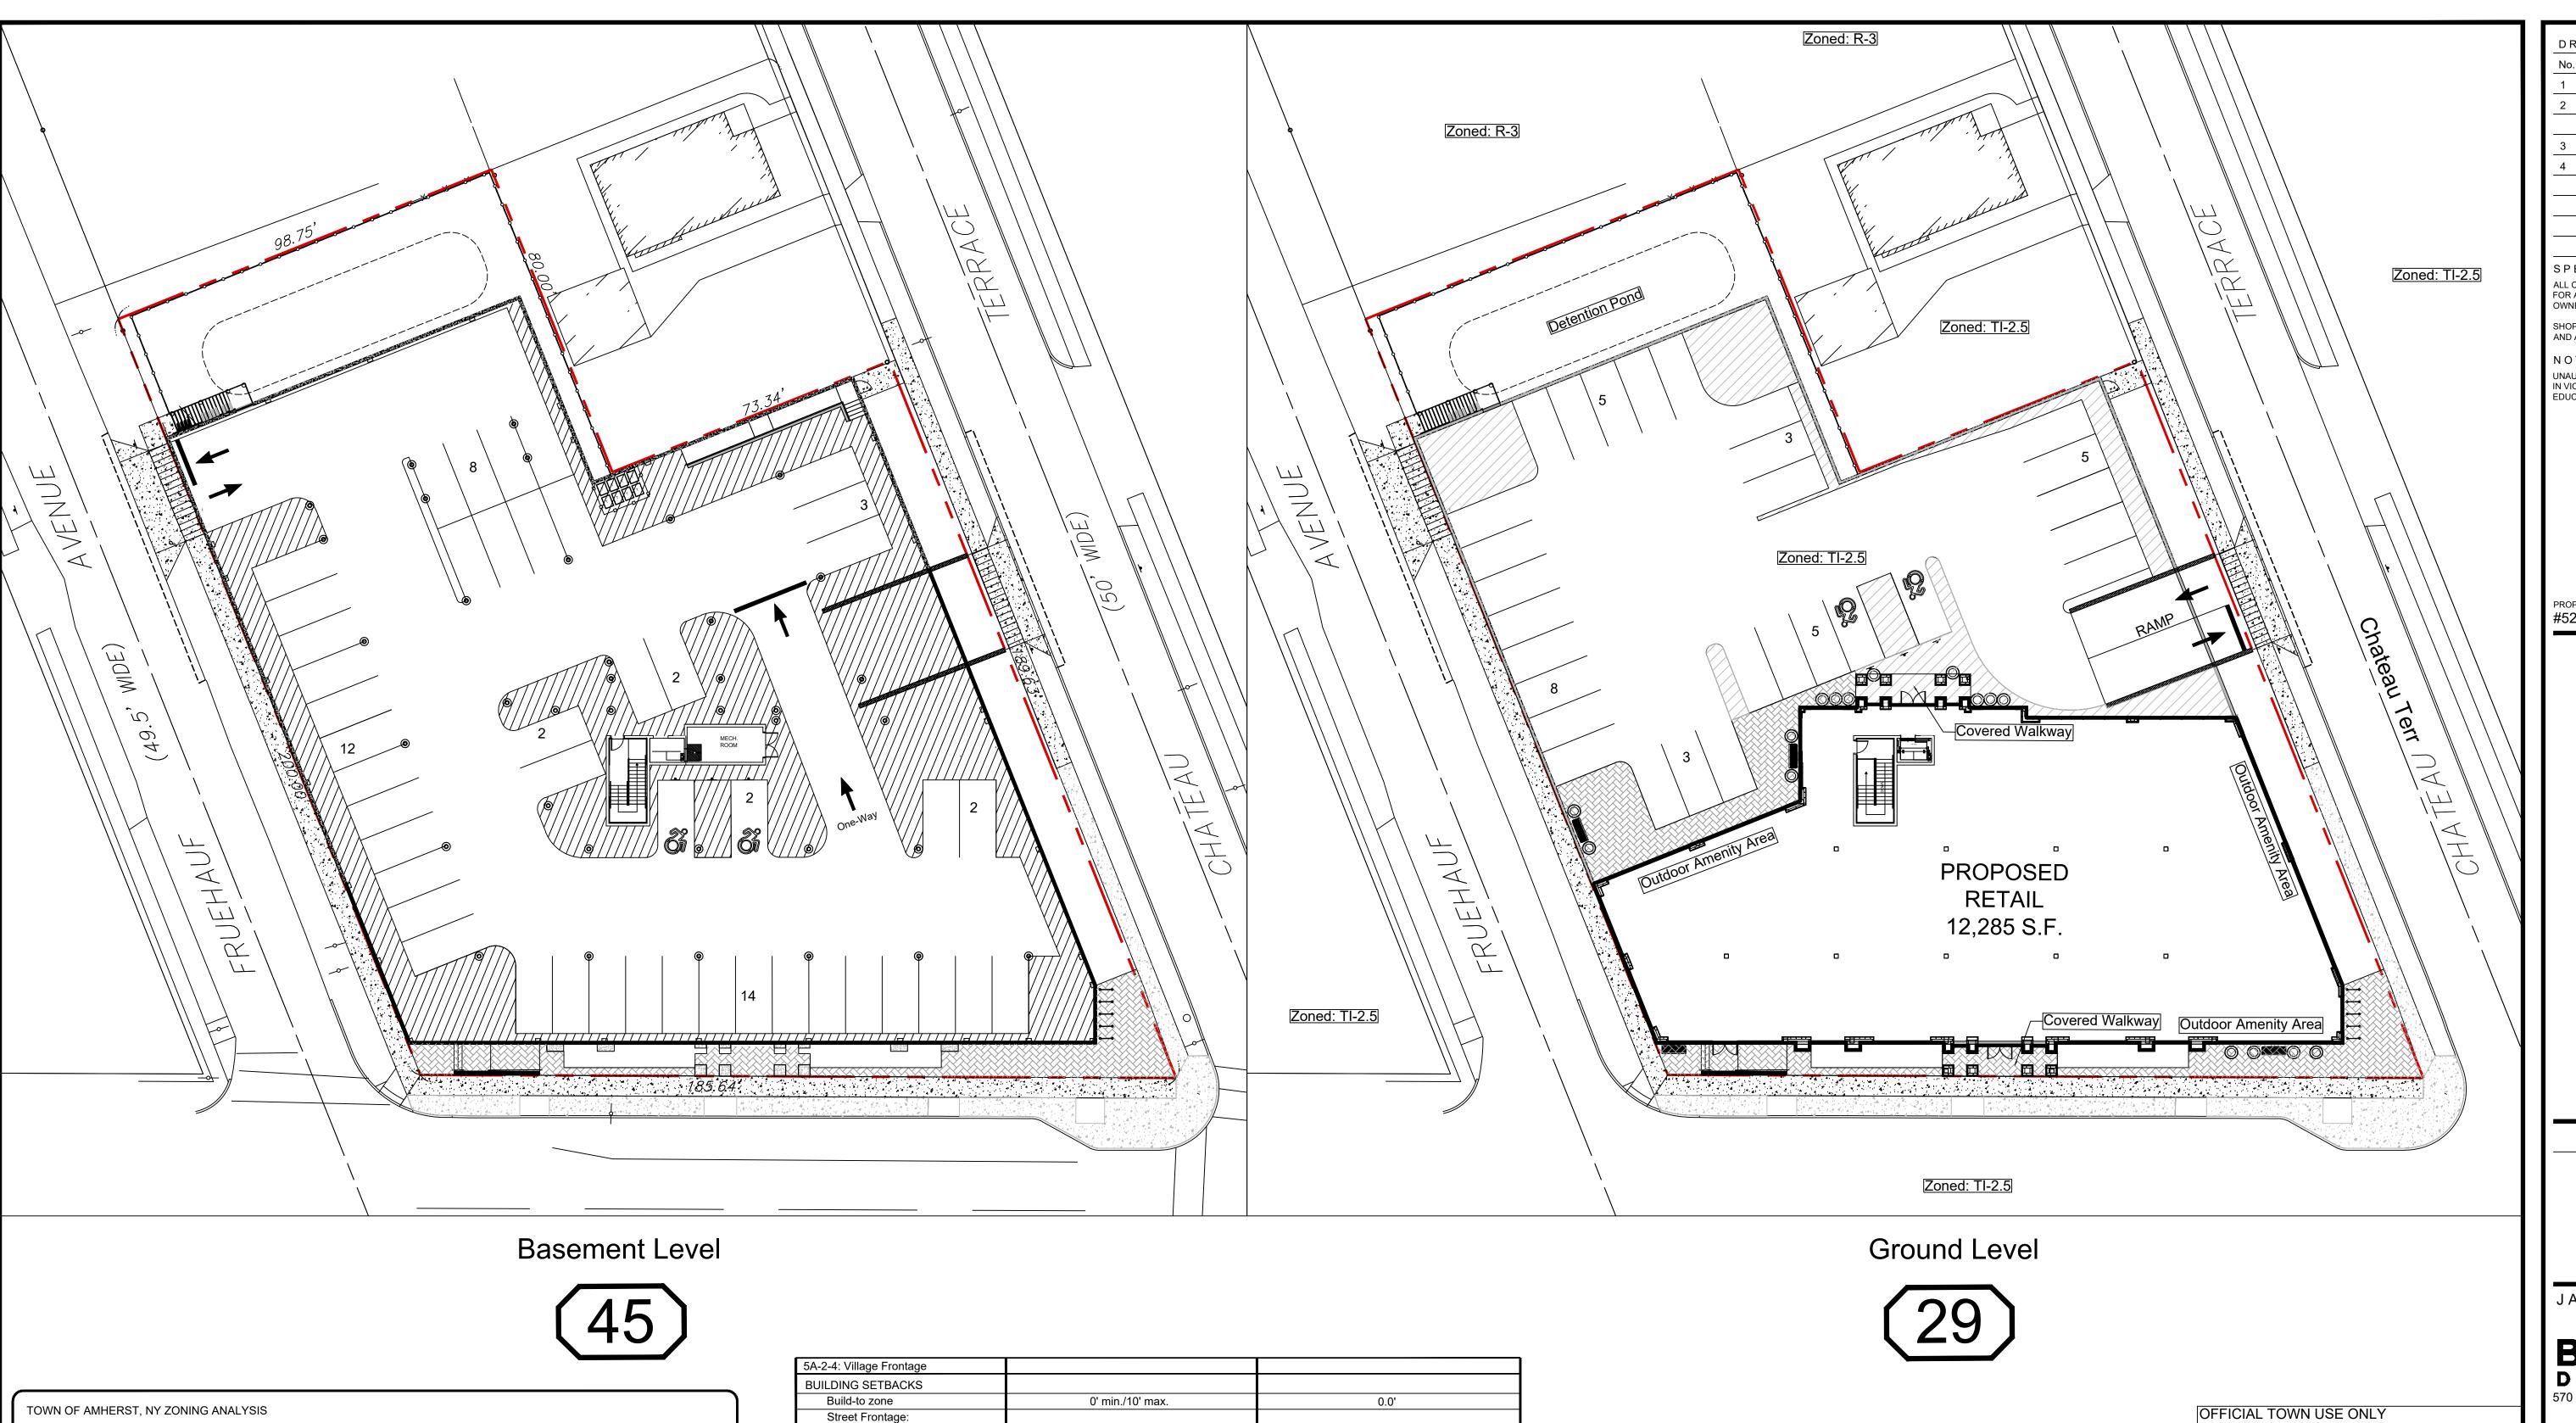

TOWN OF AMHERST, NY ZONIN	IG ANALYSIS	
	REQUIRED	PROVIDED
ZONED	TI-2.5 (Village Frontage)	TI-2.5 (Village Frontage)
5A-1-3: TI-2.5 Traditional Infill 2.5 So	ection	
LOT		
Area	0 S.F. min.	34,542 S.F.
Width	0' min.	170.7'
Outdoor Amenity Space	10% min. = 3,454 S.F.	3,590 S.F. = 10.4%
w/ Green Space	25% Min	44.3%
BUILDING SETBACKS		
Building-to-zone	Refer to Section 5A-2 Infill Frontages	
Lot Frontage	Refer to Section 5A-2 Infill Frontages	
Common lot line	0' min.	0.2' (North Side)
Alley	5' min.	N/A
PARKING SETBACKS		
Primary and Side Street	Refer to Section 5A-2 Infill Frontages (below)	
Common lot line	0' min.	3.8' (North Side)
Alley	5' min.	N/A
BUILDING HEIGHT		
Top Plate Height	2 Stories / 24' max.	N/A
Building Height	2.5 Stories / 35' max.	35'-0"
Roof Pitch	18:12 max.	18:12
BUILDING LENGTH	Refer to Section 5A-2 Infill Frontages (below)	168.5'
STORY HEIGHT	Refer to Section 5A-2 Infill Frontages (below)	16.5'

5A-2-4: Village Frontage		
BUILDING SETBACKS		
Build-to zone	0' min./10' max.	0.0'
Street Frontage:		
Front: Main Street	90% min.	90.9% (169.1)
Side: Fruehauf Ave		80.3% (160.6 / 200)
Side: Chateau Terr.		92.0% (174.4/189.6)
PARKING SETBACKS		
Street	20' min.	52.8' (Main Street)
BUILDING MASS		
Street facing building length:		
Front: Main Street	200' max.	168.5'
STORY HEIGHT		+
Ground floor elevation	0' min. / 2' max.	0.0'
Ground story height	13' min.	16.5'
Upper story height	9' min.	12.5'
TRANSPARENCY		
Ground story	70% min.	70.1%
Upper story	20% min.	41.0%
Blank wall length	15' max.	4.0'
PEDESTRIAN ACCESS		
Street facing entrance	Required	Complies
Entrance spacing	50' max.	Complies
STREETSCAPE		
Clear pedestrian zone	10' min.	40 Ol Total - Frieding Compilition
Curb zone	6' min.	10.3' Total - Existing Condition
Tree planting type	Grates	Complies
Tree spacing	35' on-center avg.	Existing: 33.3' c-c Average

PROPOSED F	PARKING ANAYLSIS	S TI-2.5	
PROPOSED F	PARKING ANAYLSIS	S TI-2.5 REQUIRED	
USE	CODE	REQUIRED 12,285 sqft / 1000 x 2.5 =	

DRAWING REVISIONS: No. DATE BY REMARKS 04.29.2025 DZ Arch Updates 05.27.2025 DZ Coordination Notes and Town Comments 06.04.2025 DZ Town Meeting Update 07.14.2025 DZ Site Updates SPECIAL INFORMATION:

ALL CONTRACTORS SHALL GUARANTEE THEIR WORK FOR A PERIOD OF ONE YEAR FROM THE DATE OF OWNERS ACCEPTANCE.

SHOP DRAWING SUBMITTALS ARE REQUIRED FOR ANY AND ALL STRUCTURES.

UNAUTHORIZED ALTERATIONS OF THIS DOCUMENT ARE IN VIOLATION OF SECTION #7209 OF THE STATE EDUCATION LAW.

CONSTRUCTION SET





PROPERTY NUMBER:


AREA:

PROP

CONSULTANT

JAMES ALLEN RUMSEY
ARCHITECT
PREPARED FOR

570 DELAWARE AVE., BUFFALO, NY 14202 (716) 886-0211

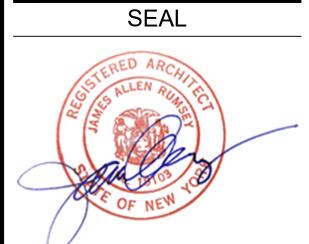


Overall Site Plan


1" = 20' DRAWN BY:

DRAWING NO. DMZ CHECKED BY: MAO DATE: 04.16.2025


Proposed Outdoor Amenity Space

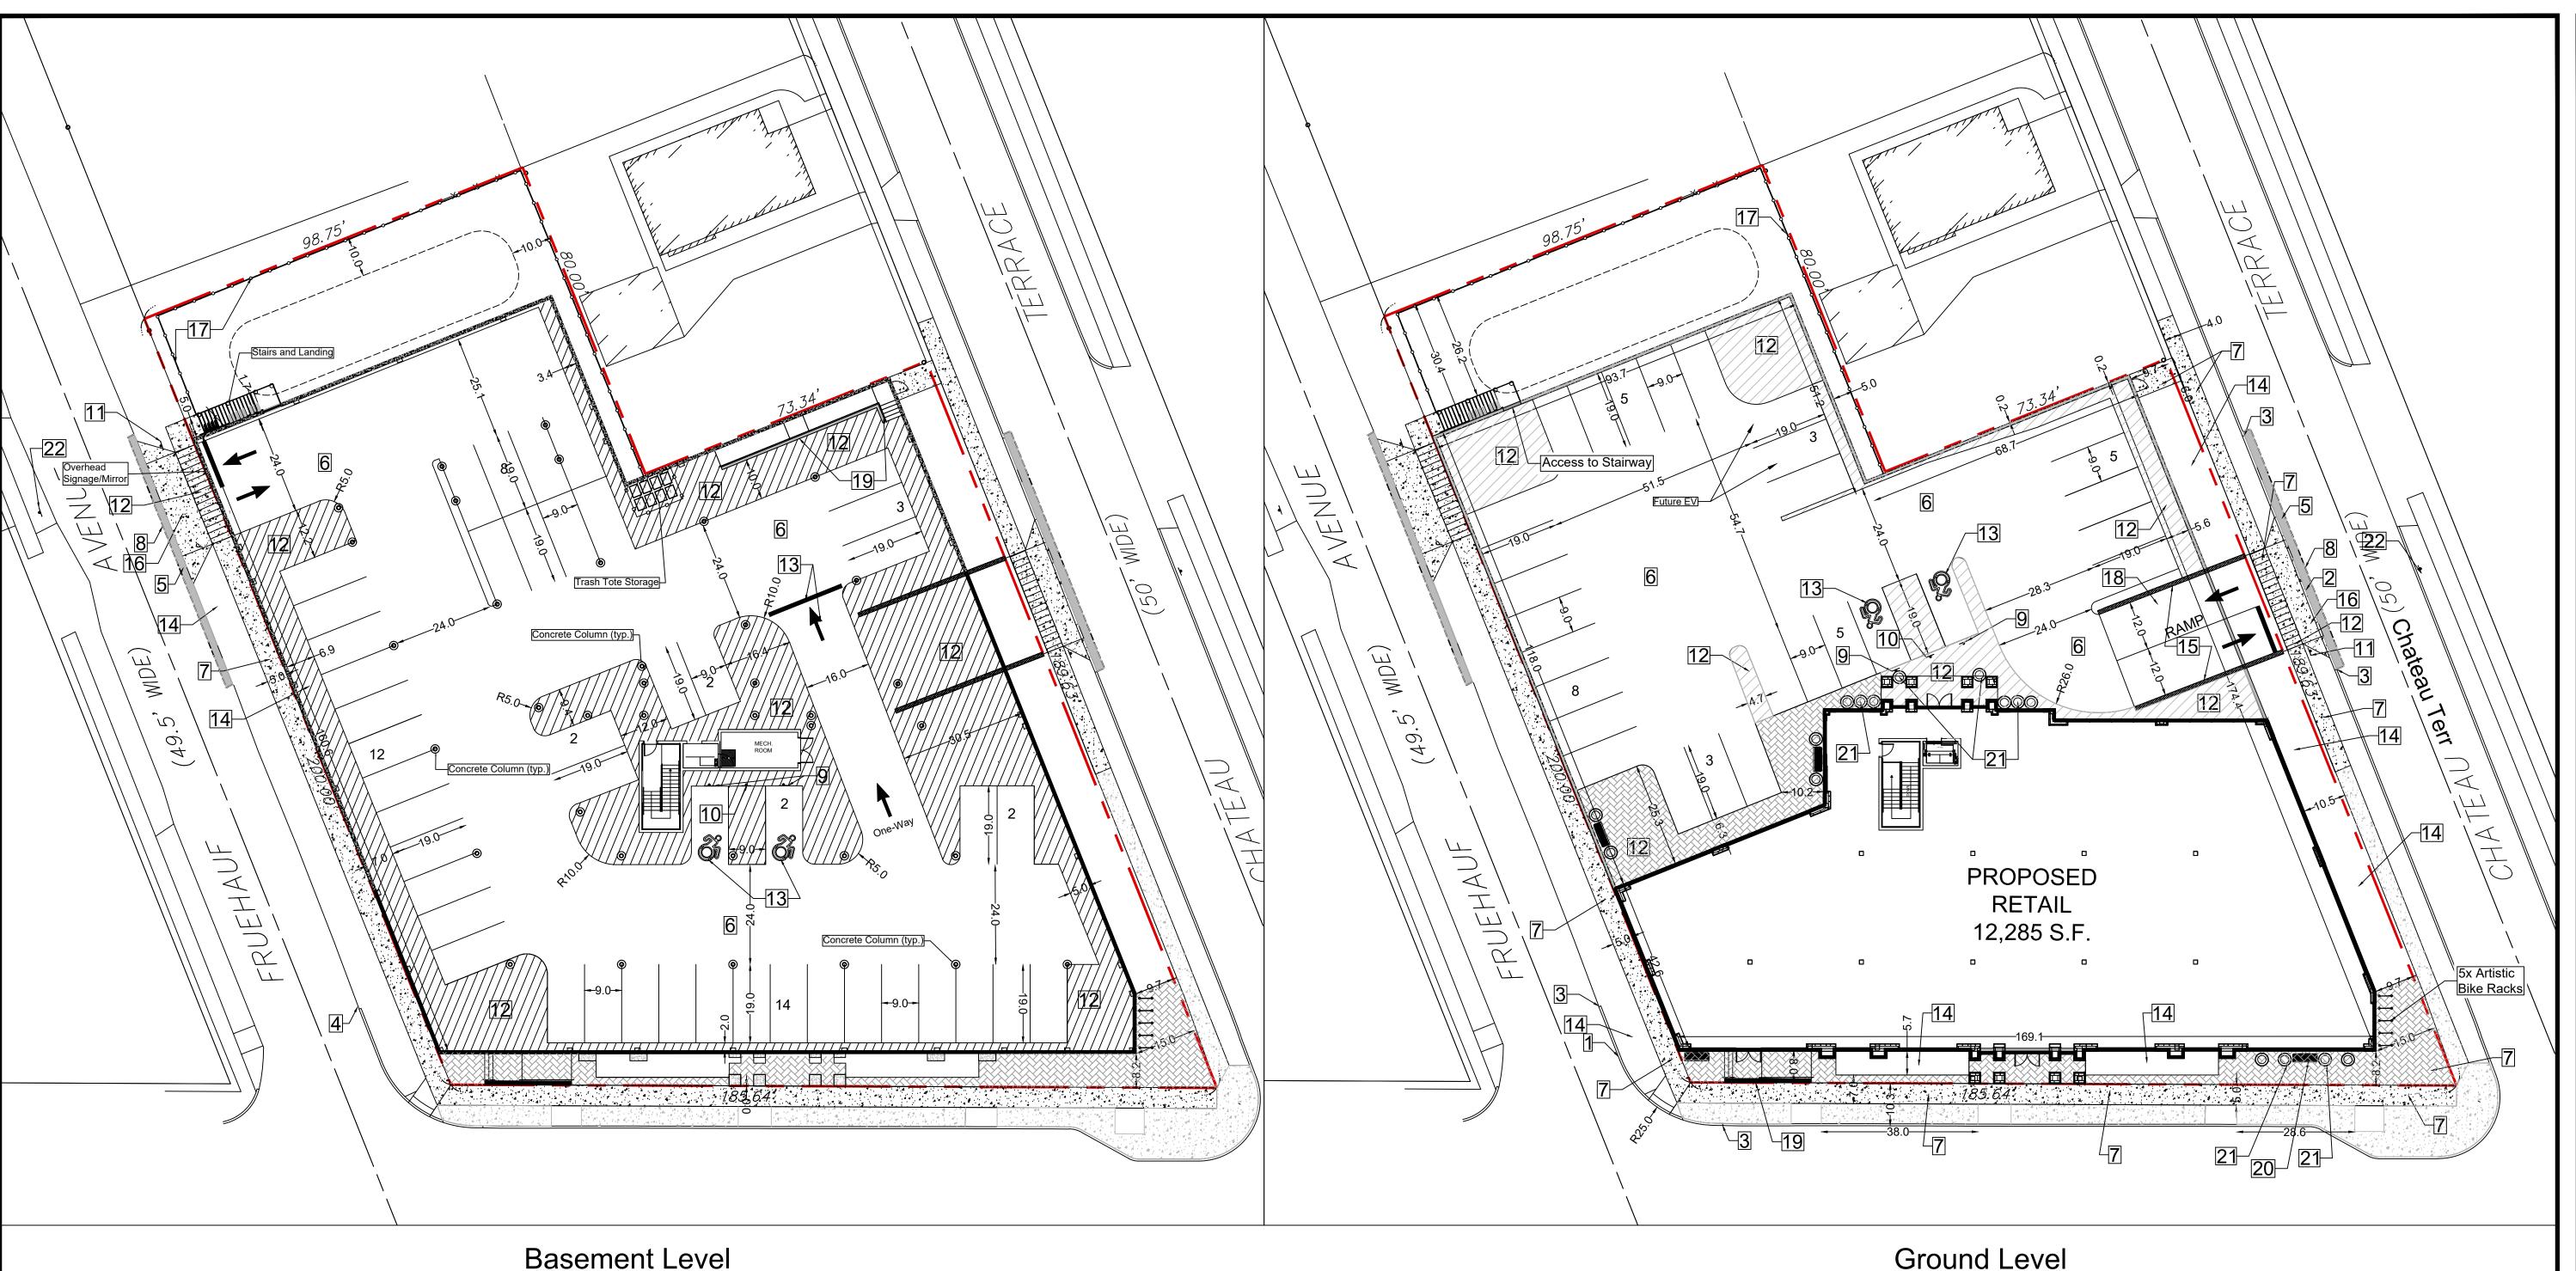

Ground Level

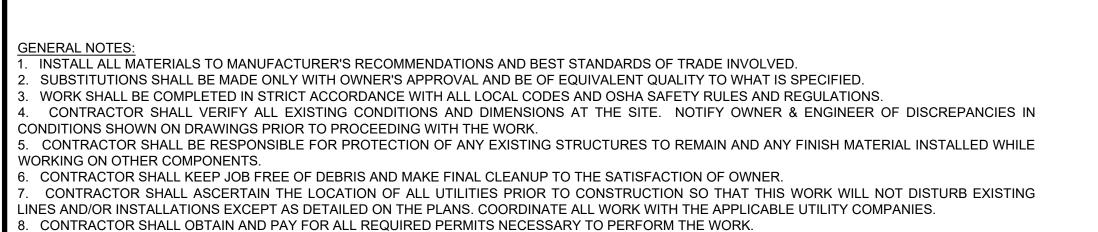

- 9. BUILDING DIMENSIONS ARE APPROXIMATE. REFER TO ARCHITECTURAL DRAWINGS FOR LAYOUT DIMENSIONS.
- $10.\;\;$ SIDEWALK DIMENSIONS ARE APPROXIMATE. REFER TO ARCHITECTURAL DRAWINGS FOR THE SIDEWALK PLAN .
- CONCRETE SIDEWALK SEALERS: (REFER TO ARCHITECTURAL PLANS FOR LOCATION OF CONCRETE TYPES.) 11.1. GREY CONCRETE SIDEWALKS SHALL HAVE CHEMMASTERS - SILENCURE WITHIN 2HRS AFTER FINAL FINISHING OF CONCRETE AND ALL
- BLEED WATER HAS DISSIPATED. 11.2. EXPOSED AGGREGATE/STAMPED CONCRETE SIDEWALKS SHALL HAVE ONE (x1) COAT CHEMMASTERS - SILENCURE AS SOON AS CONCRETE
- HAS DRIED AFTER PRESSURE-WASHING THE RELEASE AGENT OFF. APRX 30 DAYS AFTER THIS (IF WEATHER PERMITS) APPLY ONE (x1) COAT OF
- 12. LIGHTING FIXTURE ARROW SYMBOLS REFER TO THE DIRECTION THAT THE FIXTURES ARE REQUIRED TO
- FACE. SPECIFIC MOUNT BRACKETS WILL BE REQUIRED DEPENDING ON ORIENTATION AND FIXTURE COUNT.
- 13. CURB ISLAND DIMENSIONS ARE FROM INSIDE OF CURB TO INSIDE OF CURB. 14. CONTRACTOR TO PROVIDE NEW PAVEMENT THAT CONFORMS TO THE GRADING PLAN WHILE MAINTAINING, AS A MINIMUM, THE EXISTING STONE BASE. THE MEANS AND METHODS OF OBTAINING NEW GRADES IS LEFT UP TO THE CONTRACTOR AND CAN BE OBTAINED VIA SHIMMING THE PAVEMENT AND THEN A NEW TOP COAT, REMOVING EXISTING ASPHALT PAVEMENT AND REGRADING EXISTING STONE BASE, A COMBINATION OF THESE TWO OR ANOTHER METHOD OF THE CONTRACTORS CHOOSING. FINAL PAVEMENT WORK PLAN SHALL BE PROVIDED TO OWNER AND ENGINEER FOR REVIEW AND APPROVAL

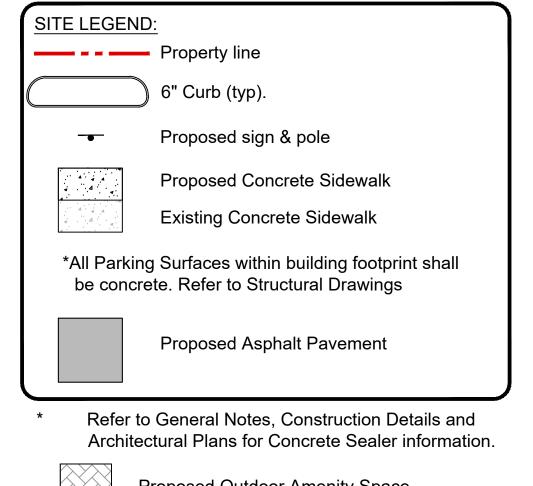



Proposed Outdoor Amenity Space (Paver Surface)



- 1. Proposed 6" concrete Curb.
- 2. Proposed Flush Concrete Curb. Match into Existing Curb or runout over 2'.

OFFICIAL TOWN USE ONLY

- Proposed Edge of Pavement.
- Proposed Standard Duty Pavement. 6. Proposed Concrete Deck / Pavement.
- Refer to Structural Drawings
- Proposed Concrete/Paver Sidewalk.
- Match into Existing Pavement.
- 9. Proposed "Handicapped Parking Only" sign. 10. Proposed "No Parking" sign.
- 11. Proposed STOP Sign.
- zones)

12. 4" Yellow Pavement Stripe (at 2' c-c in no parking

- 13. Proposed White Pavement symbol (stop bar,
- directional arrows, accessibility symbol, text)
- 14. Proposed Landscape Area.
- 15. Proposed Ramp Retaining Wall (Refer to Structural Plans)
- 16. Proposed Concrete Driveway. 17. Proposed Solid Composite Fence
- 18. Proposed Heated Concrete Ramp
- 19. Proposed Ramp/Stairs with retaining wall.
- 20. Proposed Pedestrian Bench
- 21. Proposed Circular Landscape Planter
- 22. Traffic Signage (Restricted No Turn)

DRAWING REVISIONS: DATE BY REMARKS 04.29.2025 DZ Arch Updates 05.27.2025 DZ Coordination Notes and Town Comments 06.04.2025 DZ Town Meeting Update 07.14.2025 DZ Site Updates

SPECIAL INFORMATION: ALL CONTRACTORS SHALL GUARANTEE THEIR WORK FOR A PERIOD OF ONE YEAR FROM THE DATE OF OWNERS ACCEPTANCE.

SHOP DRAWING SUBMITTALS ARE REQUIRED FOR ANY AND ALL STRUCTURES.

UNAUTHORIZED ALTERATIONS OF THIS DOCUMENT ARE IN VIOLATION OF SECTION #7209 OF THE STATE

CONSTRUCTION SET



PROPERTY NUMBER:


0

CONSULTANT

JAMES ALLEN RUMSEY

BENDERSON 570 DELAWARE AVE., BUFFALO, NY 14202

(716) 886-0211

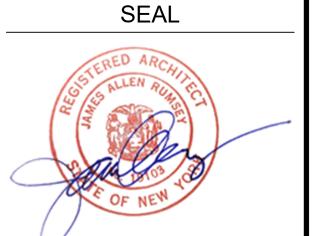


Detailed

Site Plan 1" = 20'

DRAWN BY: DRAWING NO.

DMZ DATE: **04.16.2025**

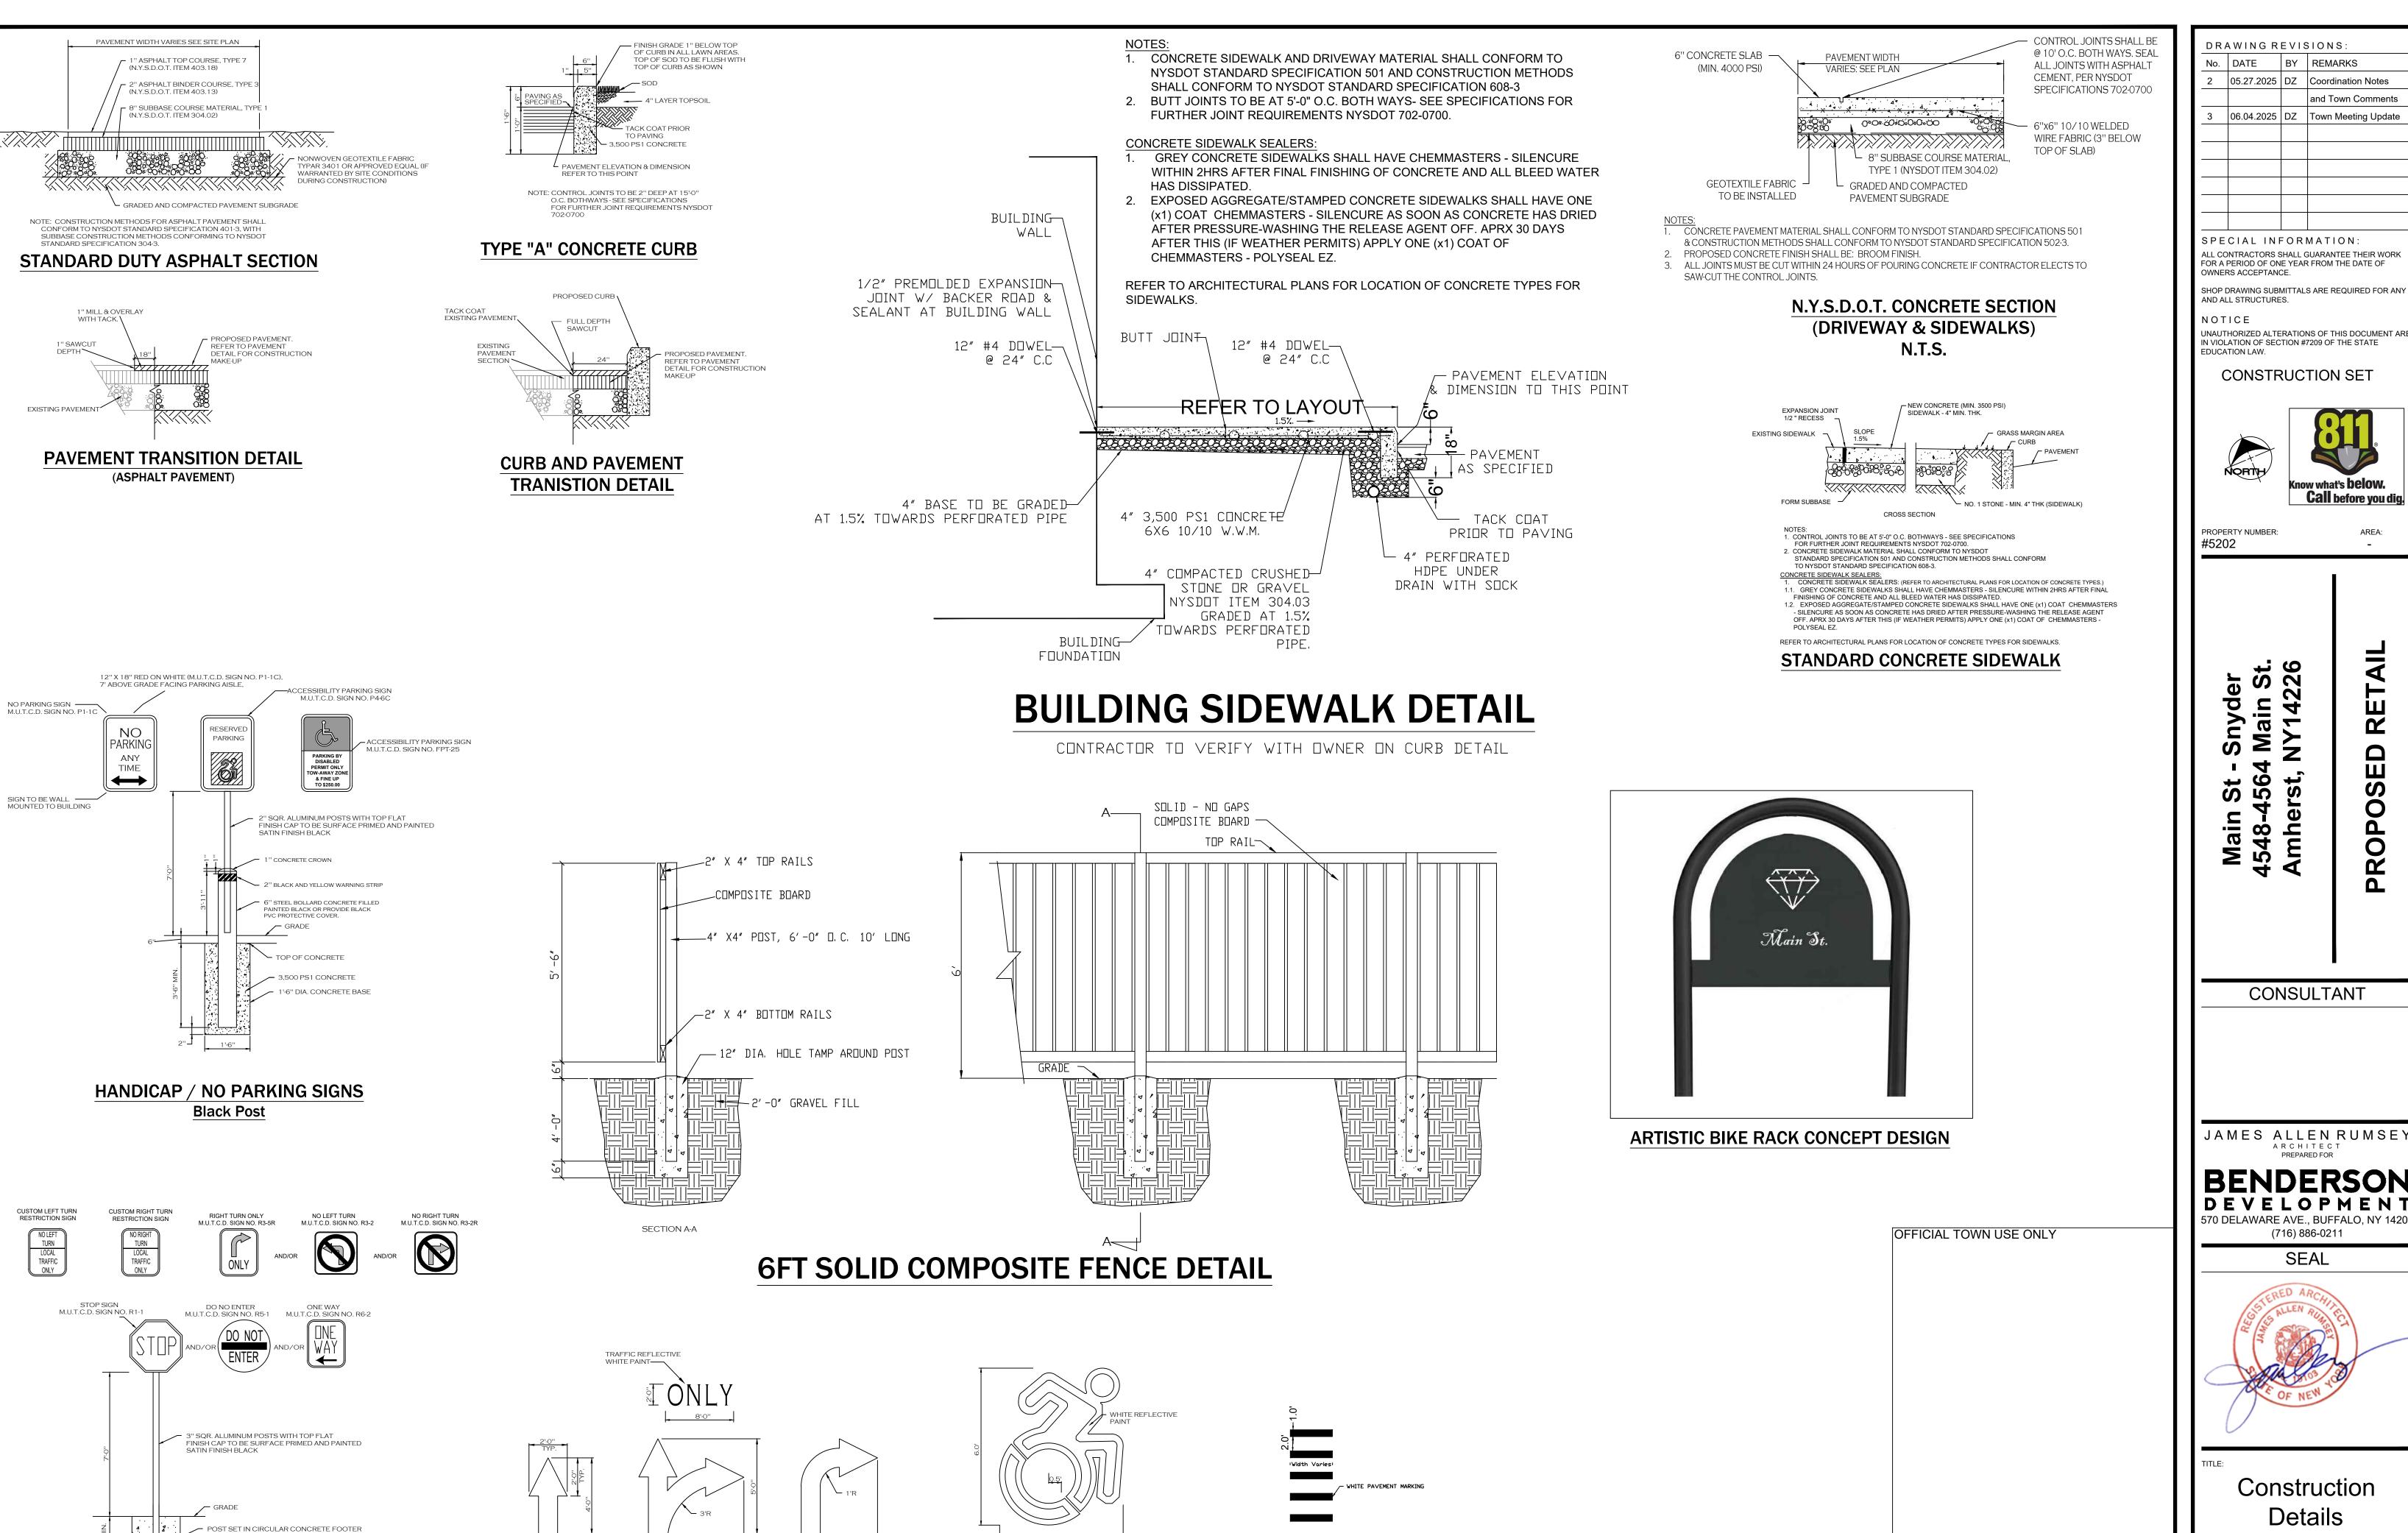

INTERNATIONAL ACCESSIBILITY

SYMBOL

PAINTED TRAFFIC ARROWS

"STOP" / "NO ENTRY" / "ONE WAY" SIGNS

Black Post and Footer

PEDESTRIAN CROSSWALK

DRAWING REVISIONS: No. DATE BY REMARKS 05.27.2025 DZ Coordination Notes and Town Comments 06.04.2025 DZ Town Meeting Update

> SPECIAL INFORMATION ALL CONTRACTORS SHALL GUARANTEE THEIR WORK FOR A PERIOD OF ONE YEAR FROM THE DATE OF OWNERS ACCEPTANCE.

AND ALL STRUCTURES.

UNAUTHORIZED ALTERATIONS OF THIS DOCUMENT ARE IN VIOLATION OF SECTION #7209 OF THE STATE

CONSTRUCTION SET





PROPERTY NUMBER:

AREA:

Snyder Main St NY1422(

S


0

0

CONSULTANT

JAMES ALLEN RUMSEY ARCHITECT


(716) 886-0211

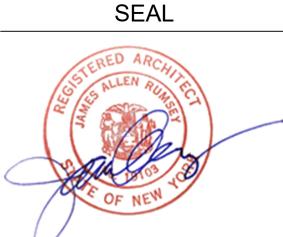

Construction Details

DRAWN BY:

DRAWING NO. 04.16.2025

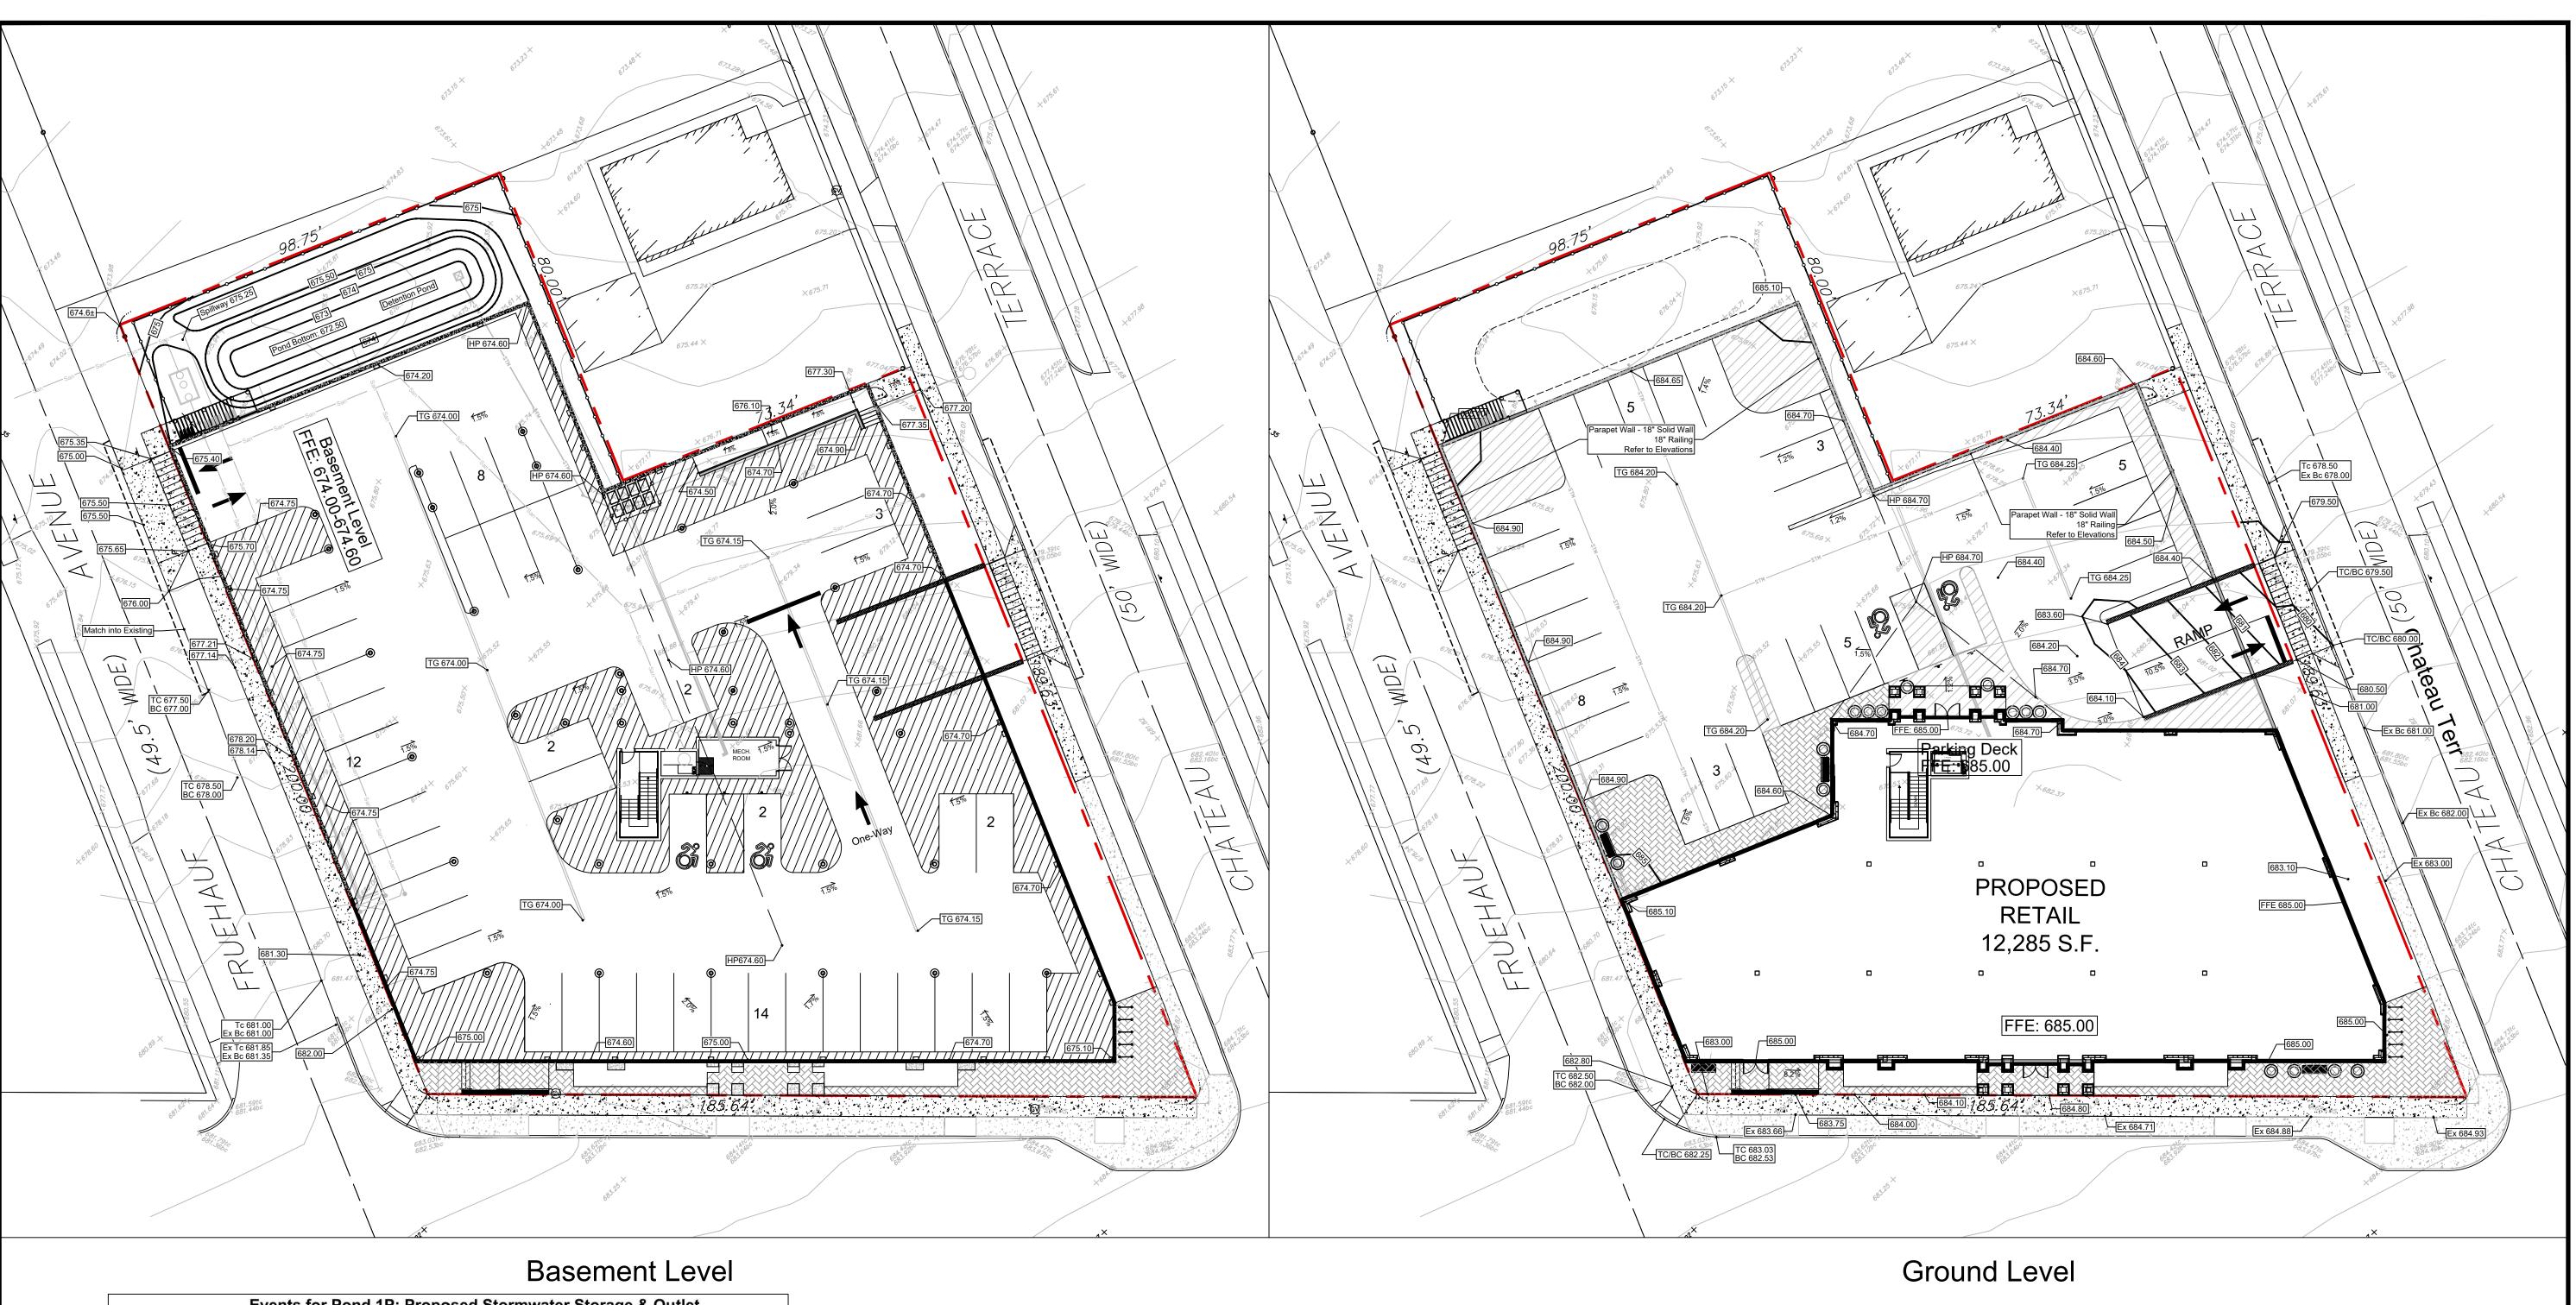

Fnd. Pipe

674.70

Basement

Pedestrian Ramp

Scale 1" = 10'

On Line & 0.6 W.

674.70


677.20

677.30

Events for Pond 1P: Proposed Stormwater Storage & Outlet							
Event	Inflow (cfs)	Outflow (cfs)	Primary (cfs)	Secondary (cfs)	Elevation (feet)	Storage (cubic-feet)	
1-Year	1.71	0.87	0.87	0.00	673.58	468	
2-Year	2.12	0.94	0.94	0.00	673.92	722	
5-Year	2.64	1.01	1.01	0.00	674.32	1,075	
10-Year	3.12	1.07	1.07	0.00	674.64	1,419	
25-Year	3.85	1.14	1.14	0.00	675.08	1,977	
50-Year	4.51	2.16	1.18	0.98	675.35	2,366	
100-Year	5.29	3.95	1.20	2.76	675.46	2,525	

- INSTALL ALL MATERIALS TO MANUFACTURER'S RECOMMENDATIONS AND BEST STANDARDS OF TRADE INVOLVED.
- SUBSTITUTIONS SHALL BE MADE ONLY WITH OWNER'S APPROVAL AND BE OF EQUIVALENT QUALITY TO WHAT IS SPECIFIED.
- WORK SHALL BE COMPLETED IN STRICT ACCORDANCE WITH ALL LOCAL CODES AND OSHA SAFETY RULES AND REGULATIONS. . CONTRACTOR SHALL VERIFY ALL EXISTING CONDITIONS AND DIMENSIONS AT THE SITE. NOTIFY OWNER & ENGINEER OF DISCREPANCIES IN
- CONDITIONS SHOWN ON DRAWINGS PRIOR TO PROCEEDING WITH THE WORK. CONTRACTOR SHALL BE RESPONSIBLE FOR PROTECTION OF ANY EXISTING STRUCTURES TO REMAIN AND ANY FINISH MATERIAL INSTALLED WHILE
- WORKING ON OTHER COMPONENTS. 6. CONTRACTOR SHALL KEEP JOB FREE OF DEBRIS AND MAKE FINAL CLEANUP TO THE SATISFACTION OF OWNER.
- CONTRACTOR SHALL ASCERTAIN THE LOCATION OF ALL UTILITIES PRIOR TO CONSTRUCTION SO THAT THIS WORK WILL NOT DISTURB EXISTING
- LINES AND/OR INSTALLATIONS EXCEPT AS DETAILED ON THE PLANS. COORDINATE ALL WORK WITH THE APPLICABLE UTILITY COMPANIES. 3. $\,$ CONTRACTOR SHALL OBTAIN AND PAY FOR ALL REQUIRED PERMITS NECESSARY TO PERFORM THE WORK.
- 9. BUILDING DIMENSIONS ARE APPROXIMATE. REFER TO ARCHITECTURAL DRAWINGS FOR LAYOUT DIMENSIONS. ${\sf I0.}$ ${\sf SIDEWALK}$ DIMENSIONS ARE APPROXIMATE. REFER TO ARCHITECTURAL DRAWINGS FOR THE SIDEWALK PLAN .
- 1. CONCRETE SIDEWALK SEALERS: (REFER TO ARCHITECTURAL PLANS FOR LOCATION OF CONCRETE TYPES.)
- 11.1. GREY CONCRETE SIDEWALKS SHALL HAVE CHEMMASTERS SILENCURE WITHIN 2HRS AFTER FINAL FINISHING OF CONCRETE AND ALL BLEED WATER HAS DISSIPATED.
- 11.2. EXPOSED AGGREGATE/STAMPED CONCRETE SIDEWALKS SHALL HAVE ONE (x1) COAT CHEMMASTERS SILENCURE AS SOON AS CONCRETE HAS DRIED AFTER PRESSURE-WASHING THE RELEASE AGENT OFF. APRX 30 DAYS AFTER THIS (IF WEATHER PERMITS) APPLY ONE (x1) COAT OF CHEMMASTERS - POLYSEAL EZ.
- 12. LIGHTING FIXTURE ARROW SYMBOLS REFER TO THE DIRECTION THAT THE FIXTURES ARE REQUIRED TO
- FACE. SPECIFIC MOUNT BRACKETS WILL BE REQUIRED DEPENDING ON ORIENTATION AND FIXTURE COUNT. 13. CURB ISLAND DIMENSIONS ARE FROM INSIDE OF CURB TO INSIDE OF CURB.

14. CONTRACTOR TO PROVIDE NEW PAVEMENT THAT CONFORMS TO THE GRADING PLAN WHILE MAINTAINING, AS A MINIMUM, THE EXISTING STONE BASE. THE MEANS AND METHODS OF OBTAINING NEW GRADES IS LEFT UP TO THE CONTRACTOR AND CAN BE OBTAINED VIA SHIMMING THE PAVEMENT AND THEN A NEW TOP COAT, REMOVING EXISTING ASPHALT PAVEMENT AND REGRADING EXISTING STONE BASE, A COMBINATION OF THESE TWO OR ANOTHER METHOD OF THE CONTRACTORS CHOOSING. FINAL PAVEMENT WORK PLAN SHALL BE PROVIDED TO OWNER AND ENGINEER FOR REVIEW AND APPROVAL

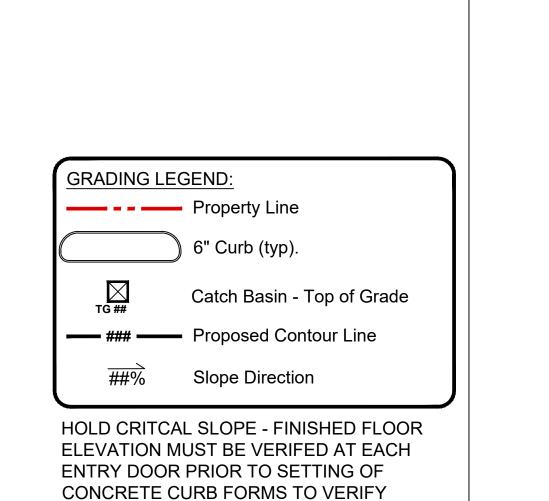

THAT SIDEWALK SLOPE DOES NOT

EXCEED 1.5%.

OFFICIAL TOWN USE ONLY

DRAWING REVISIONS: DATE BY REMARKS 04.29.2025 DZ Arch Updates 05.27.2025 DZ Coordination Notes and Town Comments 06.04.2025 DZ Town Meeting Update 07.14.2025 DZ Site Updates

SPECIAL INFORMATION: ALL CONTRACTORS SHALL GUARANTEE THEIR WORK FOR A PERIOD OF ONE YEAR FROM THE DATE OF OWNERS ACCEPTANCE.

SHOP DRAWING SUBMITTALS ARE REQUIRED FOR ANY AND ALL STRUCTURES.

UNAUTHORIZED ALTERATIONS OF THIS DOCUMENT ARE IN VIOLATION OF SECTION #7209 OF THE STATE

CONSTRUCTION SET



(now what's **below.**


PROPERTY NUMBER:

CONSULTANT

JAMES ALLEN RUMSEY

570 DELAWARE AVE., BUFFALO, NY 14202

(716) 886-0211

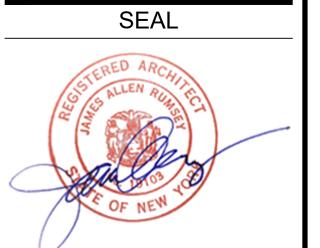



Grading Plan

1" = 20' DRAWING NO. DRAWN BY: DMZ

MAO

DATE: 04.16.2025

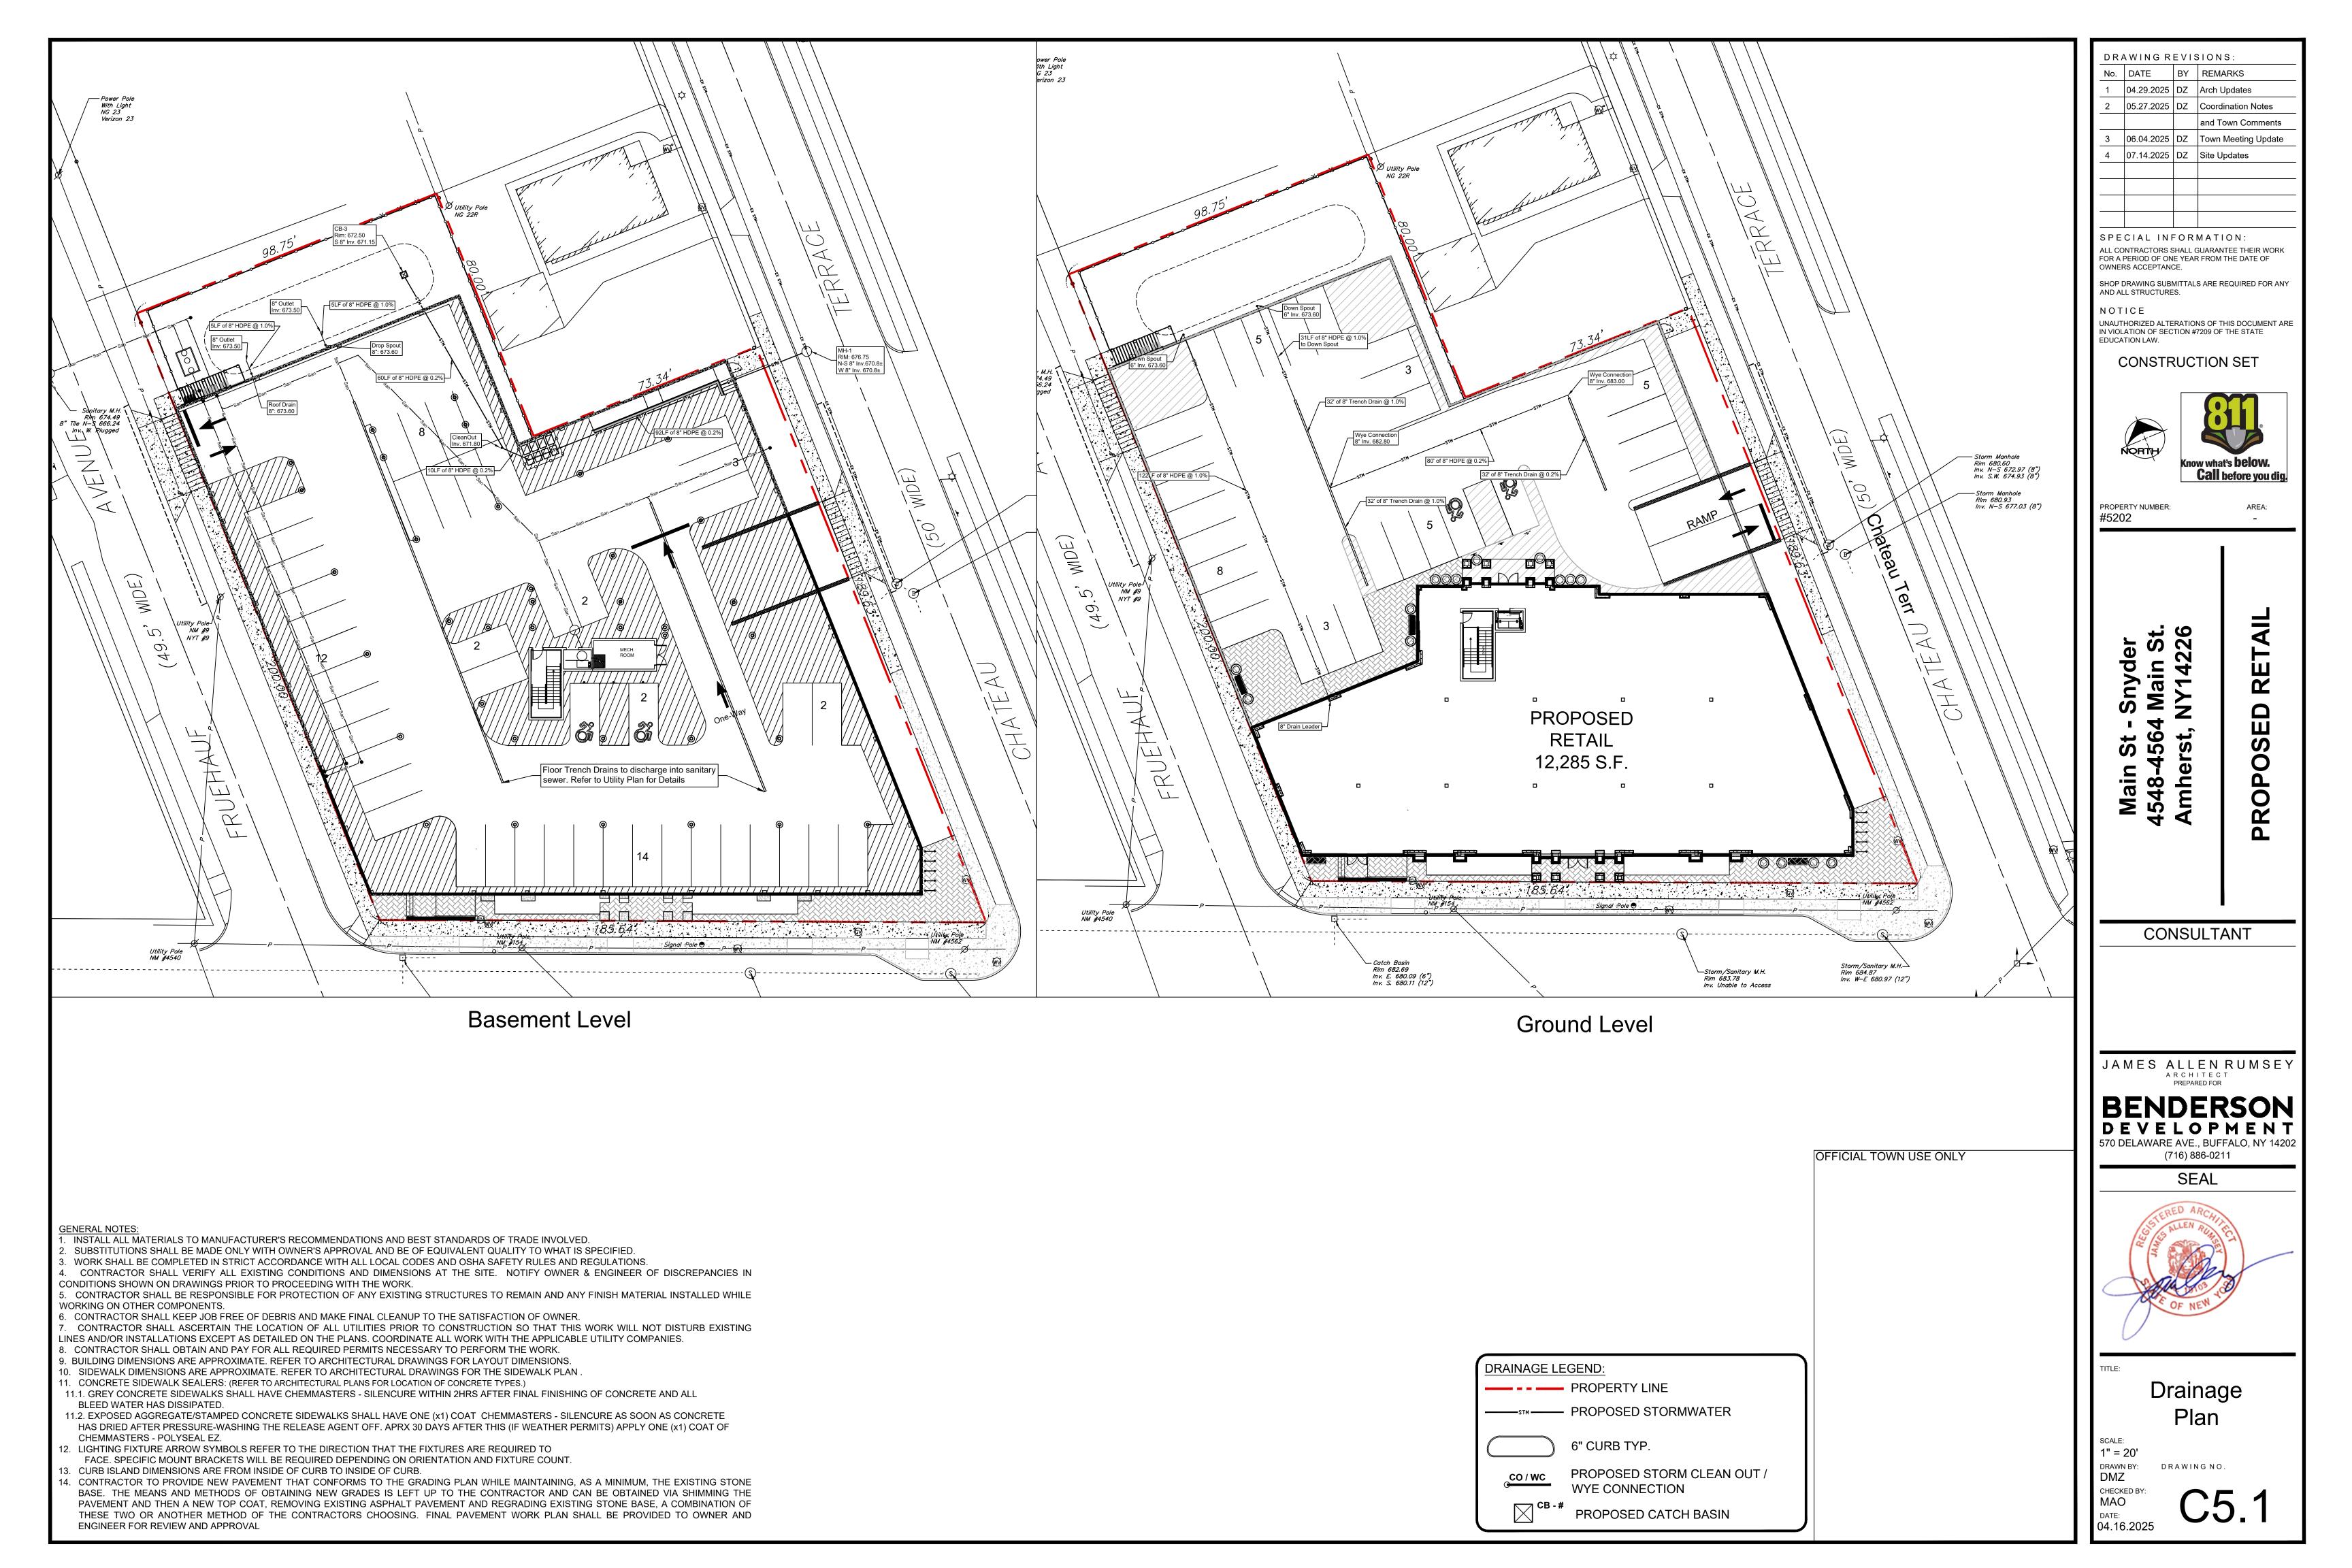

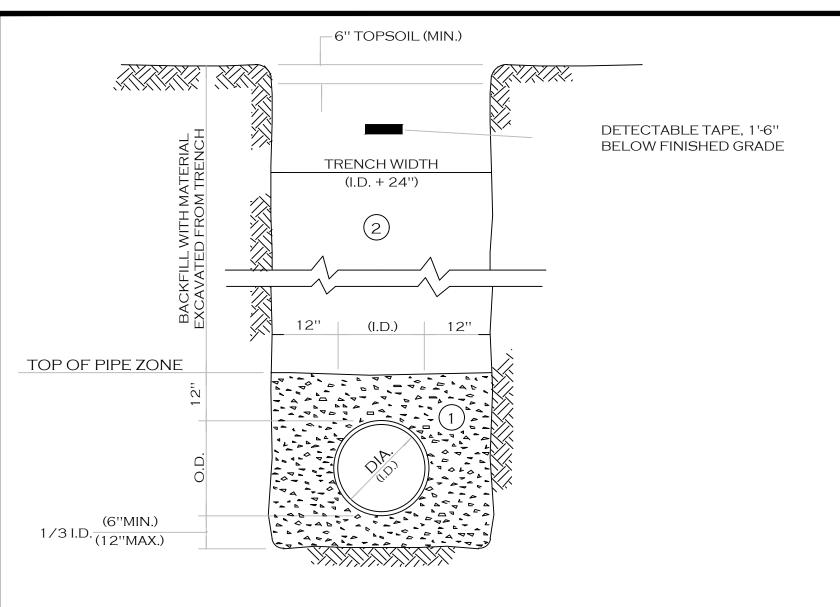

- A. PIPE INSTALLATION SHALL BE IN ACCORDANCE WITH MANUFACTURERS RECOMMENDATIONS.
- B. TRENCHING OPERATIONS SHALL INCLUDE ALL NECESSARY DEWATERING.
- C. TRENCH DETAILS ARE ONLY SHOWN FOR PURPOSES OF MATERIAL PLACEMENT AND MAXIMUM PAY LIMITS.
- D. AN OSHA APPROVED MOVABLE PROTECTIVE TRENCH SHIELD SHALL BE USED IN ALL UNSHEETED TRENCH AREAS.

MATERIALS


PIPE BEDDING MATERIAL (NYSDOT 1985 EDITION)

NO. 1 CRUSHED STONE OR CRUSHED GRAVEL WITH A GRADATION CONFORMING WITH NYSDOT SECTION 703-02. THE MATERIAL SHALL BE WELL GRADED WITH NO PARTICLES LARGER THAN ONE INCH AND HAVING A MAXIMUM GRADATION MEETING THE LIMITS DESCRIBED IN THE SPECIFICATIONS. THE BEDDING SHALL BE COMPACTED IN 6" LIFTS WITH EQUIPMENT ACCEPTABLE TO THE PIPE MANUFACTURER.


NO SLAG SHALL BE ALLOWED FOR MATERIAL (1)

2 BACKFILL MALL..... COMPACTED IN 6" LIFTS. BACKFILL MATERIAL SHALL BE NATIVE SOIL CONTAINING NO UNSUITABLE MATERIAL


TRENCH SECTION IN UNPAVED AREAS

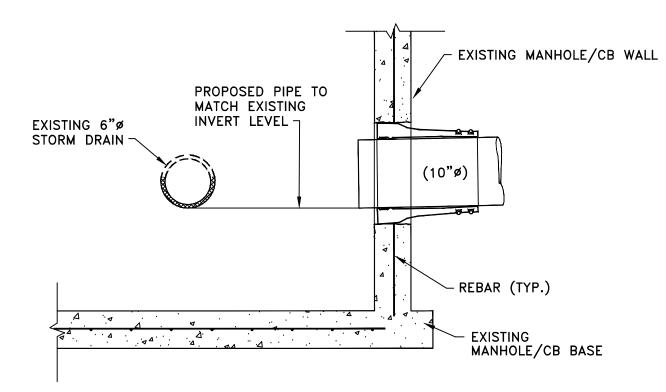

- 1. CORE DRILL ENTRANCE HOLE IN PRECAST MANHOLE BARREL, BASE AND/OR BENCH FOR REQUIRED PIPE CLEARANCE. PER MANUFACTURERS RECOMMENDATIONS.
- 2. DOES NOT APPLY TO HOUSE LATERALS.
- 3. WATERTIGHT PIPE TO MANHOLE BOOT SEAL REQUIRED FOR ALL CORE DRILLED ENTRANCE HOLES IN MANHOLE BARREL AS SHOWN BELOW.

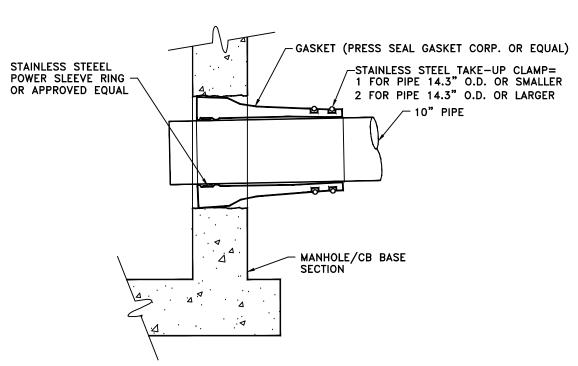

CONNECTION TO EXISTING MANHOLE/CB

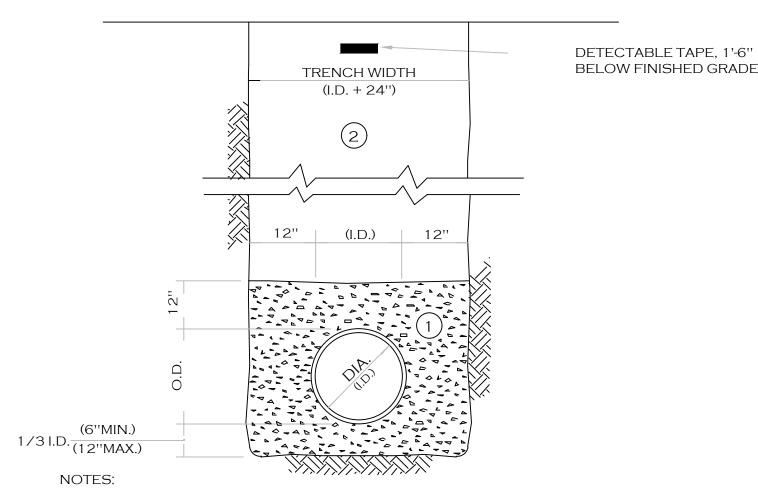

A. PIPE INSTALLATION SHALL BE IN ACCORDANCE WITH MANUFACTURERS RECOMMENDATIONS.

B. TRENCHING OPERATIONS SHALL INCLUDE ALL NECESSARY DEWATERING.

- C. TRENCH DETAILS ARE ONLY SHOWN FOR PURPOSES OF MATERIAL PLACEMENT AND MAXIMUM PAY LIMITS.
- D. AN OSHA APPROVED MOVABLE PROTECTIVE TRENCH SHIELD SHALL BE USED IN ALL UNSHEETED TRENCH AREAS.

MATERIALS

PIPE BEDDING MATERIAL (NYSDOT 1985 EDITION)


NO. 1 CRUSHED STONE OR CRUSHED GRAVEL WITH A GRADATION CONFORMING WITH NYSDOT SECTION 703-02. THE MATERIAL SHALL BE WELL GRADED WITH NO PARTICLES LARGER THAN ONE INCH AND HAVING A MAXIMUM GRADATION MEETING THE LIMITS DESCRIBED IN THE SPECIFICATIONS. THE BEDDING SHALL BE COMPACTED IN 6" LIFTS WITH EQUIPMENT ACCEPTABLE TO THE PIPE MANUFACTURER.


NO SLAG SHALL BE ALLOWED FOR MATERIAL (1)

TYPE 2 CRUSHED STONE OR CRUSHED GRAVEL WITH A GRADATION CONFORMING WITH NYSDOT SECTION 304-2.02 TYPE 2. THE MATERAIL SHALL BE WELL GRADED WITH NO PARTICLES LARGER THAN TWO INCHES AND HAVING A MAXIMUM GRADATION MEETING THE LIMITS DESCRIBED IN THE SPECIFICATIONS. THE BEDDING SHALL BE COMPACTED IN 6" LIFTS WITH EQUIPMENT ACCEPTABLE TO THE PIPE MANUFACTURER.

NO SLAG SHALL BE ALLOWED FOR MATERIAL (2)

TRENCH SECTION IN PAVED AREAS

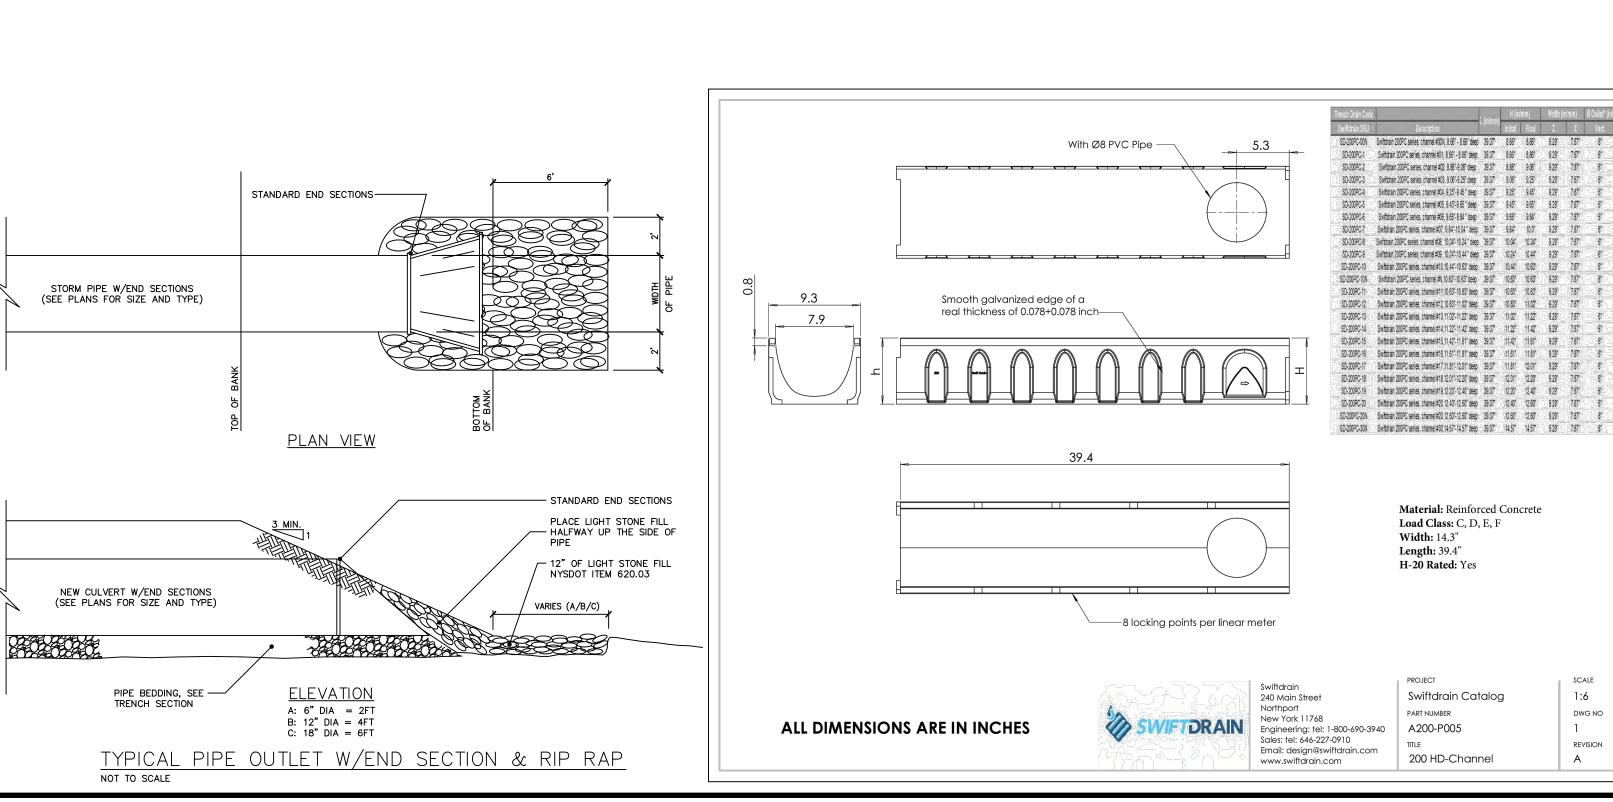

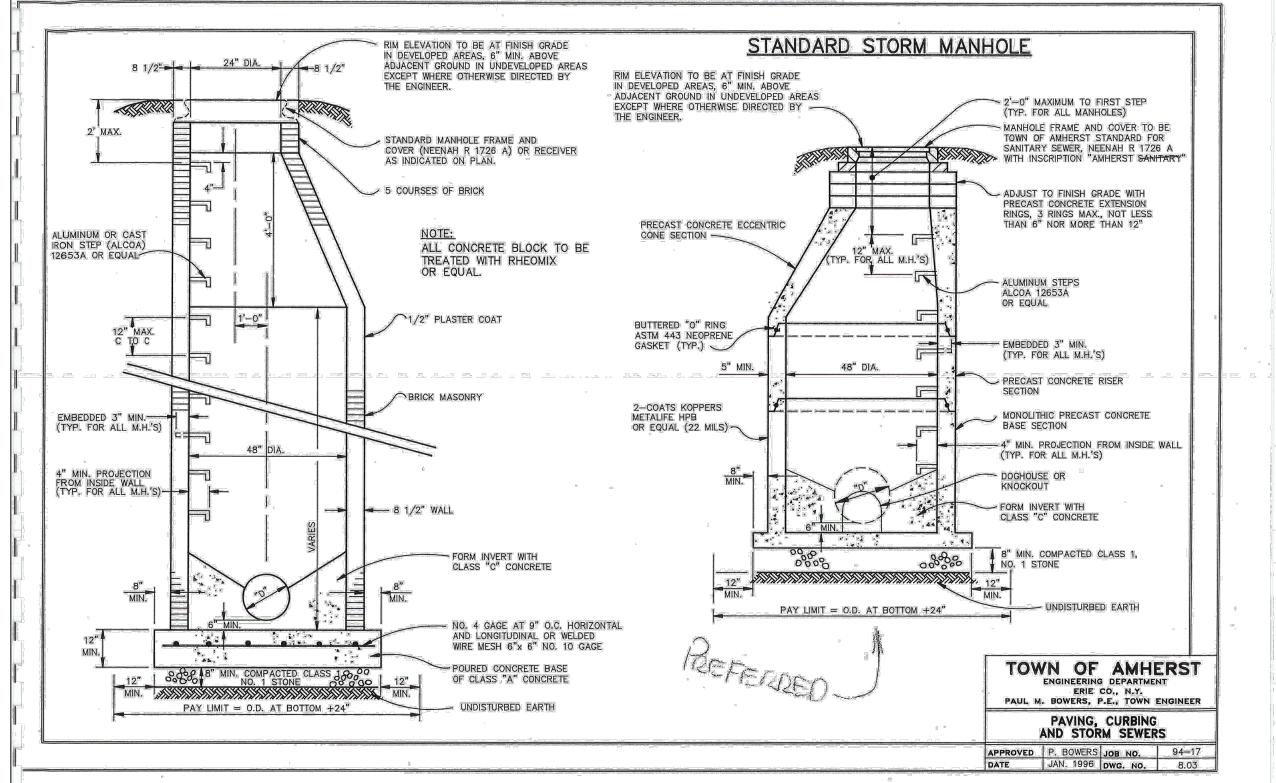

DRAWING REVISIONS: No. DATE BY REMARKS SPECIAL INFORMATION:

ALL CONTRACTORS SHALL GUARANTEE THEIR WORK FOR A PERIOD OF ONE YEAR FROM THE DATE OF OWNERS ACCEPTANCE. SHOP DRAWING SUBMITTALS ARE REQUIRED FOR ANY

AND ALL STRUCTURES.

UNAUTHORIZED ALTERATIONS OF THIS DOCUMENT ARE IN VIOLATION OF SECTION #7209 OF THE STATE

CONSTRUCTION SET



Know what's **below.** Call before you dig.

AREA:

Δ.

PROPERTY NUMBER: #5202


inyder Main St Main (

CONSULTANT

JAMES ALLEN RUMSEY ARCHITECT

570 DELAWARE AVE., BUFFALO, NY 14202 (716) 886-0211

SEAL

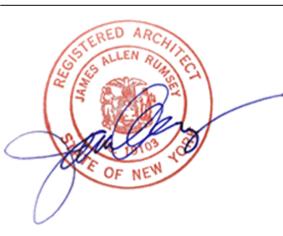


OFFICIAL TOWN USE ONLY


Drainage **Details**

NTS DRAWING NO. DRAWN BY: DMZ CHECKED BY MAO

DATE:

04.16.2025

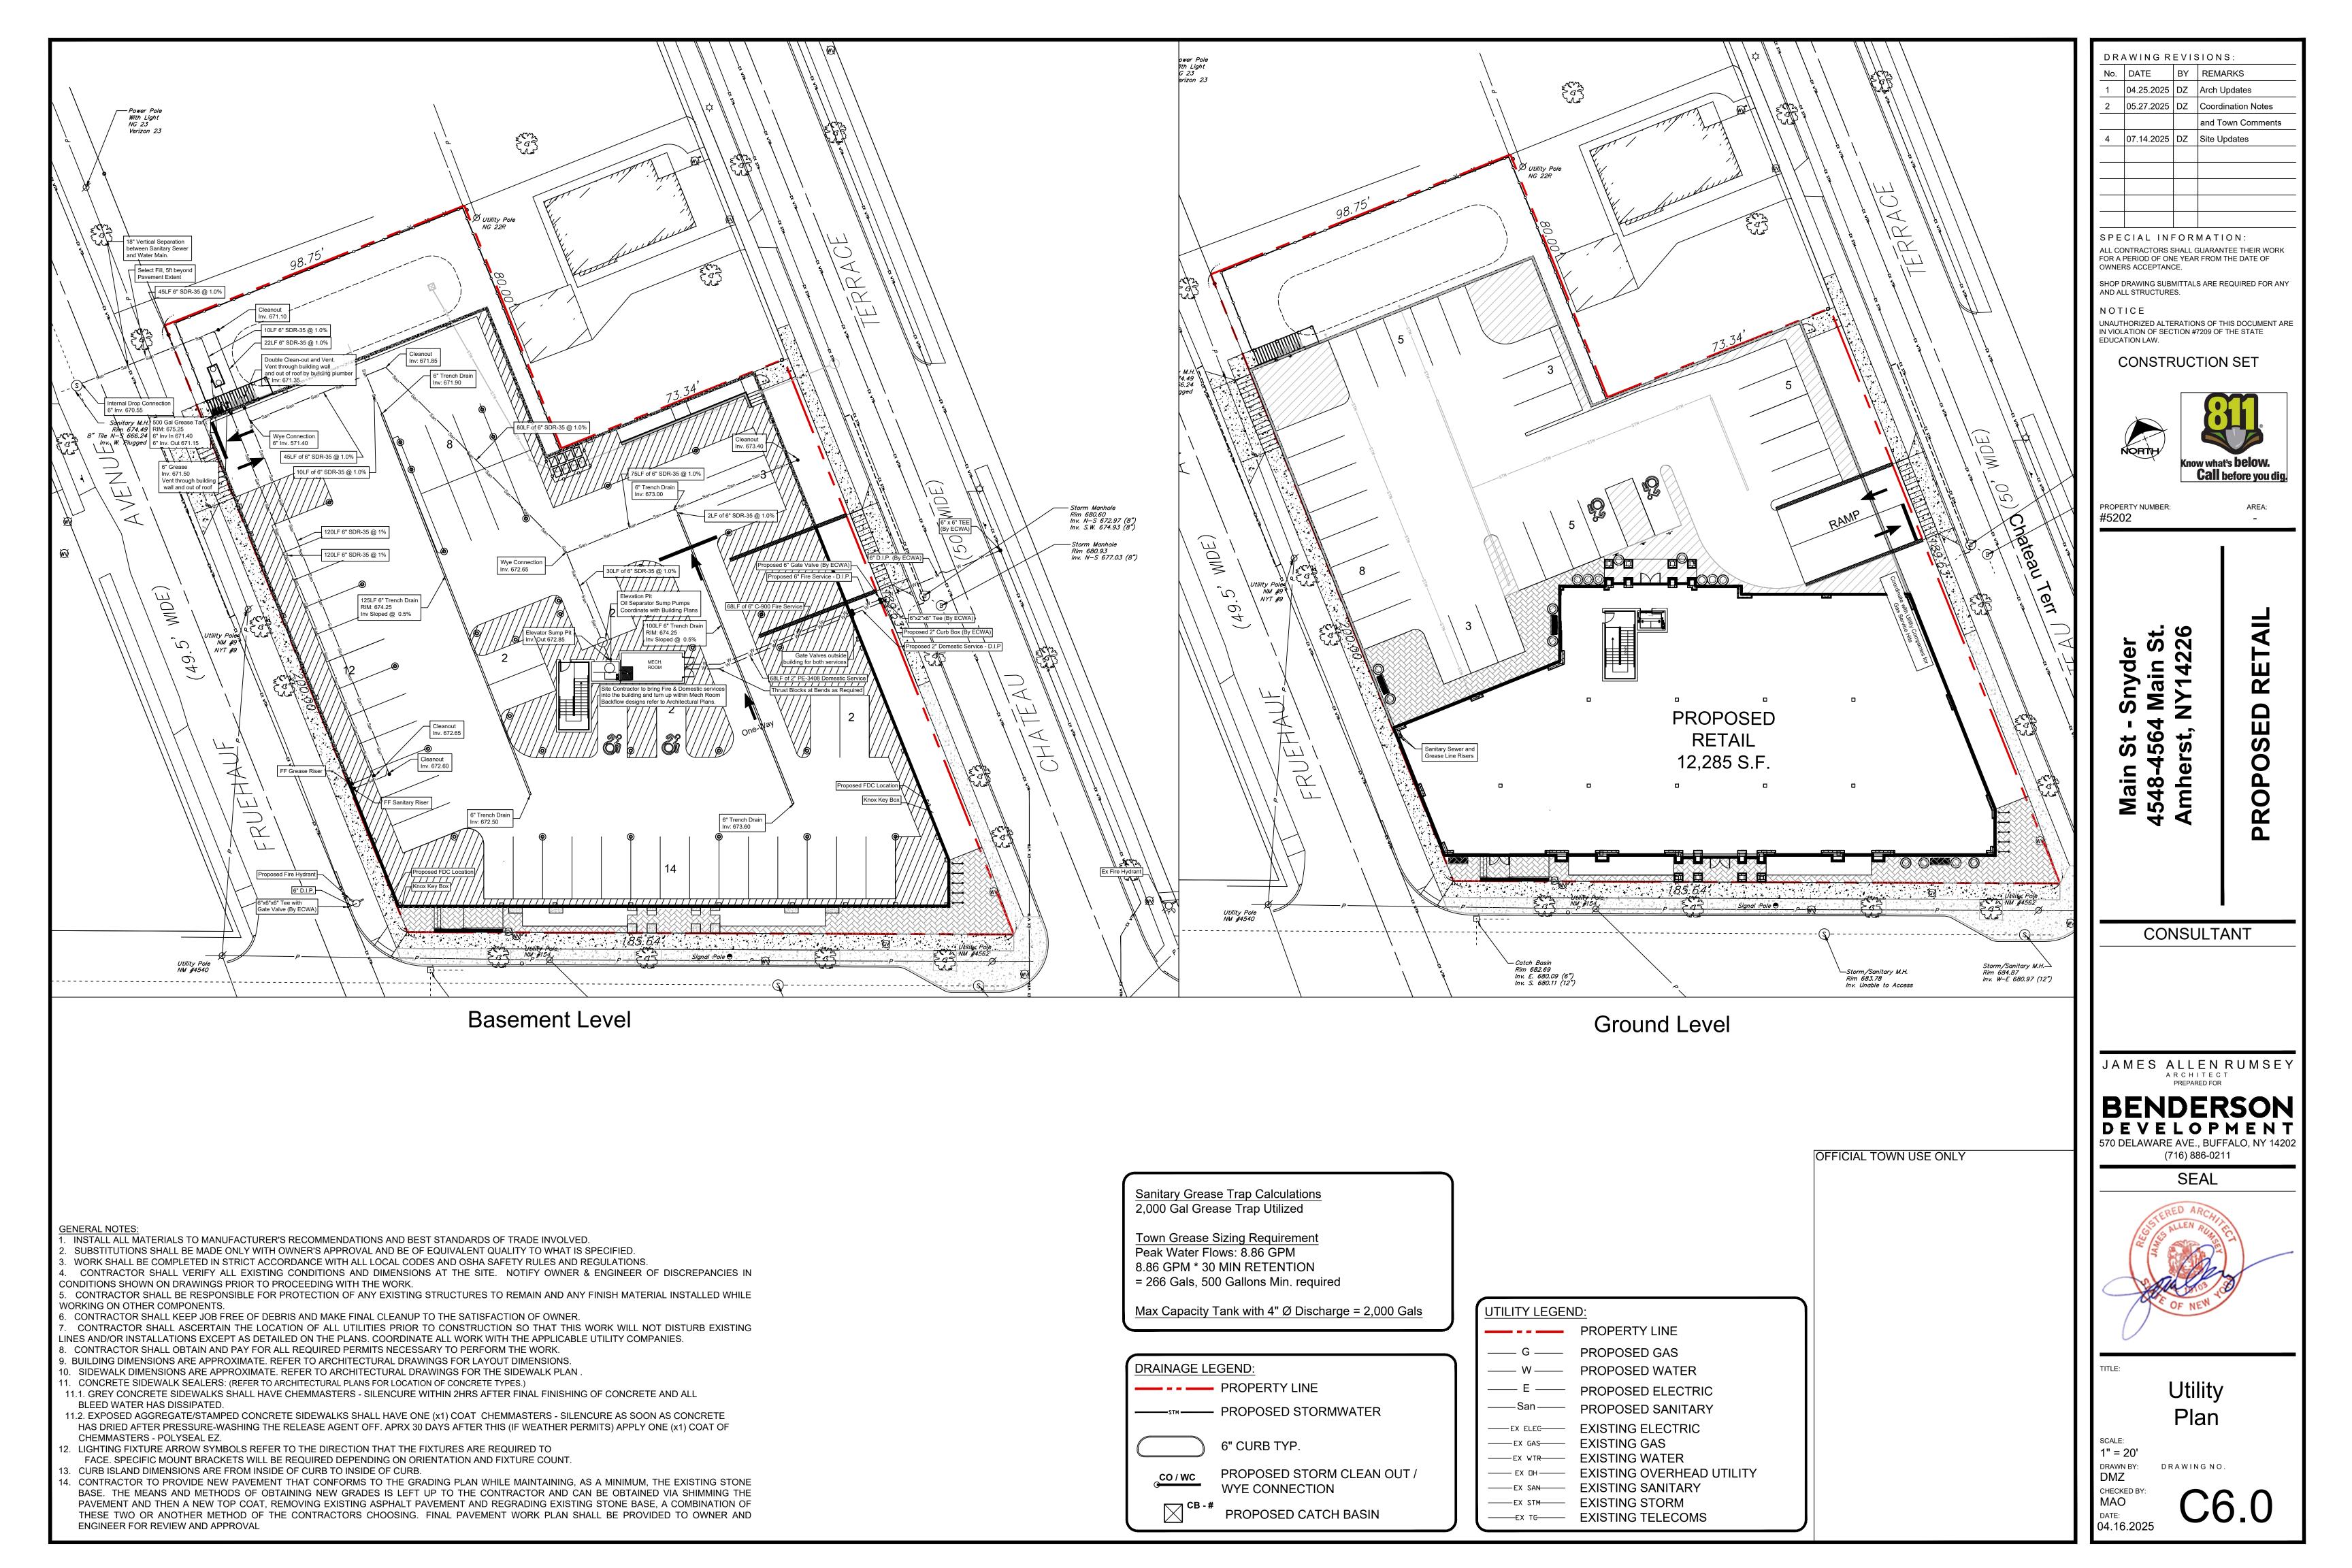

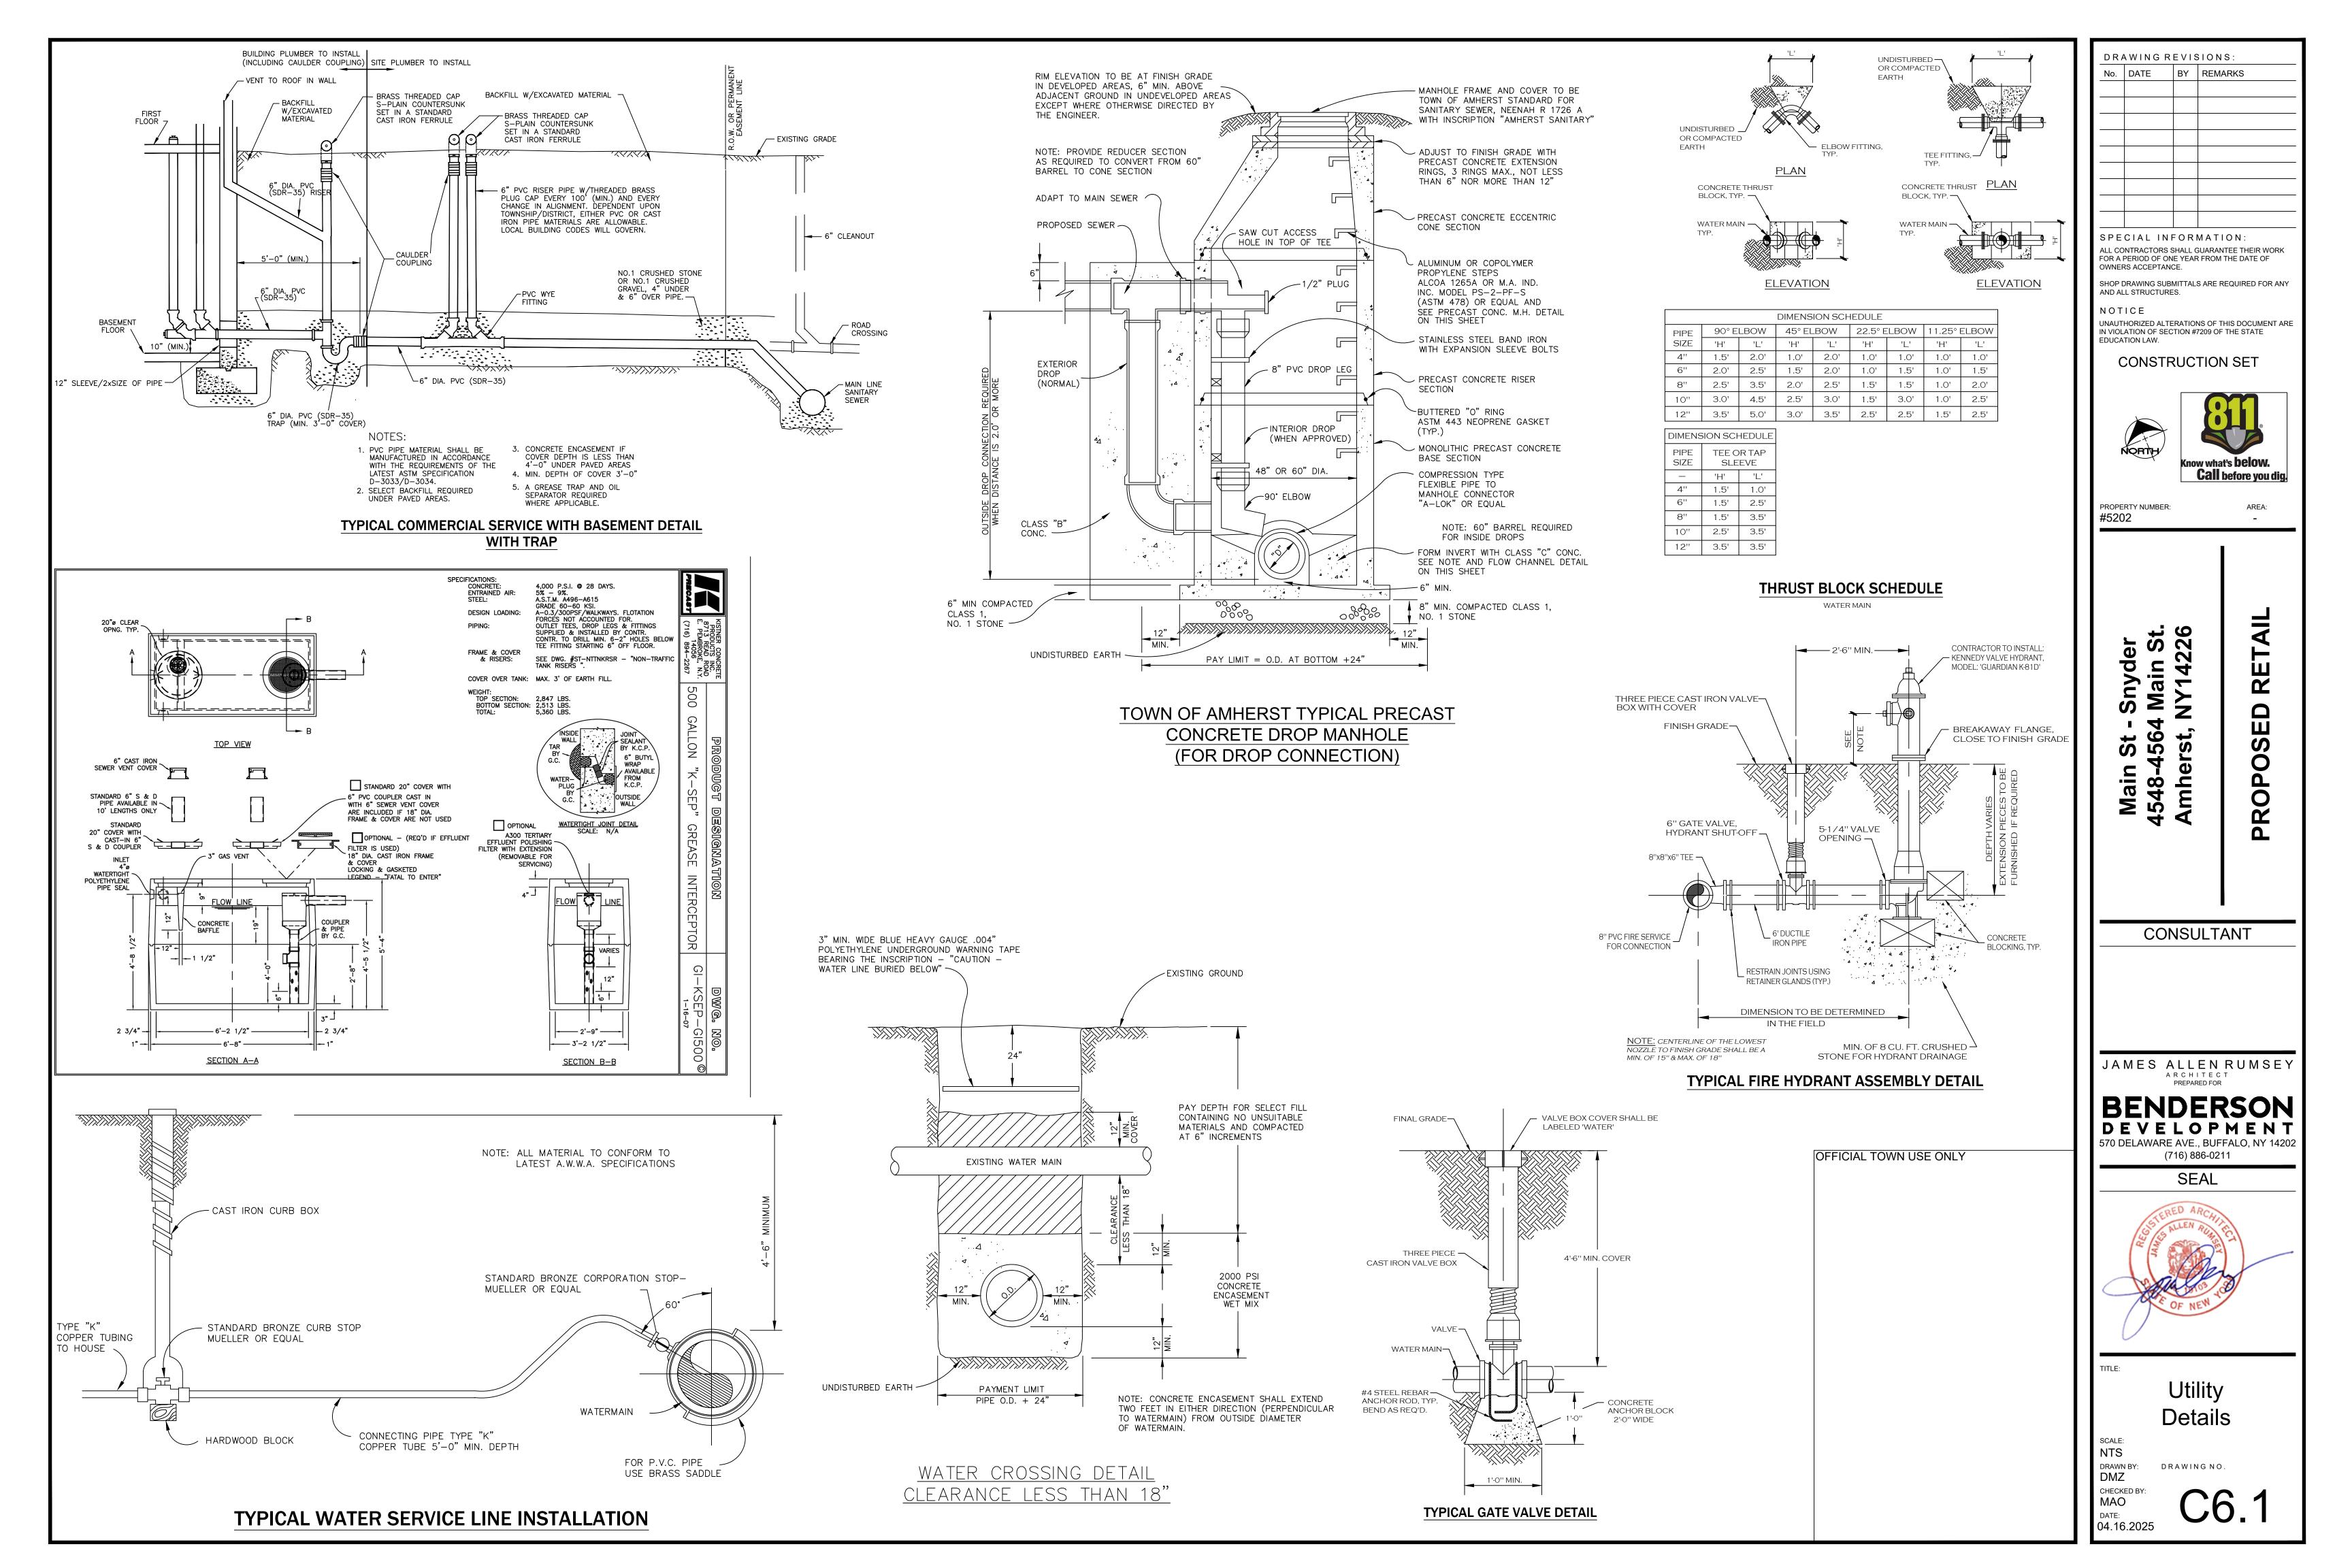


LANDSCAPE NOTES

- 1. LANDSCAPE CONTRACTOR SHALL SECURE CURRENT PLANS AND SPECIFICATIONS FOR PROPER CONSTRUCTION METHODS AND MATERIAL OF ALL LANDSCAPING PRIOR TO COMMENCING WORK.
- 2. ALL PLANTS SHALL MEET OR EXCEED THE MINIMUM REQUIREMENTS AS NOTED IN THE LATEST EDITION OF THE AMERICAN STANDARD FOR NURSERY STOCK, BY THE AMERICAN ASSOCIATION OF NURSERYMEN, ANSI Z60.1 (LATEST
- 3. THE CONTRACTOR SHALL BE RESPONSIBLE FOR HIS OWN QUANTITY TAKEOFF.

AREAS UNTIL THE WORK IS ACCEPTED IN TOTAL BY THE OWNER.

- 4. THE CONTRACTOR SHALL PERFORM A ROUGH FIELD STAKEOUT OF ALL PLANT MATERIAL AND SHRUB-BEDS. CONTACT OWNER'S REPRESENTATIVE FOR INSPECTION AND APPROVAL. LOCATIONS SHOWN ON THE PLANS CONVEY DESIGN INTENT ONLY. ACTUAL LOCATIONS WILL BE AS DIRECTED BY THE LANDSCAPE ARCHITECT AT THE TIME OF
- 5. THE CONTRACTOR IS HEREBY NOTIFIED THAT UNDERGROUND UTILITIES EXIST. SHOULD LOCATION OF TREES BE WITHIN 5' OF UNDERGROUND UTILITIES, RELOCATE SAID TREES TO A MINIMUM OF 5' FROM BALL TO UTILITIES.
- 6. SHOULD LOCATION OF TREES BE WITHIN 20' OF OVERHEAD WIRES, RELOCATE SAID TREES TO A MINIMUM OF 20'
- 7. ALL TREES AND SHRUBS SHALL RECEIVE A 3" LAYER OF BLACK SHREDDED HARDWOOD BARK MULCH.
- 8. ALL PLANTS MUST BE HARDY UNDER CLIMATE CONDITIONS THAT EXIST AT THE PROJECT SITE AND GROWN AT A NURSERY AT THE SAME HARDINESS ZONE AS THE PROJECT LOCATION.
- 9. NO SUBSTITUTIONS SHALL BE PERMITTED WITHOUT PRIOR WRITTEN APPROVAL OF THE OWNER OR OWNER'S PROJECT
- 10. ANY PLANT WHICH DIES, TURNS BROWN, OR DEFOLIATES (PRIOR TO TOTAL ACCEPTANCE OF THE WORK) SHALL BE PROMPTLY REMOVED FROM THE SITE AND REPLACED WITH MATERIAL OF THE SAME SPECIES, QUANTITY, AND SIZE MEETING ALL PLANT LIST SPECIFICATIONS.
- 11. THE CONTRACTOR IS RESPONSIBLE FOR FULLY MAINTAINING ALL PLANT MATERIALS (INCLUDING, BUT NOT LIMITED TO WATERING, SPRAYING, MULCHING, FERTILIZING, AND REMOVAL OF STAKES AND GUYS) AND NEWLY ESTABLISHED LAWN
- 12. ALL AREAS DISTURBED BY UTILITY INSTALLATION AND SITE GRADING ACTIVITY SHALL RECEIVE 6" APPROVED TOPSOIL (TO A COMPACTED DEPTH OF 6", UNLESS OTHERWISE SPECIFIED BY THE GOVERNING MUNICIPALITY) BE FINE GRADES, SEEDED, MULCHED, AND WATERED UNTIL A HEALTHY STAND OF GRASS IS OBTAINED.
- 13. ANY IRRIGATION COMPONENT DAMAGED DURING SITE OR LANDSCAPE RENOVATIONS MUST BE REPAIRED OR
- REPLACED TO THE SATISFACTION OF THE OWNER. 14. A ONE YEAR GUARANTEE SHALL BE PROVIDED ON ALL PLANT MATERIALS FROM THE DATE OF PROVISIONAL
- ACCEPTANCE.
- 15. PLANTING BACKFILL MIXTURE SHALL CONSIST OF 3 PARTS TOPSOIL AND 1 PART COMPOST THOROUGHLY MIXED. PLANTING SOIL DEPTH SHALL BE 3' MINIMUM, AND BE FREE FROM CONSTRUCTION DEBRIS AND FOREIGN MATERIALS.
- 16. STAKE TREES IMMEDIATELY AFTER PLANTING.
- 17. LOCATIONS OF EXISTING BURIED UTILITIES SHOWN ON THE PLANS ARE BASED UPON BEST AVAILABLE INFORMATION AND ARE TO BE CONSIDERED APPROXIMATE. IT IS THE RESPONSIBILITY OF THE CONTRACTOR TO VERIFY THE LOCATIONS OF ALL UNDERGROUND UTILITIES WITHIN AND ADJACENT TO THE WORK AREA. IF ANY TREE IS LOCATED CLOSER THAN 5' TO AN UNDERGROUND UTILITY, IT SHALL BE RELOCATED TO A LOCATION THAT IS A MINIMUM OF 5'
 AWAY AS MEASURED FROM THE ROOTBALL. THE CONTRACTOR SHALL BE RESPONSIBLE FOR REPAIRING ANY AND ALL DAMAGE TO UTILITIES, STRUCTURES, AND SITE APPURTENANCES, ETC., WHICH OCCURS AS A RESULT OF THE

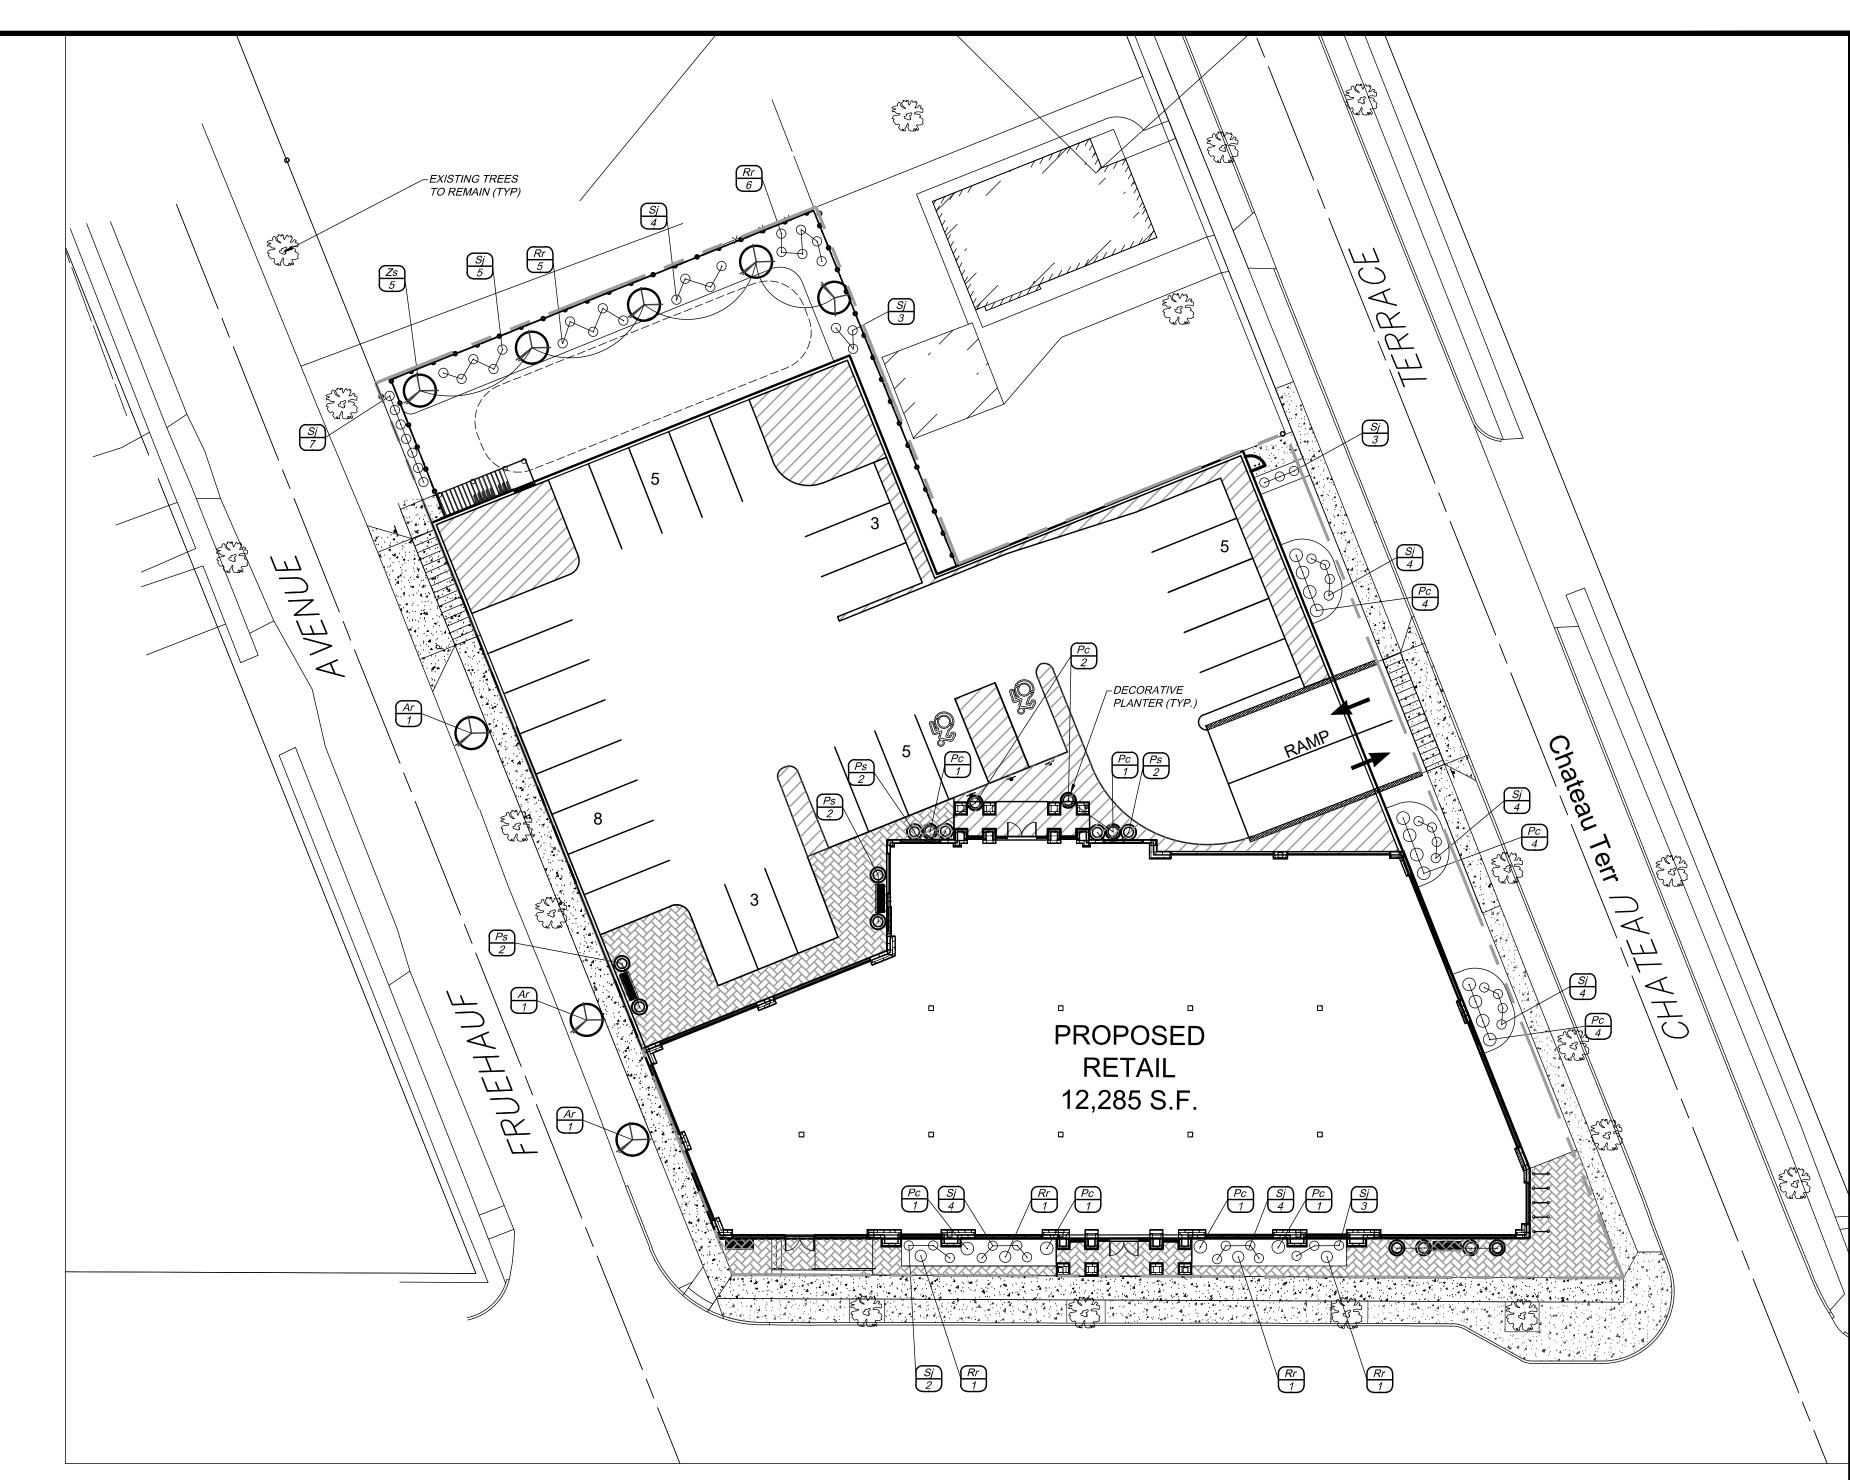

MEDIUM IMPACT LANDSCAPE SCREEN OPTION 1


PLANT TYPE	SPACING	DISTANCE	DISTANCE/SPACING	PLANT QUANTITY
LARGE DECIDUOUS TREES (Zs)	1/25 L.F.	112 Ft	112/25 = 4.48 (ROUND TO 5)	5
EVERGREEN & DECIDUOUS SHRUBS Sj	1/5 L.F.	112 Ft	112/5 = 22.4 (ROUND TO 23)	23

PLANT SCHEDULE

QTY	KEY	BOTANICAL NAME	COMMON NAME	SIZE	ROOT	MATURE SIZE			
ORNAI	DRNAMENTAL / DECIDUOUS TREES								
3	Ar	ACER X FREEMANII	ARMSTRONG MAPLE	2.5" CAL.	ВВ	HT. 40-55', SP. 30-40'			
5	Zs	ZELKOVA SERRATA 'MUSASHINO'	Musashino Zelkova	2.5" Cal	ВВ	HT. 40-45", SP. 10-15			
SHRUB	SHRUBS								
67	Sj	SPIREA JAPONICA 'GOLD MOUND'	GOLD MOUND SPIREA	3 GAL. (24" MIN.)	CONT.	HT. 2-3', SP. 4'			
11	Рс	PRUNUS X CISTENA	PURPLELEAF SAND CHERRY	3 GAL. (24" MIN.)	CONT.	HT. 3-4', SP. 4'			
8	Rr	ROSA 'RADRAZZ'	KNOCK OUT ROSES	3 GAL. (24 MIN")	CONT.	HT. 3-4', SP. 3-4'			
PEREN	PERENNIALS & GRASSES								
8	PS	PENNISETUM SETACEUM	FOUNTAIN GRASS	3 GAL. (24" MIN)	CONT.	HT. 3-5', SP. 2-			



OFFICIAL TOWN USE ONLY

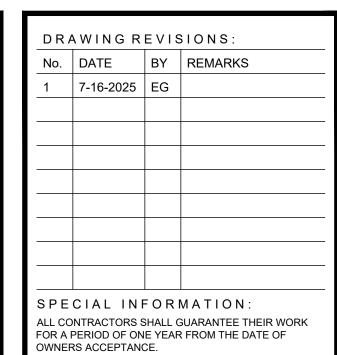

SHOP DRAWING SUBMITTALS ARE REQUIRED FOR ANY AND ALL STRUCTURES.

UNAUTHORIZED ALTERATIONS OF THIS DOCUMENT ARE IN VIOLATION OF SECTION #7209 OF THE STATE

CONSTRUCTION SET





M:\LOGOS-TIF\811Eng_ver_RGB.jpg

AREA:

0

CONSULTANT



SURVEYING • LANDSCAPE

• CIVIL ENGINEERING

COSTICH
217 LAKE AVENUE
ROCHESTER, NY 14608
(585) 458-3020


SEAL





Overall Landscaping Plan


DRAWING NO. DRAWN BY:

CHECKED BY: ERG DATE: 5/29/2025

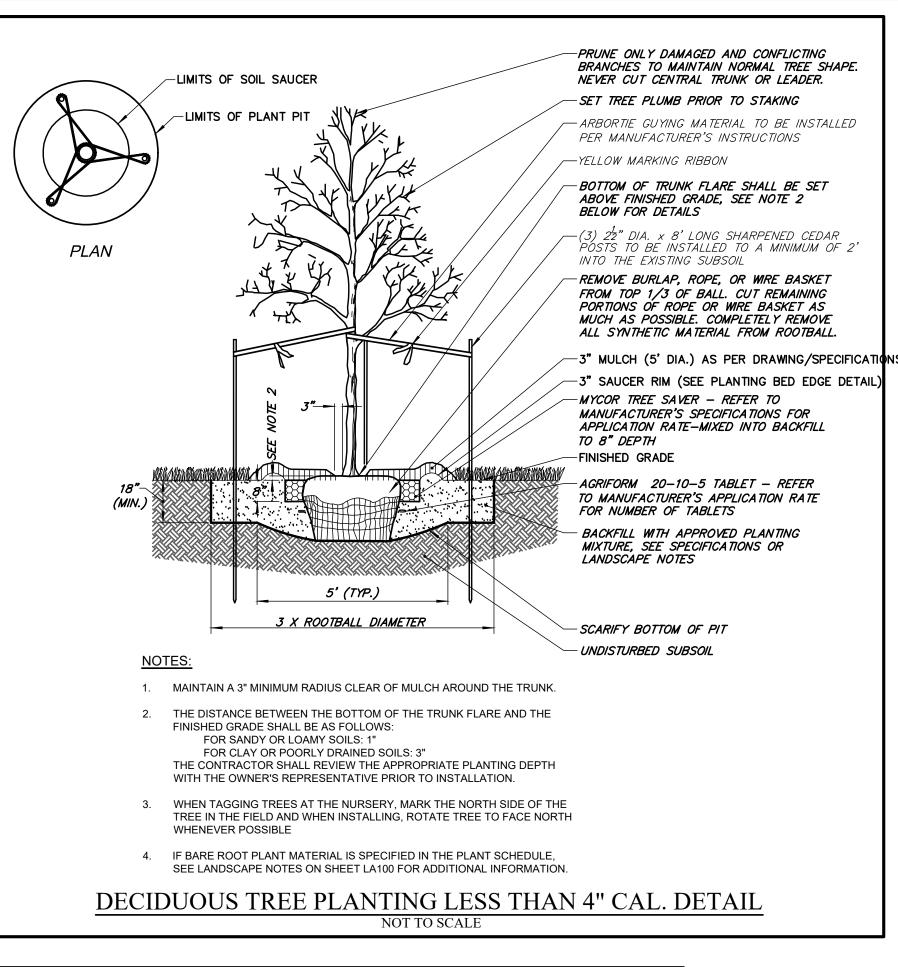

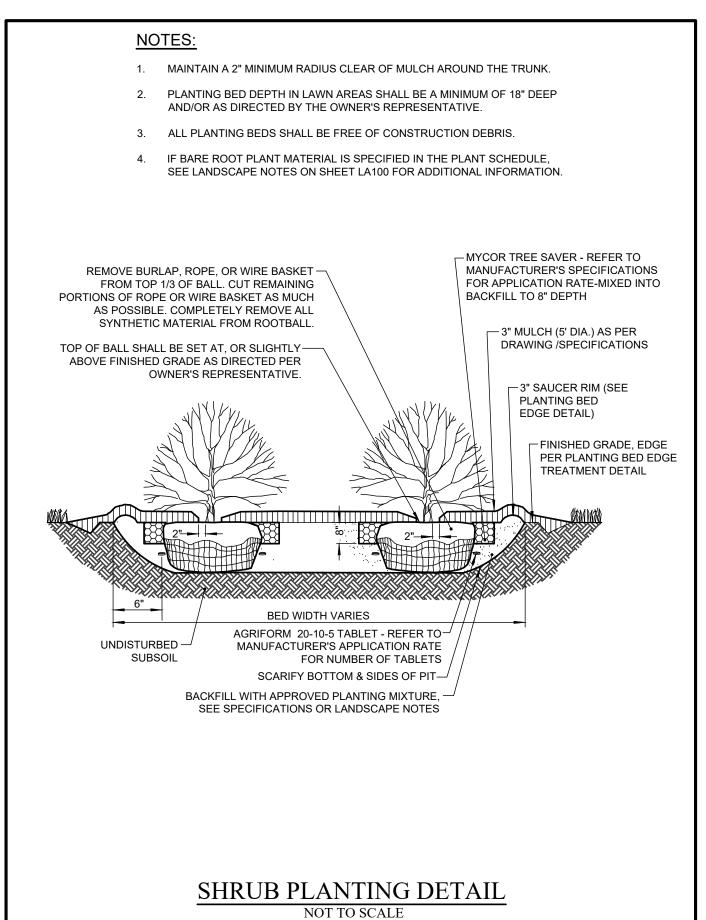

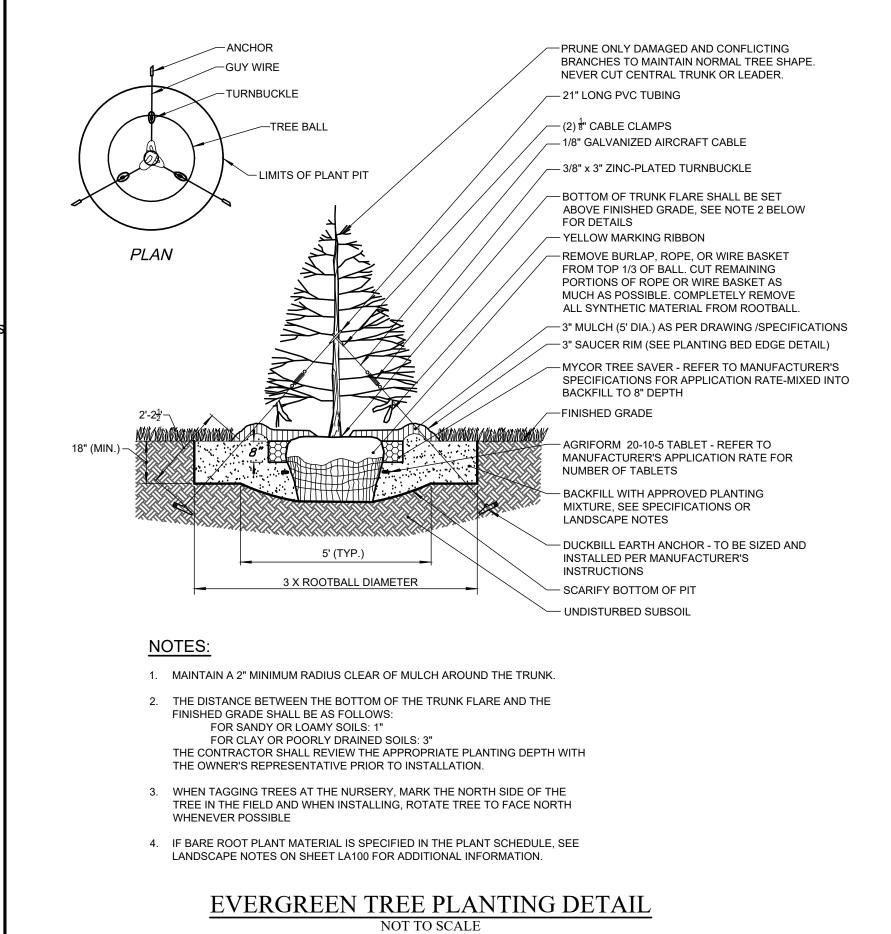

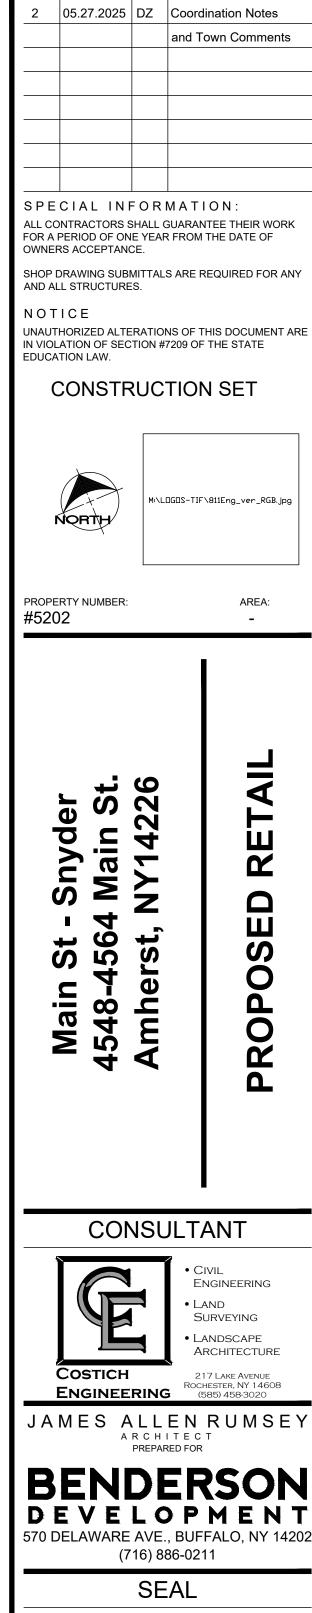

Landscaping

Details

DRAWING NO.

DRAWN BY:


TDM
CHECKED BY:
ERG
DATE:
05/29/2025

DRAWING REVISIONS:

No. DATE BY REMARKS

1 04.25.2025 DZ Arch Updates

OFFICIAL TOWN USE ONLY

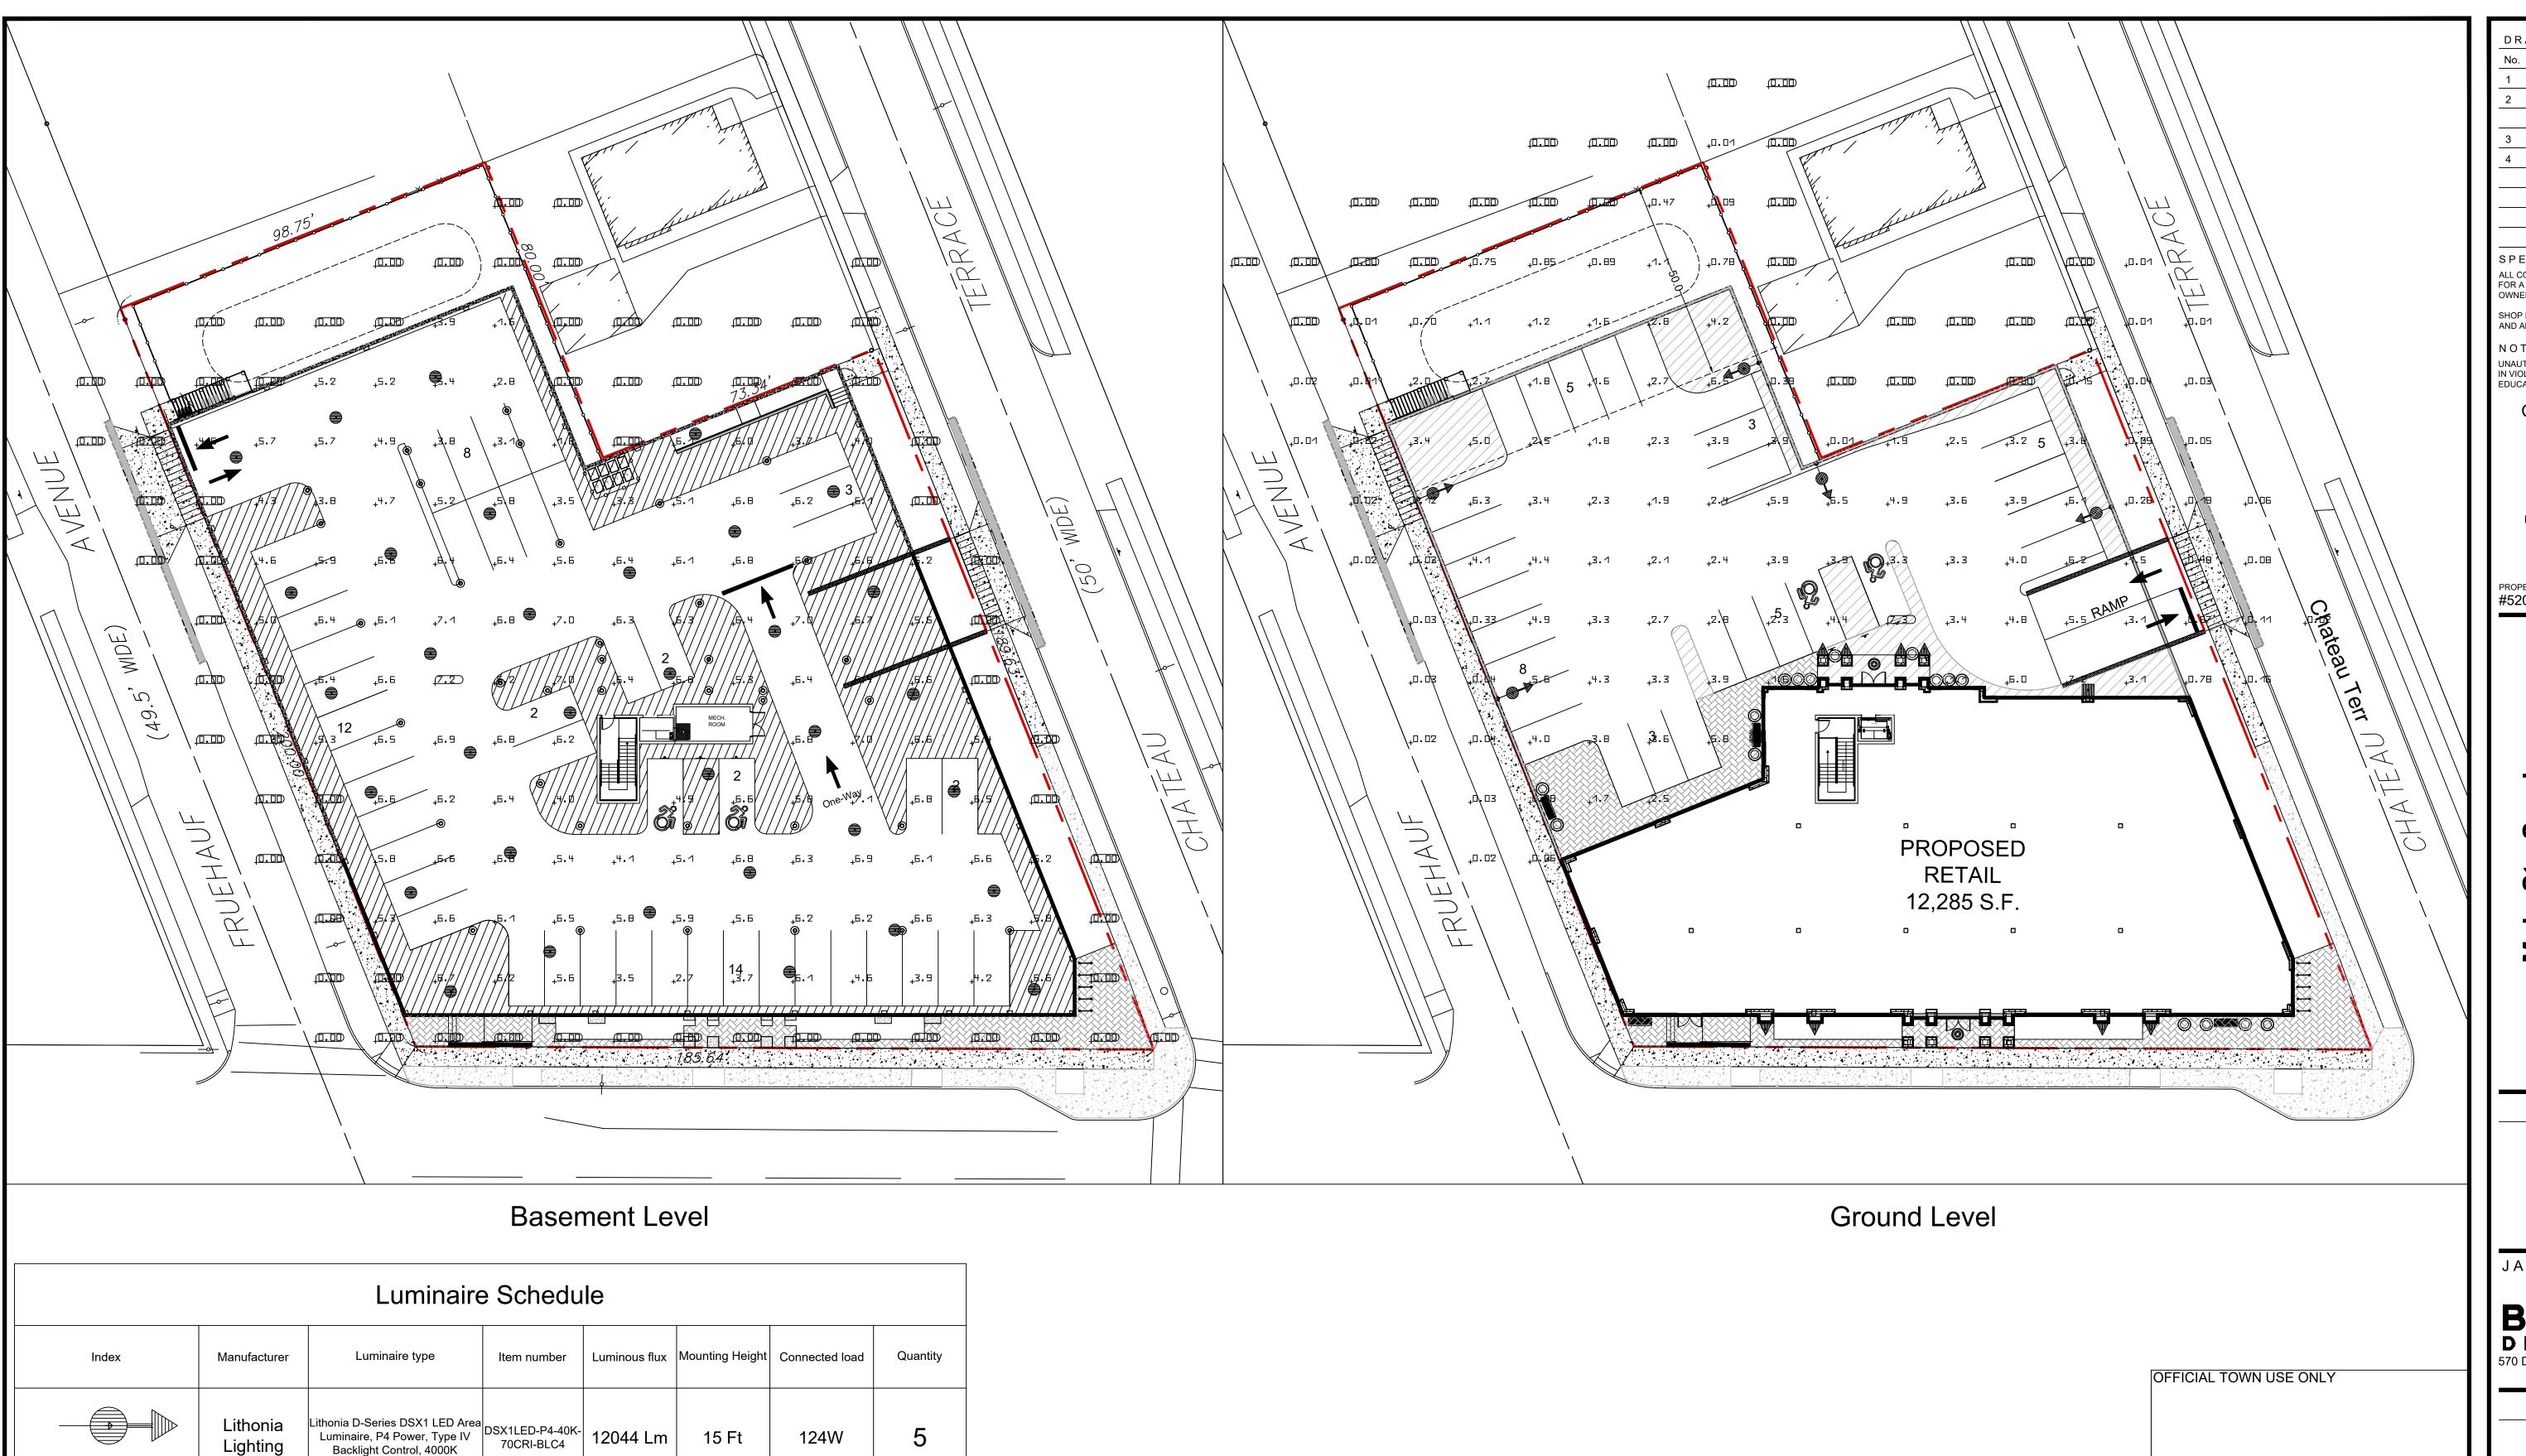

34		
2	#	Name
2	1	Non-Reside Parking Ar
	2	Canopy Ar

	FOOTCANDLE LEVELS AT GRADE							
#	Name	Parameter	Min	Max	Average			
1	Non-Residential Parking Area	Ground Level Parking and Site	0.44 fc Code: 0.2 fc	7.26 fc Code: 10.0 fc	1.45 fc Code: 1.5 fc			
2	Canopy Area	Basement Parking Area	2.10 fc Code: 2.0 fc	7.26 fc Code: 15.0 fc	4.75 fc Code: 10.0 fc			

DRAWING REVISIONS: No. DATE BY REMARKS 04.25.2025 DZ Arch Updates 05.27.2025 DZ Coordination Notes and Town Comments 06.04.2025 DZ Town Meeting Update 07.14.2025 DZ Site Updates

> SPECIAL INFORMATION: ALL CONTRACTORS SHALL GUARANTEE THEIR WORK FOR A PERIOD OF ONE YEAR FROM THE DATE OF OWNERS ACCEPTANCE.

SHOP DRAWING SUBMITTALS ARE REQUIRED FOR ANY AND ALL STRUCTURES.

UNAUTHORIZED ALTERATIONS OF THIS DOCUMENT ARE IN VIOLATION OF SECTION #7209 OF THE STATE

CONSTRUCTION SET





PROPERTY NUMBER:


PRO

CONSULTANT

JAMES ALLEN RUMSEY

570 DELAWARE AVE., BUFFALO, NY 14202

(716) 886-0211

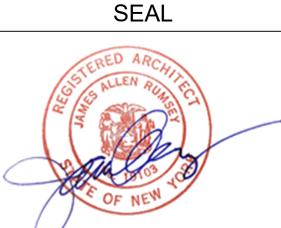



Lighting Plan

1" = 20' DRAWN BY: DMZ

DRAWING NO. MAO
DATE:
04.16.2025

Building Sconces- Refer to Architectural Plans

Ð

Lithonia

Lithonia

Lithonia

Lithonia VCPG Ultimate LED
Parking Garage,V8-P3 Power,
Type V Medium, 4000K

VCPGXLED-V8-P3
-40K-70CRI-T5M

6334 Lm

Lithonia WDGE3 LED Wall WDGE3 LED-P2-40 8779 Lm

Lithonia RCNY LED Canopy Luminaire, ALO1, Symmetric 0K-70CRI-SYMC 8355 Lm


Sconce, P2 Power, Type4, 4000K K-70CRI-R4


10 Ft


15 Ft


10 Ft


59W

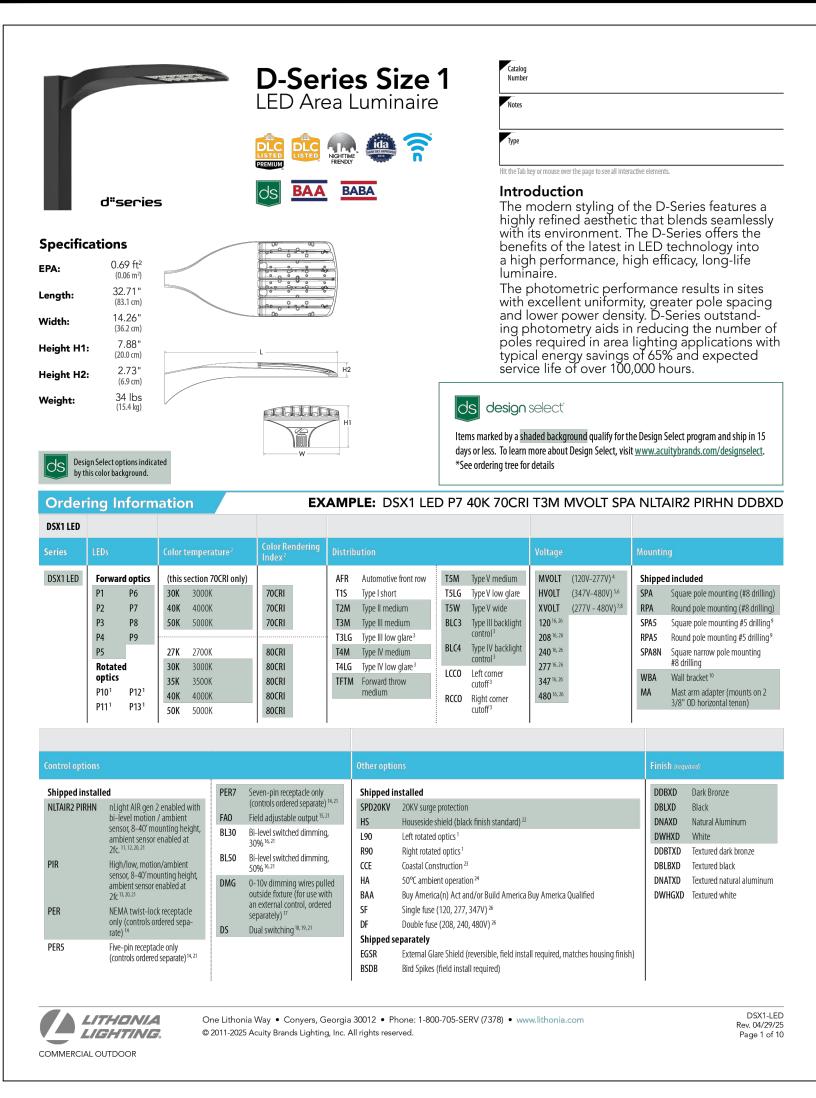

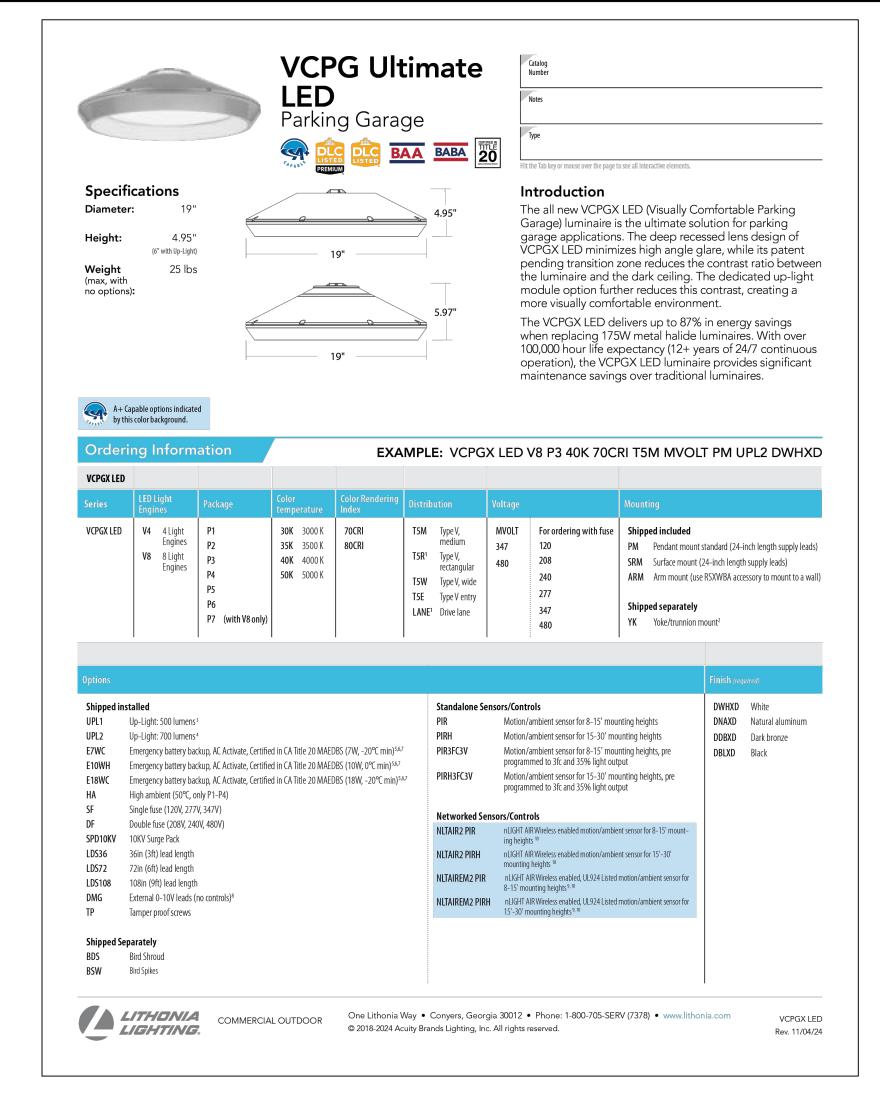

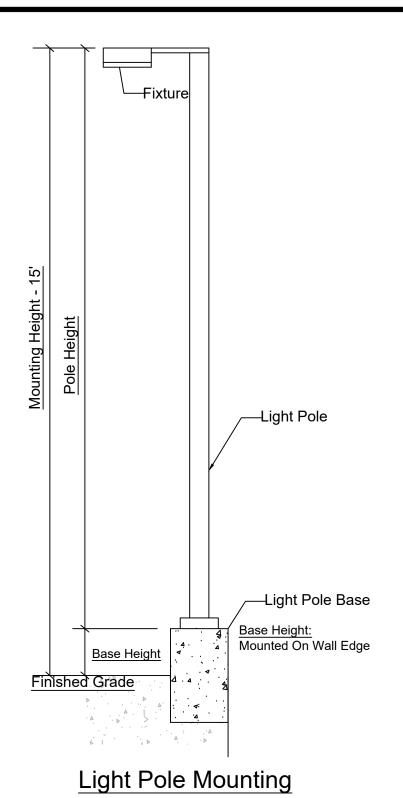

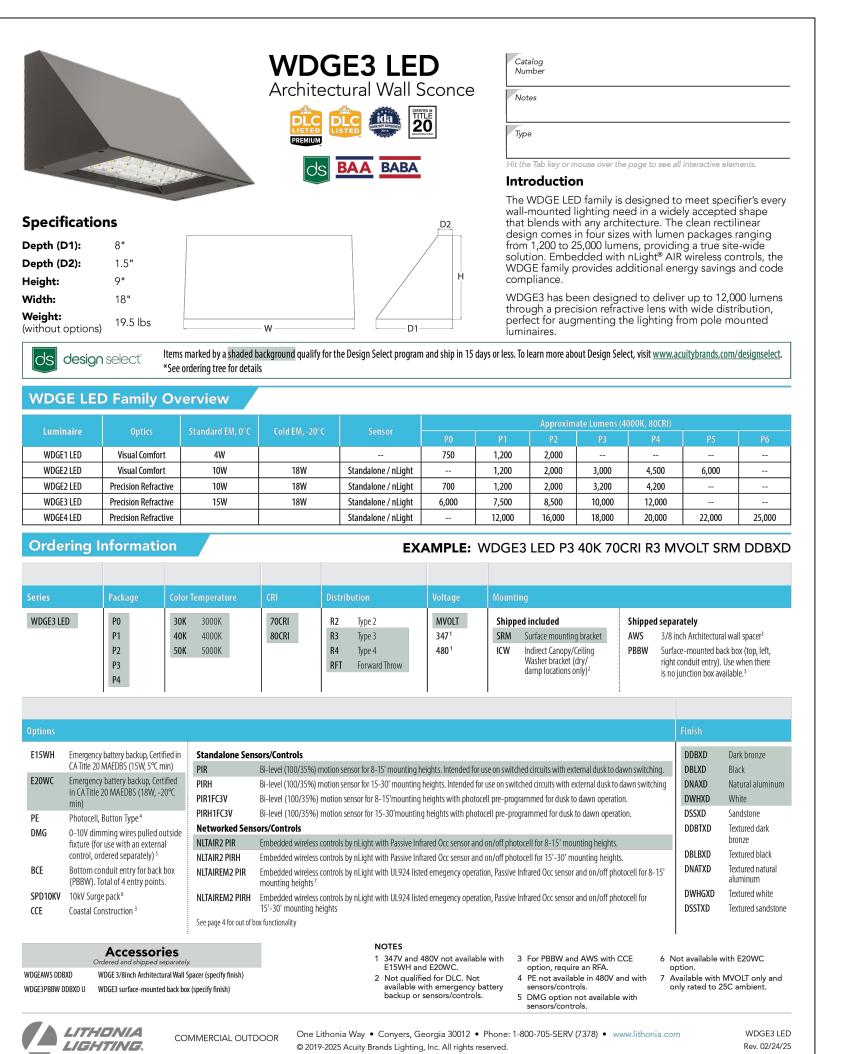

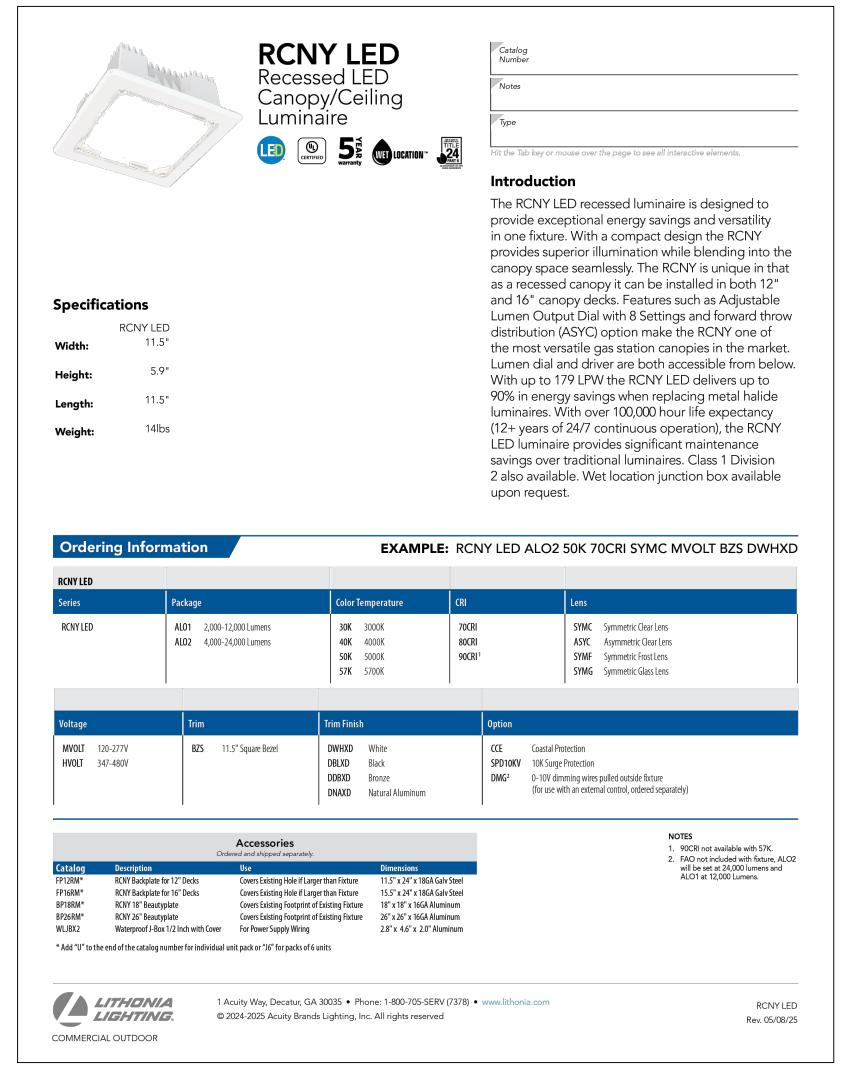



Building Architectural Lighting Refer to Elevations for specifications

DRAWING REVISIONS: No. DATE BY REMARKS 06.04.2025 DZ Town Meeting Update SPECIAL INFORMATION:

ALL CONTRACTORS SHALL GUARANTEE THEIR WORK FOR A PERIOD OF ONE YEAR FROM THE DATE OF OWNERS ACCEPTANCE. SHOP DRAWING SUBMITTALS ARE REQUIRED FOR ANY

AND ALL STRUCTURES.

UNAUTHORIZED ALTERATIONS OF THIS DOCUMENT ARE IN VIOLATION OF SECTION #7209 OF THE STATE

CONSTRUCTION SET



PROPERTY NUMBER: #5202

AREA:

S

0

0

Snyder Main St. NY14226


1

CONSULTANT

JAMES ALLEN RUMSEY ARCHITECT

570 DELAWARE AVE., BUFFALO, NY 14202

(716) 886-0211 SEAL

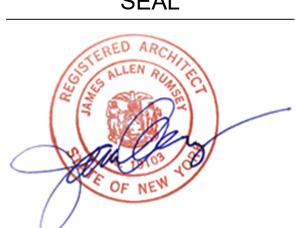

MAO DATE: 04.16.2025

OFFICIAL TOWN USE ONLY

Lighting **Details**

NTS DRAWING NO. DRAWN BY: DMZ CHECKED BY