PROPOSED RETAIL

Main St. - Snyder 4548-4564 Main Street Town of Amherst, NY 14226 BDC Property # 5202

INDEX OF DRAWINGS

<u>DWG. #</u>	DRAWING NAME	REVISION	DATE
C1.0	COVER SHEET	5	08.20.2025
C2.0	EXISTING SURVEY		
C3.0	DEMOLITION AND EROSION CONTROL PLAN	2	05.27.2025
C3.1	DEMOLITION AND EROSION CONTROL DETAILS		
C4.0	OVERALL SITE PLAN	5	08.20.2025
C4.1	DETAILED SITE PLAN	5	08.20.2025
C4.2	CONSTRUCTION DETAILS	3	06.04.2025
C5.0	GRADING PLAN	5	08.20.2025
C5.1	DRAINAGE PLAN	4	07.14.2025
C5.2	DRAINAGE DETAILS		
C6.0	UTILITY PLAN	5	08.20.2025
C6.1	UTILITY DETAILS		
C7.0	LANDSCAPING PLAN	5	08.20.2025
C8.0	LIGHTING PLAN	5	08.20.2025
C8.1	LIGHTING DETAILS	5	08.20.2025

OWNER/DEVELOPER:

NAME: BENDERSON DEVELOPMENT COMPANY, LLC ADDRESS: 570 DELAWARE AVENUE, BUFFALO, NY 14202

CONTACT: DAVID ZUPPELLI PHONE: 716 - 878 - 9683



BENDERSON DEVELOPMENT COMPANY, LLC

570 Delaware Ave. Buffalo, New York 14202

SURVEYOR

PHONE:

NAME: TRUE NORTH SURVEYING ADDRESS: 150 AERO DRIVE, BUFFALO NY 14225

716-631-5140

CONTACT: CHRISTOPHER BARR

UTILITIES:

WATER DEPARTMENT

ADAM MASSARO NAME/TITLE:

COMPANY/DEPT: ERIE COUNTY WATER AUTHORITY ADDRESS: 3030 UNION RD, CHEEKTOWAGA, NY

PHONE: 716 - 685-8207

BUILDING & PLUMBING DEPARTMENT

TOWN OF AMHERST, NY - BUILDING DPT 5583 MAIN STREET, WILLIAMSVILLE, NY 14221 ADDRESS:

716 - 631 - 7080

NATURAL GAS

NAME/TITLE: WILLIAM SCHNEIDER COMPANY/DEPT: NATURAL FUEL GAS **ADDRESS**

PHONE: 716 - 696 - 6460

TELEPHONE COMPANY

JOHN HECKMAN COMPANY/DEPT:

ADDRESS: PHONE: 716 - 840 - 8603

ELECTRIC

NAME/TITLE:

COMPANY/DEPT: NATIONAL GRID

ADDRESS: PHONE:

DIG SAFELY NEW YORK

PHONE: 1 - 800 - 962 - 7962 OR (811)

AGENCIES:

ENGINEERING DEPARTMENT

NAME/TITLE: JEFF BURROUGHS

COMPANY/DEPT: TOWN OF AMHERST, NY - ENGINEERING DPT ADDRESS: 1100 NORTH FOREST RD, WILLIAMSVILLE, NY

PHONE: 716 - 631 - 7154 EX 7418

PLANNING DEPARTMENT

NAME/TITLE: DAN HOWARD COMPANY/DEPT:

TOWN OF AMHERST, NY - PLANNING DPT

5583 MAIN STREET, WILLIAMSVILLE, NY 14221 ADDRESS:

PHONE: 716 - 631 - 7051


NYSDOT - HIGHWAY & UTILITY PERMITS NAME/TITLE: ASMA SHAWKAT


COMPANY/DEPT: NEW YORK STATE DEPARTMENT OF TRANSPORTATION

(NORTH ERIE RESIDENCY)

ADDRESS: 111 INDIAN ROAD. DEPEW, NEW YORK 14043

PHONE: 716 - 683 - 3476

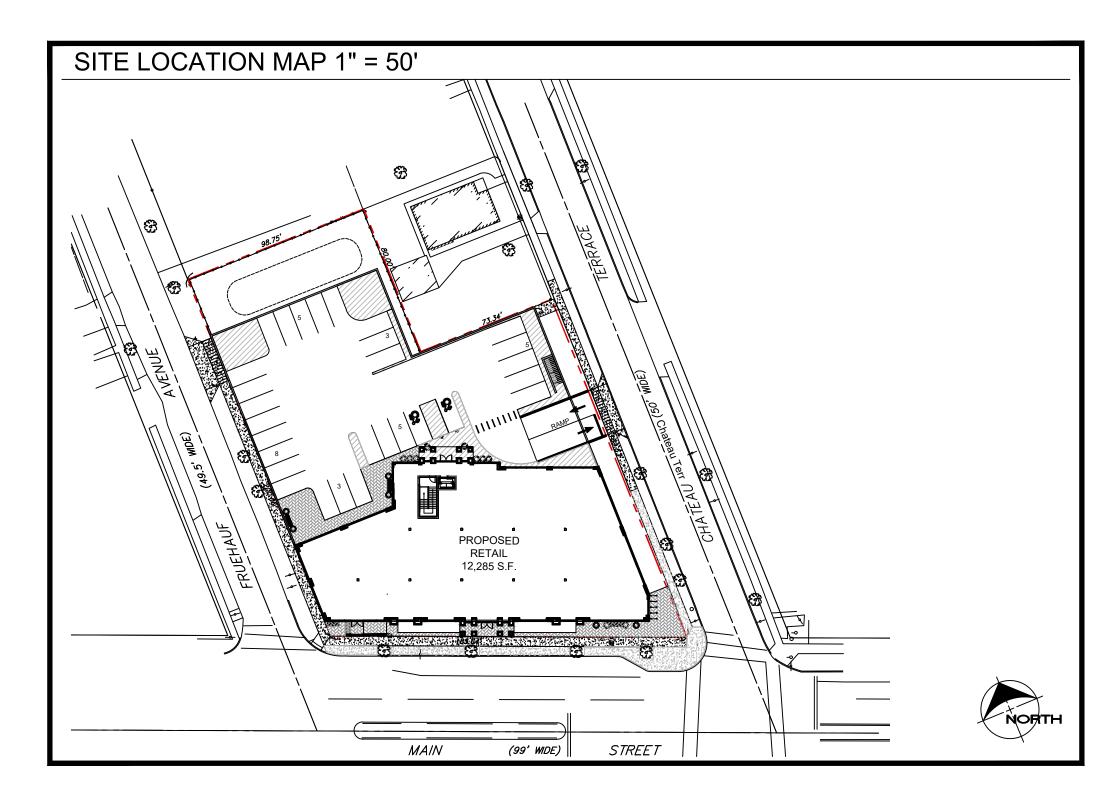

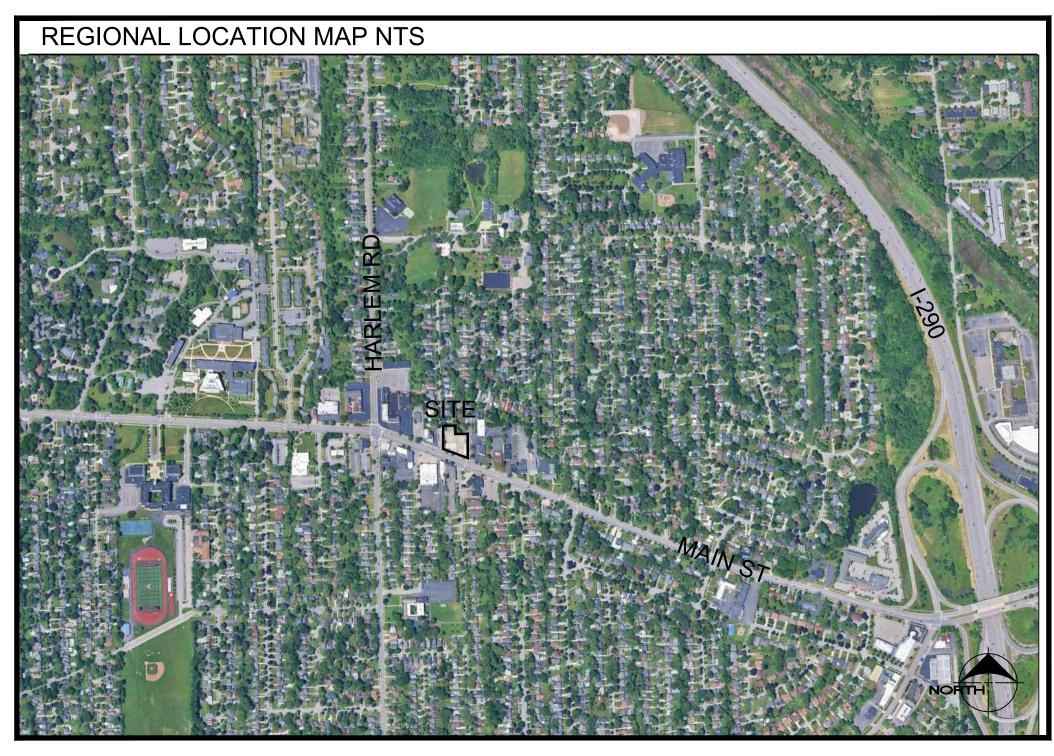

OFFICIAL TOWN USE ONLY

	DRAWING REVISIONS:						
	No.	DATE	BY	REMARKS			
	1	04.29.2025	DZ	Arch Updates			
	2	05.27.2025	DZ	Coordination Notes			
				and Town Comments			
	3	06.04.2025	DZ	Town Meeting Update			
	4	07.14.2025	DZ	Site Updates			
	5	08.20.2025	DZ	Site Updates			

SPECIAL INFORMATION ALL CONTRACTORS SHALL GUARANTEE THEIR WORK FOR A PERIOD OF ONE YEAR FROM THE DATE OF OWNERS ACCEPTANCE.

SHOP DRAWING SUBMITTALS ARE REQUIRED FOR ANY

UNAUTHORIZED ALTERATIONS OF THIS DOCUMENT AR IN VIOLATION OF SECTION #7209 OF THE STATE

CONSTRUCTION SET



PROPERTY NUMBER:

CONSULTANT

JAMES ALLEN RUMSEY

570 DELAWARE AVE., BUFFALO, NY 14202

SEAL




COVER **SHEET**

DRAWN BY:

DATE: 04.16.2025

DRAWING NO.

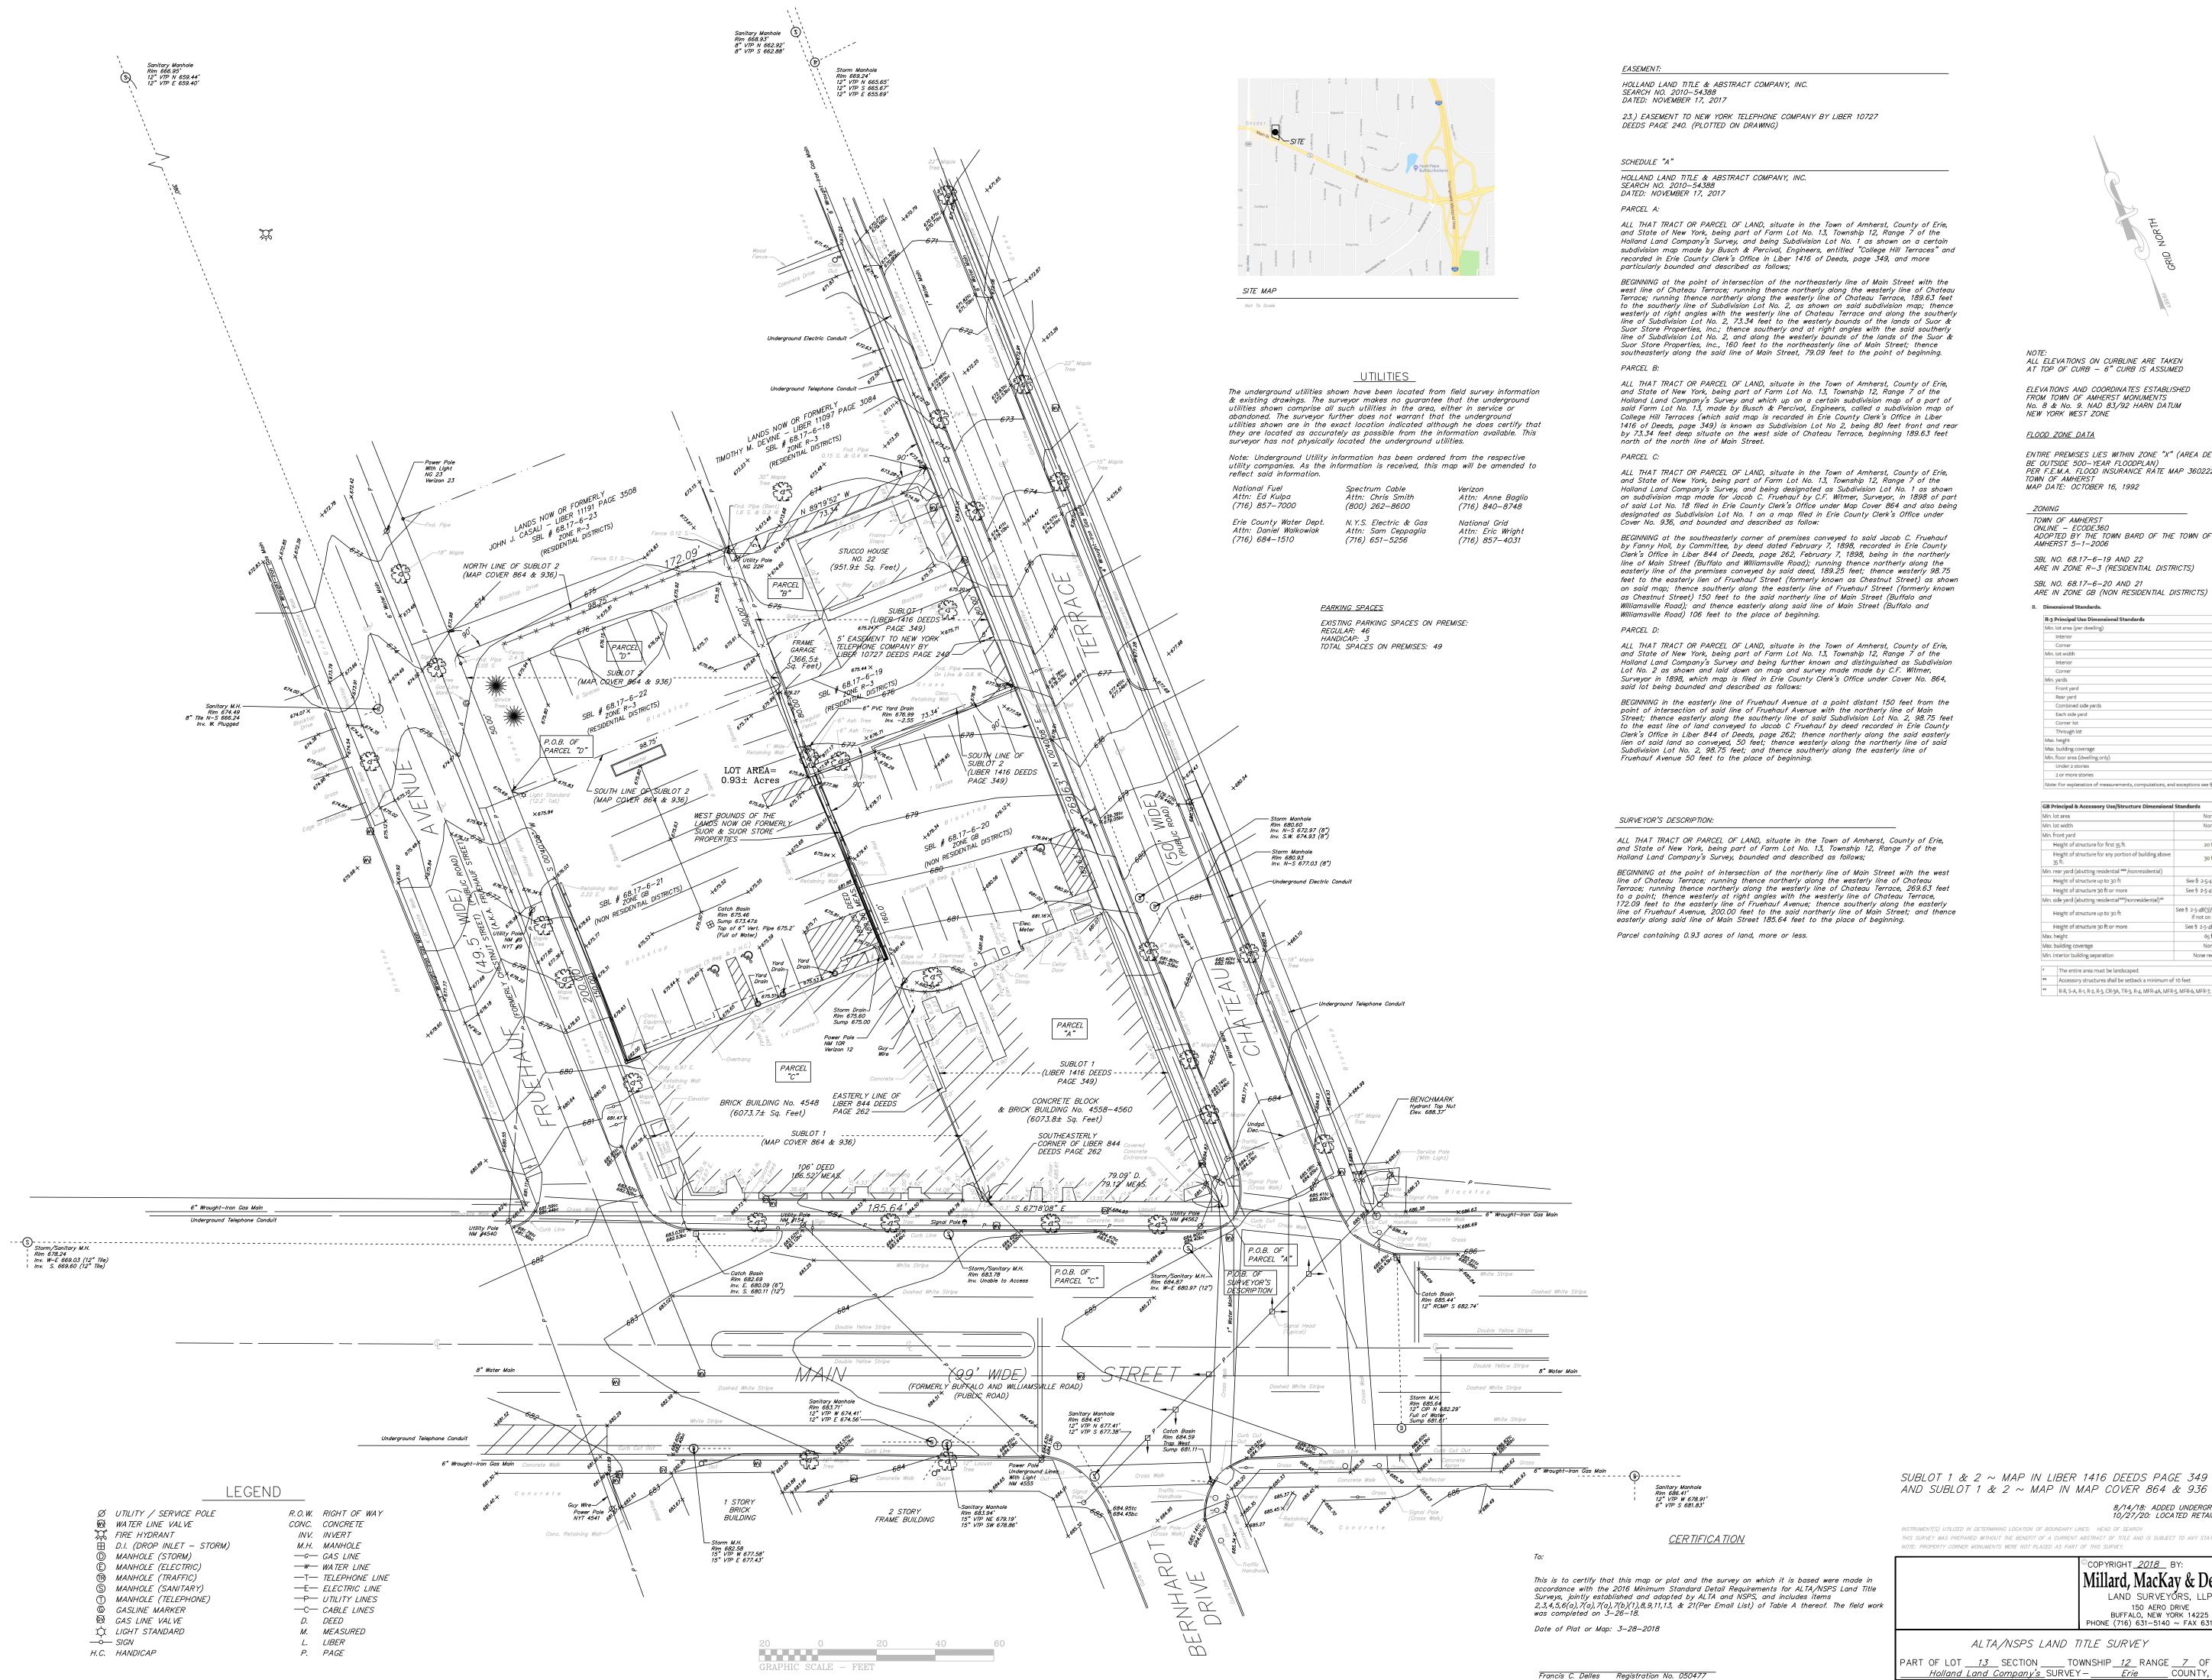



ALL ELEVATIONS ON CURBLINE ARE TAKEN AT TOP OF CURB — 6" CURB IS ASSUMED

ELEVATIONS AND COORDINATES ESTABLISHED FROM TOWN OF AMHERST MONUMENTS No. 8 & No. 9. NAD 83/92 HARN DATUM NEW YORK WEST ZONE

FLOOD ZONE DATA

ENTIRE PREMISES LIES WITHIN ZONE "X" (AREA DETERMINED TO BE OUTSIDE 500-YEAR FLOODPLAN) PER F.E.M.A. FLOOD INSURANCE RATE MAP 3602226 0012 E, MAP DATE: OCTOBER 16, 1992

TOWN OF AMHERST ONLINE — ECODE360

ADOPTED BY THE TOWN BARD OF THE TOWN OF AMHERST 5-1-2006

SBL NO. 68.17-6-19 AND 22 ARE IN ZONE R-3 (RESIDENTIAL DISTRICTS)

SBL NO. 68.17-6-20 AND 21 ARE IN ZONE GB (NON RESIDENTIAL DISTRICTS)

P. 2 Principal Use Dimensional Standards

Min. lot area (per dwelling)	
Interior	8,450 sf
Corner	9,750 sf
Min. lot width	
Interior	65 ft
Corner	75 ft
Min. yards	
Front yard	30 ft
Rear yard	30 ft
Combined side yards	10 ft
Each side yard	5 ft
Corner lot	See § 2-5-2A(5)
Through lot	See § 2-5-2A(2)
Max. height	2 stories (up to 35 ft)
Max. building coverage	35%
Min. floor area (dwelling only)	
Under 2 stories	1,000 sf
2 or more stories	1,200 sf
Note: For explanation of measurements, computations, and excep	otions see § 2-5. ^[1]

Vehicle Use Area 15 ft*/5 ft* See § 2-5-4B(3)/ None or 10 ft 15 ft*/5 ft* Height of structure up to 30 ft

See § 2-5-4B(3) / 25 ft

15 ft*/5 ft*

Max. building coverage Min. interior building separation The entire area must be landscaped.

R-R, S-A, R-1, R-2, R-3, CR-3A, TR-3, R-4, MFR-4A, MFR-5, MFR-6, MFR-7, PRD, PDD, PRD, NCD^[1]

SUBLOT 1 & 2 ~ MAP IN LIBER 1416 DEEDS PAGE 349

8/14/18: ADDED UNDERGROUND UTILITIES 10/27/20: LOCATED RETAINING WALL & GASLINE MARKER

INSTRUMENT(S) UTILIZED IN DETERMINING LOCATION OF BOUNDARY LINES: HEAD OF SEARCH THIS SURVEY WAS PREPARED WITHOUT THE BENEFIT OF A CURRENT ABSTRACT OF TITLE AND IS SUBJECT TO ANY STATE OF FACTS THAT MAY BE REVEALED IN SAI

> COPYRIGHT <u>2018</u> BY: AMEND: Millard, MacKay & Delles SURVEY DATE: 3-26-18 DRAWING DATE: 3-28-18 LAND SURVEYÕRS, LLP 150 AERO DRIVE SCALE: 1" = 20'BUFFALO, NEW YORK 14225 PHONE (716) 631–5140 ~ FAX 631–3811 "ALL RIGHTS RESERVED


ALTA/NSPS LAND TITLE SURVEY

PART OF LOT 13 SECTION TOWNSHIP 12 RANGE 7 OF THE:

Holland Land Company's SURVEY Erie COUNTY, N.Y.

ENDOSED WITH NEW YORK STATE LICENSED LAND SURVEYOR'S SEAL ALTERING ANY ITEM ON THIS MAP IS A VIOLATION OF THE LAW EXCEPT AS PROVIDED IN SECTION 7209, PART 2, OF THE NEW YORK STATE EDUCATION LAW. SURVEY OF: 22 Chateau Terrace, 4564 & 4548 Main Street and 17 Fruehauf Avenue, Town of Amherst SBL No. 68.17–6–219,20,21&2



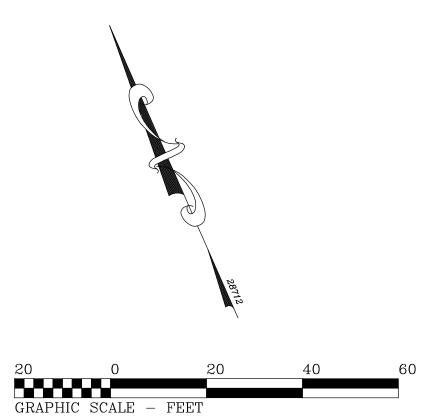

LEGEND

Ø UTILITY / SERVICE POLE W WATER LINE VALVE FIRE HYDRANT \boxplus D.I. (DROP INLET - STORM) D MANHOLE (STORM) E MANHOLE (ELECTRIC) ® MANHOLE (TRAFFIC) (S) MANHOLE (SANITARY) (T) MANHOLE (TELEPHONE)

GASLINE MARKER M GAS LINE VALVE ☆ LIGHT STANDARD

—॑— *SIGN* H.C. HANDICAP R.O.W. RIGHT OF WAY

CONC. CONCRETE INV. INVERT M.H. MANHOLE

—G— GAS LINE ─₩─ WATER LINE

—T— TELEPHONE LINE —E— ELECTRIC LINE

—P— *UTILITY LINES* —C— CABLE LINES


D. DEED M. MEASURED

L. LIBER

P. PAGE

SUBLOT 1 & 2 ~ MAP IN LIBER 1416 DEEDS PAGE 349 AND SUBLOT 1 & 2 ~ MAP IN MAP COVER 864 & 936

INSTRUMENT(S) UTILIZED IN DETERMINING LOCATION OF BOUNDARY LINES: HEAD OF SEARCH THIS SURVEY WAS PREPARED WITHOUT THE BENEFIT OF A CURRENT ABSTRACT OF TITLE AND IS SUBJECT TO ANY STATE OF FACTS THAT MAY BE REVEALED IN SAID ABSTRACT. NOTE: PROPERTY CORNER MONUMENTS WERE NOT PLACED AS PART OF THIS SURVEY.

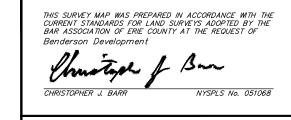

COPYRIGHT_2024_ BY:	
A TRUE NOI	RTH
LAND SURVEYING	à, PLLC
150 AERO DRIVE	
BUFFALO, NEW YORK 14	225
716)631-5140 ~ Truenortholl	c@aol.com

AMEND:

SURVEY DATE: 5-16-24 $^{\odot}$ DRAWING DATE: 5-17-24

"ALL RIGHTS RESERVED"

SCALE: 1" = 20'

SURVEY OF: 22 Chateau Terrace, 4564 & 4548 Main Street and 17 Fruehauf Avenue, Town of Amherst SBL No. 68.17-6-219,20,21&22


0.15 S. & 0.4 W. With Light NG 23 Verizon 23 Fnd. Pipe (Bent) 1.6 S. & 0.2 W. Fence 0.12 S.— Fnd. Pipe On Line & 0.6 V 10' x 20' concrete wash area, lined with a polyethylene sheet. location subject to change Construction Entrance Inv. S.W. 674.93 (8") Rim 680.93 Inv. N-S 677.03 (8") Temporary "Construction Site Entrance Only" Sign Catch Basin Rim 675.46 Sump 673.47 5 J. J. **(5)** Utilly Pole NN 14562.52 Signal, Role 🗣 s 🗸 p 🙀 (3) (12) Storm/Sanitary M.H.— Rim 684.87 Inv. W−E 680.97 (12") <u>In</u>v. Unable to A<u>ccess</u>

DEMOLITION & EROSION NOTES


- 1. USE NOTED ENTRANCE FOR CONSTRUCTION ENTRANCE
- 2. INSTALL TEMPORARY EROSION CONTROL DEVICES AS DIRECTED WITHIN THE WORKING AREA TO PREVENT SEDIMENT MIGRATION. ALL EROSION CONTROL DEVICES SHALL BE INSTALLED IN ACCORDANCE WITH THE
- 3. ALL EROSION CONTROL DEVICES SHALL BE REPLACED WHEREVER THEY BECOME INOPERABLE.
- 4. THE CONTRACTOR SHALL BE RESPONSIBLE FOR MAINTENANCE AND REMOVAL OF TEMPORARY 5. THE CONTRACTOR MUST CONTROL DUST DURING CONSTRUCTION, DURING EARTHWORK OPERATIONS,
- WATER-SPREADING EQUIPMENT SHALL BE PROVIDED BY THE CONTRACTOR, AND WATER SPREAD AS NECESSARY AND AS DIRECTED IN ORDER TO CONTROL DUST.
- 6. DIRT OR DEBRIS LEFT ON LOCAL PUBLIC ROADS AS A RESULT OF THIS CONSTRUCTION PROJECT SHALL BE REMOVED AND ROAD SURFACES CLEANED BY THE CONTRACTORS ON A DAILY BASIS, OR MORE FREQUENTLY IF DEEMED NECESSARY
- 7. ALL DISTURBED AREAS (EXCEPT AREAS TO BE PAVED OR BUILT UPON) SHALL BE TOPSOILED TO A MINIMUM OF 4" DEPTH AND SEEDED IMMEDIATELY AFTER FINE GRADING TAKES PLACE AND AS SOON AS PHYSICALLY
- 8. THE CONTRACTOR IS RESPONSIBLY FOR THE MAINTENANCE OF DOWNSTREAM STORM SEWERS, DITCHES AND CULVERTS. SILT BUILDUP FOUND TO BE A RESULT OF THIS SITE CONSTRUCTION WORK SHALL BE REMOVED FROM DOWNSTREAM CULVERTS, DETENTION PONDS, BY THE CONTRACTOR AT NO ADDITIONAL EXPENSE TO THE OWNER OR CITY.
- 9. ALL SOIL EROSION AND SEDIMENT CONTROL DEVICES AND MATERIALS SHALL BE IN PLACE PRIOR TO BEGINNING EARTHWORK OPERATIONS AND SHALL BE MAINTAINED UNTIL THE ALL GRADING WORKS ARE COMPLETE.

- INSTALL ALL MATERIALS TO MANUFACTURER'S RECOMMENDATIONS AND BEST STANDARDS OF TRADE INVOLVED.
- . SUBSTITUTIONS SHALL BE MADE ONLY WITH OWNER'S APPROVAL AND BE OF EQUIVALENT QUALITY TO WHAT IS SPECIFIED.
- . WORK SHALL BE COMPLETED IN STRICT ACCORDANCE WITH ALL LOCAL CODES AND OSHA SAFETY RULES AND REGULATIONS. 4. CONTRACTOR SHALL VERIFY ALL EXISTING CONDITIONS AND DIMENSIONS AT THE SITE. NOTIFY OWNER & ENGINEER OF DISCREPANCIES IN
- CONDITIONS SHOWN ON DRAWINGS PRIOR TO PROCEEDING WITH THE WORK. 5. CONTRACTOR SHALL BE RESPONSIBLE FOR PROTECTION OF ANY EXISTING STRUCTURES TO REMAIN AND ANY FINISH MATERIAL INSTALLED WHILE
- WORKING ON OTHER COMPONENTS. 6. CONTRACTOR SHALL KEEP JOB FREE OF DEBRIS AND MAKE FINAL CLEANUP TO THE SATISFACTION OF OWNER.
- . CONTRACTOR SHALL ASCERTAIN THE LOCATION OF ALL UTILITIES PRIOR TO CONSTRUCTION SO THAT THIS WORK WILL NOT DISTURB EXISTING LINES AND/OR INSTALLATIONS EXCEPT AS DETAILED ON THE PLANS. COORDINATE ALL WORK WITH THE APPLICABLE UTILITY COMPANIES.
- B. $\,$ CONTRACTOR SHALL OBTAIN AND PAY FOR ALL REQUIRED PERMITS NECESSARY TO PERFORM THE WORK.
- BUILDING DIMENSIONS ARE APPROXIMATE. REFER TO ARCHITECTURAL DRAWINGS FOR LAYOUT DIMENSIONS. $10.\;\;$ SIDEWALK DIMENSIONS ARE APPROXIMATE. REFER TO ARCHITECTURAL DRAWINGS FOR THE SIDEWALK PLAN .
- CONCRETE SIDEWALK SEALERS: (REFER TO ARCHITECTURAL PLANS FOR LOCATION OF CONCRETE TYPES.) 11.1. GREY CONCRETE SIDEWALKS SHALL HAVE CHEMMASTERS - SILENCURE WITHIN 2HRS AFTER FINAL FINISHING OF CONCRETE AND ALL
- 11.2. EXPOSED AGGREGATE/STAMPED CONCRETE SIDEWALKS SHALL HAVE ONE (x1) COAT CHEMMASTERS SILENCURE AS SOON AS CONCRETE HAS DRIED AFTER PRESSURE-WASHING THE RELEASE AGENT OFF. APRX 30 DAYS AFTER THIS (IF WEATHER PERMITS) APPLY ONE (x1) COAT OF
- CHEMMASTERS POLYSEAL EZ. 12. LIGHTING FIXTURE ARROW SYMBOLS REFER TO THE DIRECTION THAT THE FIXTURES ARE REQUIRED TO
- FACE. SPECIFIC MOUNT BRACKETS WILL BE REQUIRED DEPENDING ON ORIENTATION AND FIXTURE COUNT.
- 13. CURB ISLAND DIMENSIONS ARE FROM INSIDE OF CURB TO INSIDE OF CURB.
- 14. CONTRACTOR TO PROVIDE NEW PAVEMENT THAT CONFORMS TO THE GRADING PLAN WHILE MAINTAINING, AS A MINIMUM, THE EXISTING STONE BASE. THE MEANS AND METHODS OF OBTAINING NEW GRADES IS LEFT UP TO THE CONTRACTOR AND CAN BE OBTAINED VIA SHIMMING THE PAVEMENT AND THEN A NEW TOP COAT, REMOVING EXISTING ASPHALT PAVEMENT AND REGRADING EXISTING STONE BASE, A COMBINATION OF THESE TWO OR ANOTHER METHOD OF THE CONTRACTORS CHOOSING. FINAL PAVEMENT WORK PLAN SHALL BE PROVIDED TO OWNER AND ENGINEER FOR REVIEW AND APPROVAL

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Existing Building / Foundations

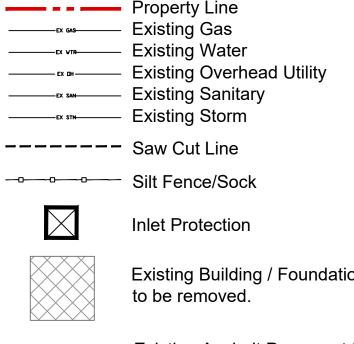

DEMOLITION LEGEND:

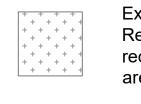Existing Asphalt Pavement to be Removed. Sub-base to be recycled, and reused to regrade

DEMOLITION NOTES: (#) Existing Building / Foundations to be

- Removed. Follow construction sequence for shoring removal of existing foundation walls. Existing Curb to be removed
- Limits of Curb Removal Existing Asphalt Pavement to be removed
- and regraded (Refer to General Note 14) Existing Concrete Sidewalk/ Pavement/
- Structures to be removed. Existing Storm Drainage/CB to remain and
- be protected during Construction. Existing Storm Drainage/CB to be removed. Existing Utility Structure to remain and be
- protected during Construction.
- Existing Utility Structure to be removed. 10. Existing Fence to be removed.
- 11. Existing Landscaping to be removed. 12. Existing Landscaping to Remain and be
 - protected during construction.

DRAWING REVISIONS: No. DATE BY REMARKS 05.27.2025 DZ Coordination Notes and Town Comments SPECIAL INFORMATION:

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UNAUTHORIZED ALTERATIONS OF THIS DOCUMENT ARE IN VIOLATION OF SECTION #7209 OF THE STATE

CONSTRUCTION SET





PROPERTY NUMBER: #5202

AREA:

S 0 0

CONSULTANT

JAMES ALLEN RUMSEY ARCHITECT

BENDERSON DEVELOPMENT 570 DELAWARE AVE., BUFFALO, NY 14202 (716) 886-0211


SEAL

Demolition and **Erosion Control**

1" = 20'

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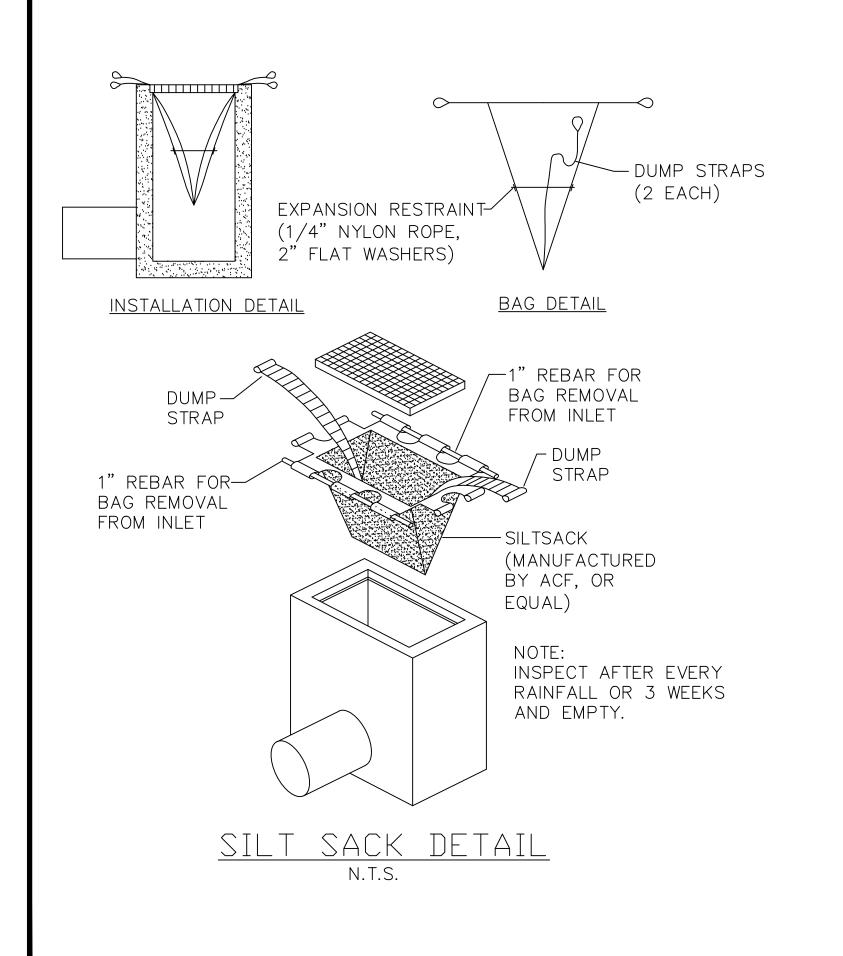
04.16.2025

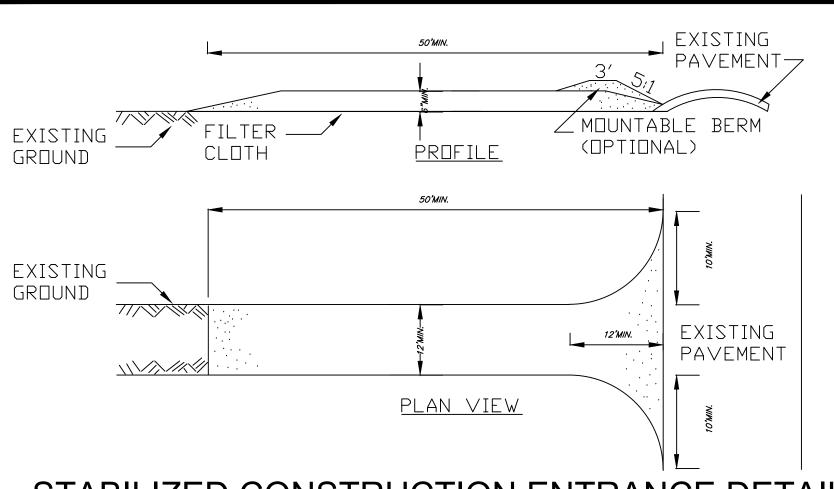



STABILIZED CONSTRUCTION ENTRANCE DETAIL

NOT TO SCALE

- 1. STONE SIZE USE 2" STONE, OR RECLAIMED OR RECYCLED CONCRETE EQUIVALENT.
- 2. LENGTH NOT LESS THAN 50 FEET (EXCEPT ON A SINGLE RESIDENCE LOT WHERE A 30 FOOT MINIMUM LENGTH WOULD APPLY).
- 3. THICKNESS NOT LESS THAN SIX (6) INCHES.
- 4. WIDTH TWELVE (12) FOOT MINIMUM, BUT NOT LESS THAN THE FULL WIDTH AT POINTS WHERE INGRESS OR EGRESS OCCURS. TWENTY-FOUR (24) FOOT IF SINGLE ENTRANCE TO SITE.
- 5. FILTER CLOTH WILL BE PLACED OVER THE ENTIRE AREA PRIOR TO PLACING OF STONE.
- 6. SURFACE WATER ALL SURFACE WATER FLOWING OR DIVERTED TOWARD CON-STRUCTION ENTRANCES SHALL BE PIPED ACROSS THE ENTRANCE. IF PIPING IS IMPRACTICAL, A MOUNTABLE BERM WITH 5:1 SLOPES WILL BE PERMITTED.
- 7. MAINTENANCE THE ENTRANCE SHALL BE MAINTAINED IN A CONDITION WHICH WILL PREVENT TRACKING OR FLOWING OF SEDIMENT ONTO PUBLIC RIGHTS-OF-WAY, ALL SEDIMENT SPILLED, DROPPED, WASHED OR TRACTED ONTO PUBLIC RIGHTS-OF-WAY MUST BE REMOVED IMMEDIATELY.
- 8. WHEN WASHING IS REQUIRED, IT SHALL BE DONE ON A AREA STABILIZED WITH STONE AND WHICH DRAINS INTO AN APPROVED SEDIMENT TRAPPING DEVICE.
- 9. PERIODIC INSPECTION AND NEEDED MAINTENANCE SHALL BE PROVIDED AFTER EACH RAIN.




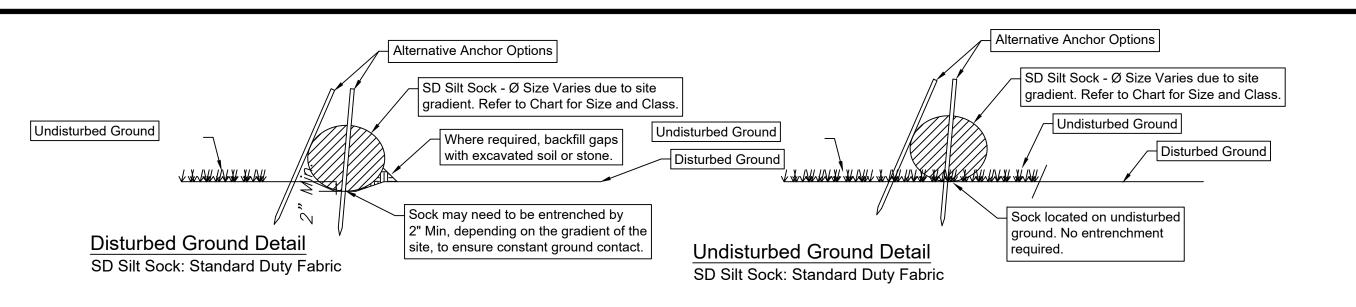

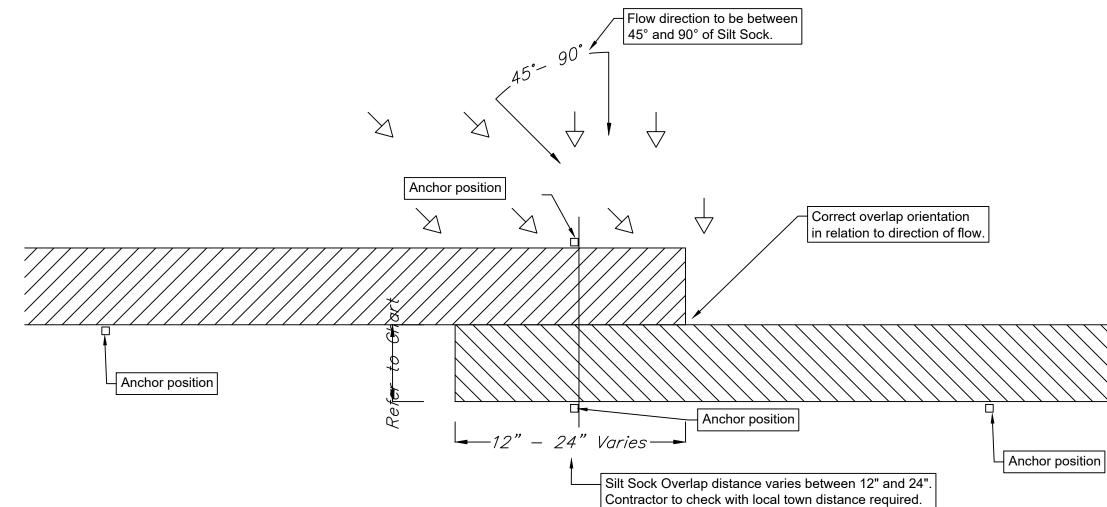


Overlap Detail - PLAN

1) Anchors required at the overlap section are to stay outside the Silt Sock and not pierce through the material. See alternative anchor positons in details above.

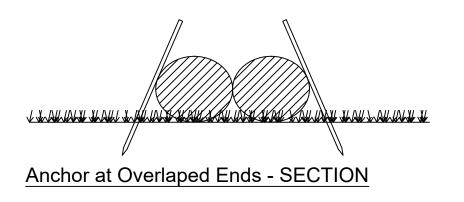

Size & Class Chart					
	D	iamete	er		
Gradient	8"	12"	18"		
0 - 2%	30	55	75		
2.1 - 5%	25	40	55		
5.1 - 10%	15	30	40		
10.1 - 33%	10	15	20		
> 33%	5	10	15		

SD SILT SOCK DETAIL SD Silt Sock: Standard Duty Fabric

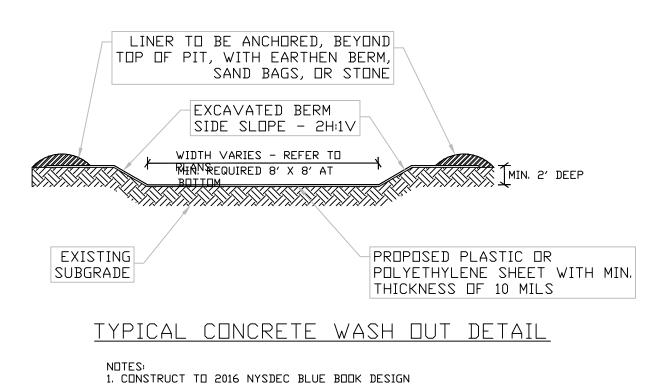




- 1 Do not use sock below the normal watermark or perpendicular to flow in river and where
- the maximum incline is greater than 50%. 2 - Contractors should be aware of federal, state and local laws, rules regulations or permit
- requirements for the use of Silt Socks on site. 3 - Sock should be positioned on the outline of the area to be protected, but must be
- installed between 45° to 90° from directions of flow. 4 - Sock may be required to be entrenched a minimum of 2" on disturbed ground to ensure constant ground contact.
- 5 All gaps and ruts must be backfilled with soil or sock material.
- 6 Sock overlap should be in the direction of the flow. Overlap amount will be between 12" and 24". Contractor to check with local town for requirements.
- 7 If sediment collects to 1/2 the height of the sock, then a second sock may be stacked immediately up slope of the original instead of removing the sediment.
- 8 Sock joint is where two sock sections meet on a level grade, overlap and adjoining ends, tightening the ends together, and anchoring through each end. Where two sections meet on un-level ground, j-hook higher elevated end, anchor, and begin new section just below.
- Back fill any gaps. 9 - Sock should be inspected and repaired as needed.
- 10 If ruts begin under the sock they should be backfilled with soil and compacted so that the ground and sock have continuous contact.
- 11 If sock rolls out of place, the sock should be repositioned and secured with additional
- 12 Tears in the Sock fabric may be repaired by wrapping a new piece of fabric over the sock and securing, or by place a second sock immediately up slope with the required overlap beyond deformation.
- 13 A section of sock should be replaced whenever it has weakened to such an extent that the efficiency is reduced or diminished. Weakening can occur because the natural mesh fabric breaks down over time of from being moved/dragged on site.
- 14 Sock should be replaced when sediment has built up and has been removed three
- 15 All sediment in disturbed area next to sock must be removed and correctly disposed of before the sock can be removed.

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- 16 When removing, cut sock open and spread the filler material around. The netting
- should be removed from site.
- 17 Sock should be installed before works commence on site.

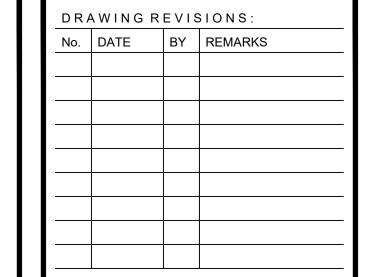

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UNAUTHORIZED ALTERATIONS OF THIS DOCUMENT ARE IN VIOLATION OF SECTION #7209 OF THE STATE

CONSTRUCTION SET





AREA:

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PROPERTY NUMBER: #5202

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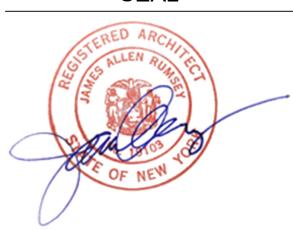
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CONSULTANT

JAMES ALLEN RUMSEY

570 DELAWARE AVE., BUFFALO, NY 14202

(716) 886-0211 SEAL




Demolition and Erosion **Control Details**

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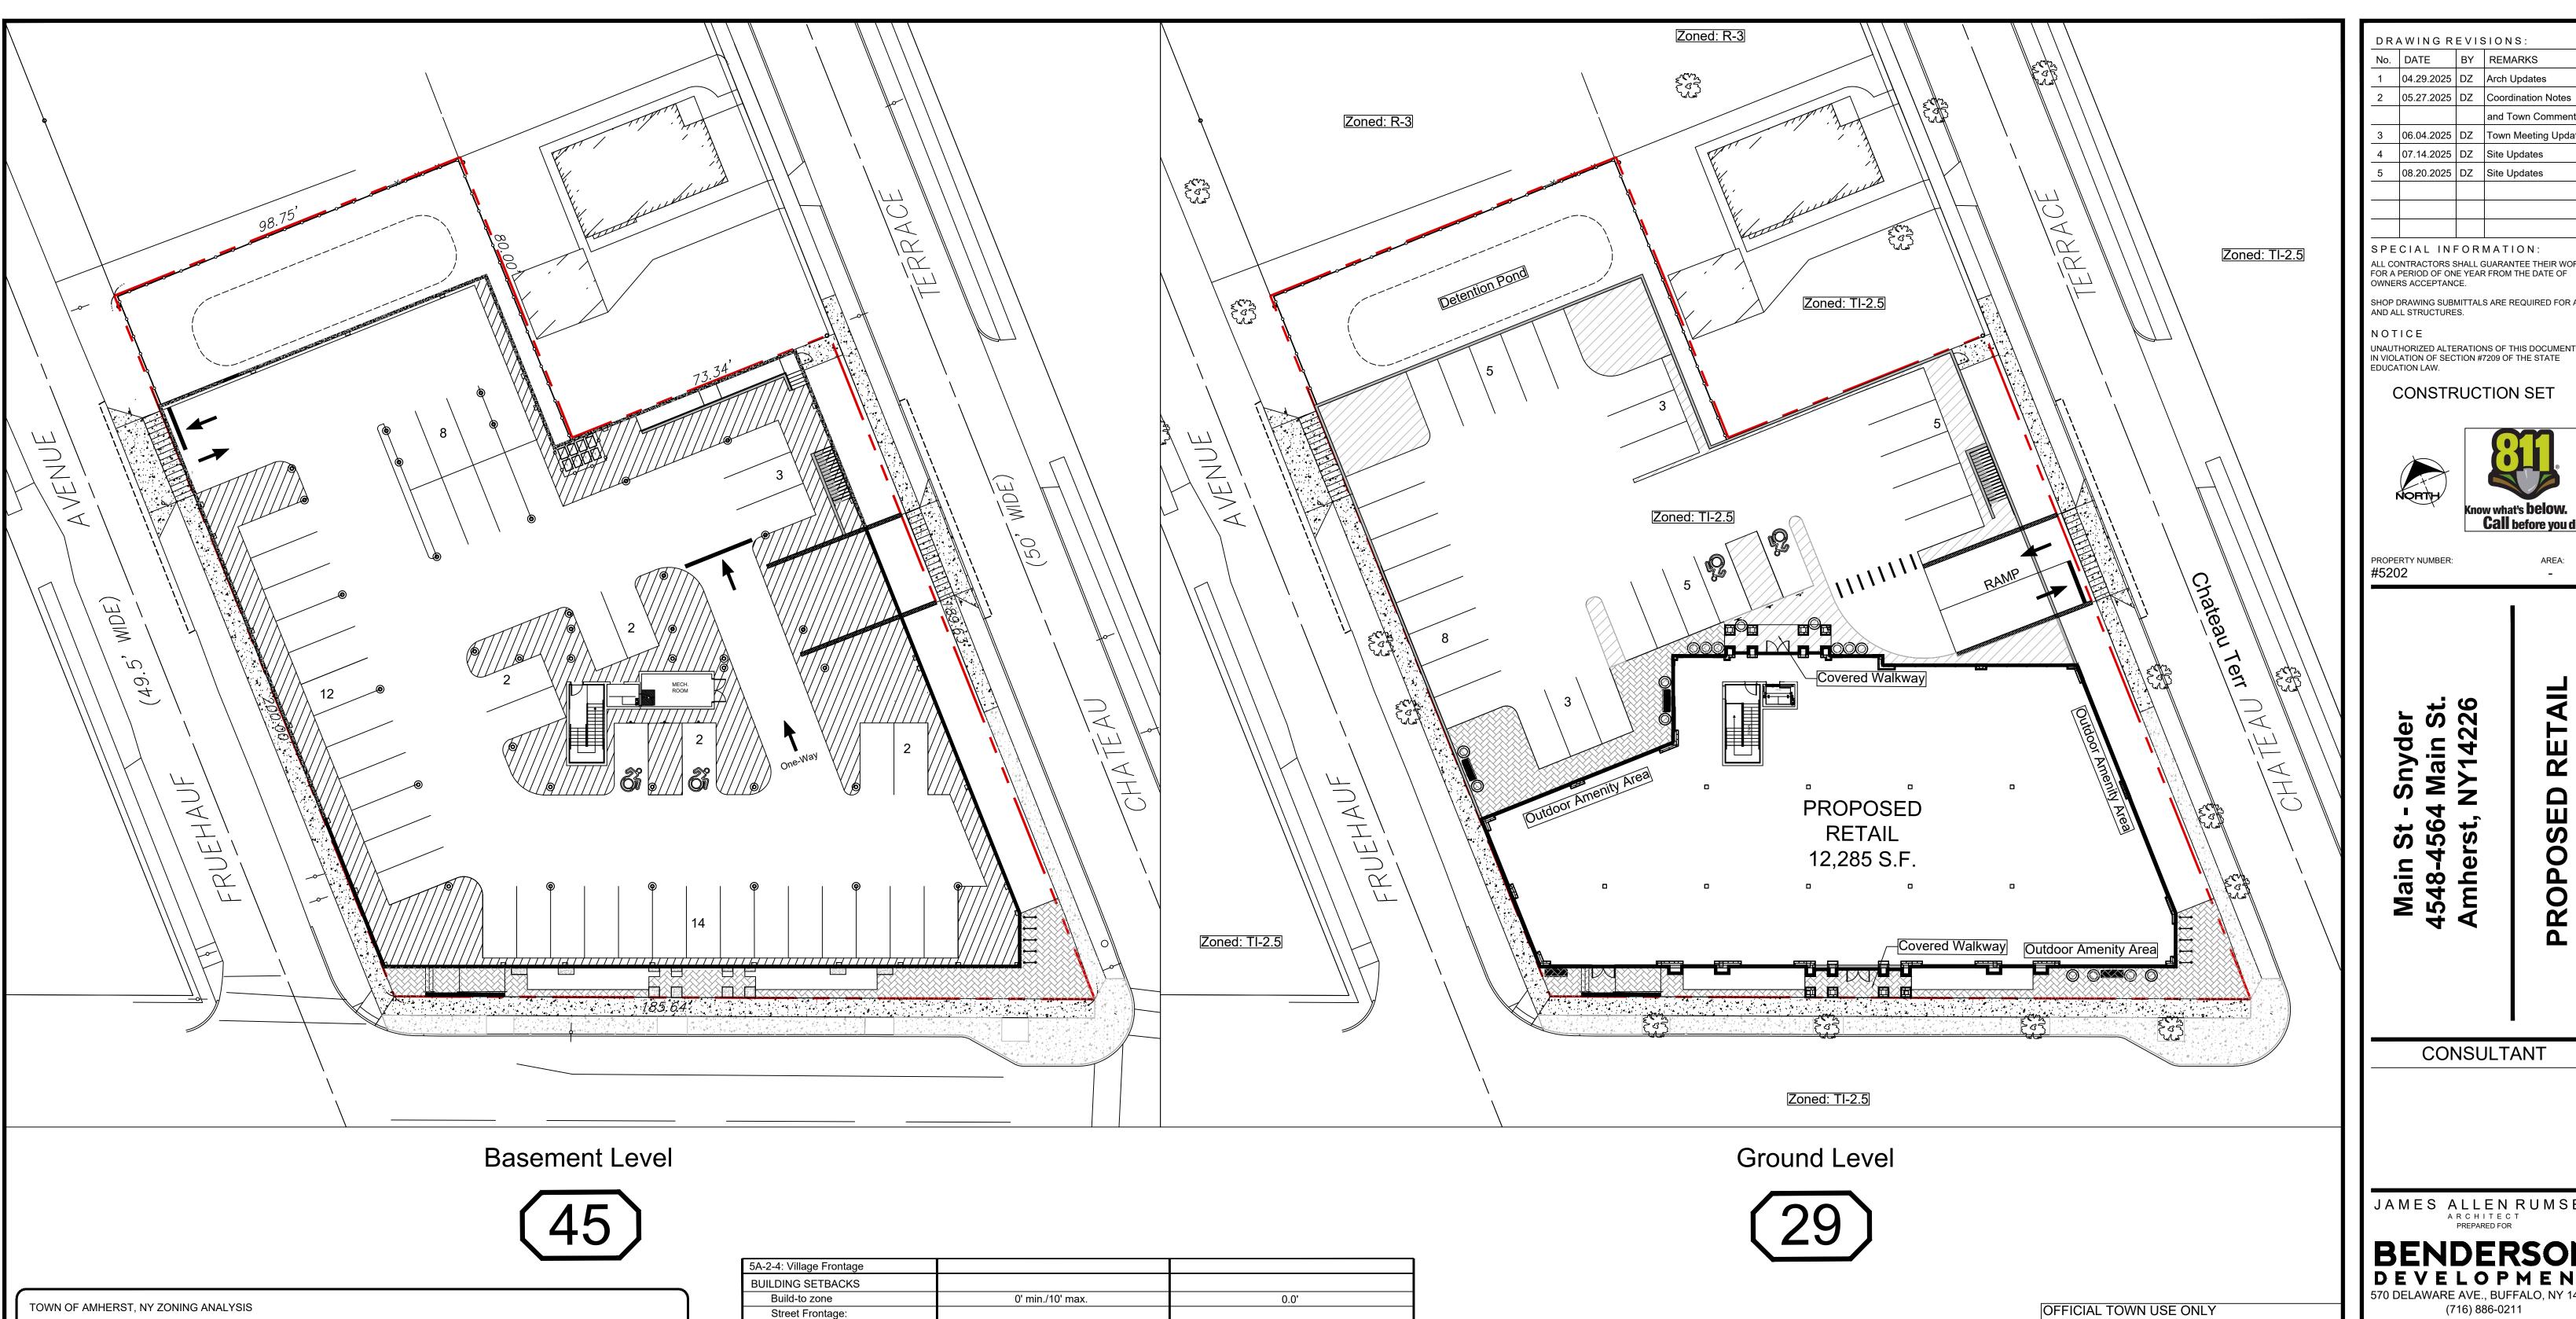
DATE: 04.16.2025

DRAWING NO. DMZ MAO

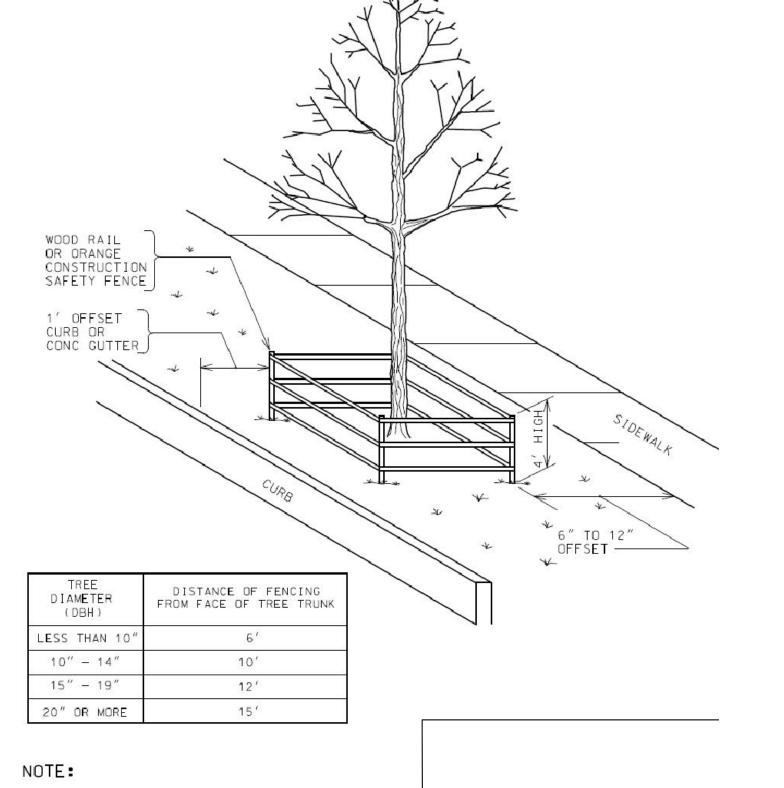

1. ALL TREES WITHIN THE PROJECT LIMITS THAT ARE TO REMAIN, ARE TO RECEIVE THIS TREATMENT.

DO NOT LEAVE CONSTRUCTION EQUIPMENT RUNNING (IDLING) UNDER TREE CANDPY.



	1	
	REQUIRED	PROVIDED
ZONED	TI-2.5 (Village Frontage)	TI-2.5 (Village Frontage)
5A-1-3: TI-2.5 Traditional Infill 2.5 S	ection	
LOT		
Area	0 S.F. min.	34,542 S.F.
Width	0' min.	170.7'
Outdoor Amenity Space	10% min. = 3,454 S.F.	3,590 S.F. = 10.4%
w/ Green Space	25% Min	44.3%
BUILDING SETBACKS		
Building-to-zone	Refer to Section 5A-2 Infill Frontages	
Lot Frontage	Refer to Section 5A-2 Infill Frontages	
Common lot line	0' min.	0.2' (North Side)
Alley	5' min.	N/A
PARKING SETBACKS		
Primary and Side Street	Refer to Section 5A-2 Infill Frontages (below)	
Common lot line	0' min.	3.8' (North Side)
Alley	5' min.	N/A
BUILDING HEIGHT		
Top Plate Height	2 Stories / 24' max.	N/A
Building Height	2.5 Stories / 35' max.	35'-0"
Roof Pitch	18:12 max.	18:12
BUILDING LENGTH	Refer to Section 5A-2 Infill Frontages (below)	168.5'
STORY HEIGHT	Refer to Section 5A-2 Infill Frontages (below)	16.5'

5A-2-4: Village Frontage		
BUILDING SETBACKS		
Build-to zone	0' min./10' max.	0.0'
Street Frontage:		
Front: Main Street	90% min.	90.9% (169.1/185.6)
Side: Fruehauf Ave	90% min.	94.5% (160.6 / (200 - 30' SB)
Side: Chateau Terr.	90% min.	92.0% (174.4/189.6)
PARKING SETBACKS		
Street	20' min.	52.8' (Main Street)
BUILDING MASS		
Street facing building length:		
Front: Main Street	200' max.	169.1'
STORY HEIGHT		+
Ground floor elevation	0' min. / 2' max.	0.0'
Ground story height	13' min.	16.5'
Upper story height	9' min.	12.5'
TRANSPARENCY		
Ground story	70% min.	70.1%
Upper story	20% min.	41.0%
Blank wall length	15' max.	4.0'
PEDESTRIAN ACCESS		
Street facing entrance	Required	Complies
Entrance spacing	50' max.	Complies
STREETSCAPE		
Clear pedestrian zone	10' min.	40.21 Total Eviating Condition
Curb zone	6' min.	10.3' Total - Existing Condition
Tree planting type	Grates	Complies
Tree spacing	35' on-center avg.	Existing: 33.3' c-c Average

	PROPOSED F	PARKING ANAYLSIS	S TI-2.5
	PROPOSED F	PARKING ANAYLSIS	S TI-2.5 REQUIRED
	USE	CODE	REQUIRED 12,285 sqft / 1000 x 2.5 =
	USE RETAIL	CODE 2.5/1000 SF	REQUIRED 12,285 sqft / 1000 x 2.5 = 31 SPACES 12,285 sqft / 3000 =

PROVIDED

74 SPACES

5 SPACES

9'x19'

and Town Comments 06.04.2025 DZ Town Meeting Update 07.14.2025 DZ Site Updates 08.20.2025 DZ Site Updates SPECIAL INFORMATION: ALL CONTRACTORS SHALL GUARANTEE THEIR WORK FOR A PERIOD OF ONE YEAR FROM THE DATE OF OWNERS ACCEPTANCE.

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UNAUTHORIZED ALTERATIONS OF THIS DOCUMENT ARE IN VIOLATION OF SECTION #7209 OF THE STATE EDUCATION LAW.

CONSTRUCTION SET



PROP

PROPERTY NUMBER:

AREA:

CONSULTANT

JAMES ALLEN RUMSEY
ARCHITECT
PREPARED FOR

570 DELAWARE AVE., BUFFALO, NY 14202 (716) 886-0211




Overall Site Plan


1" = 20' DRAWN BY:

DRAWING NO. DMZ CHECKED BY:
MAO
DATE:
04.16.2025




Proposed Outdoor Amenity Space

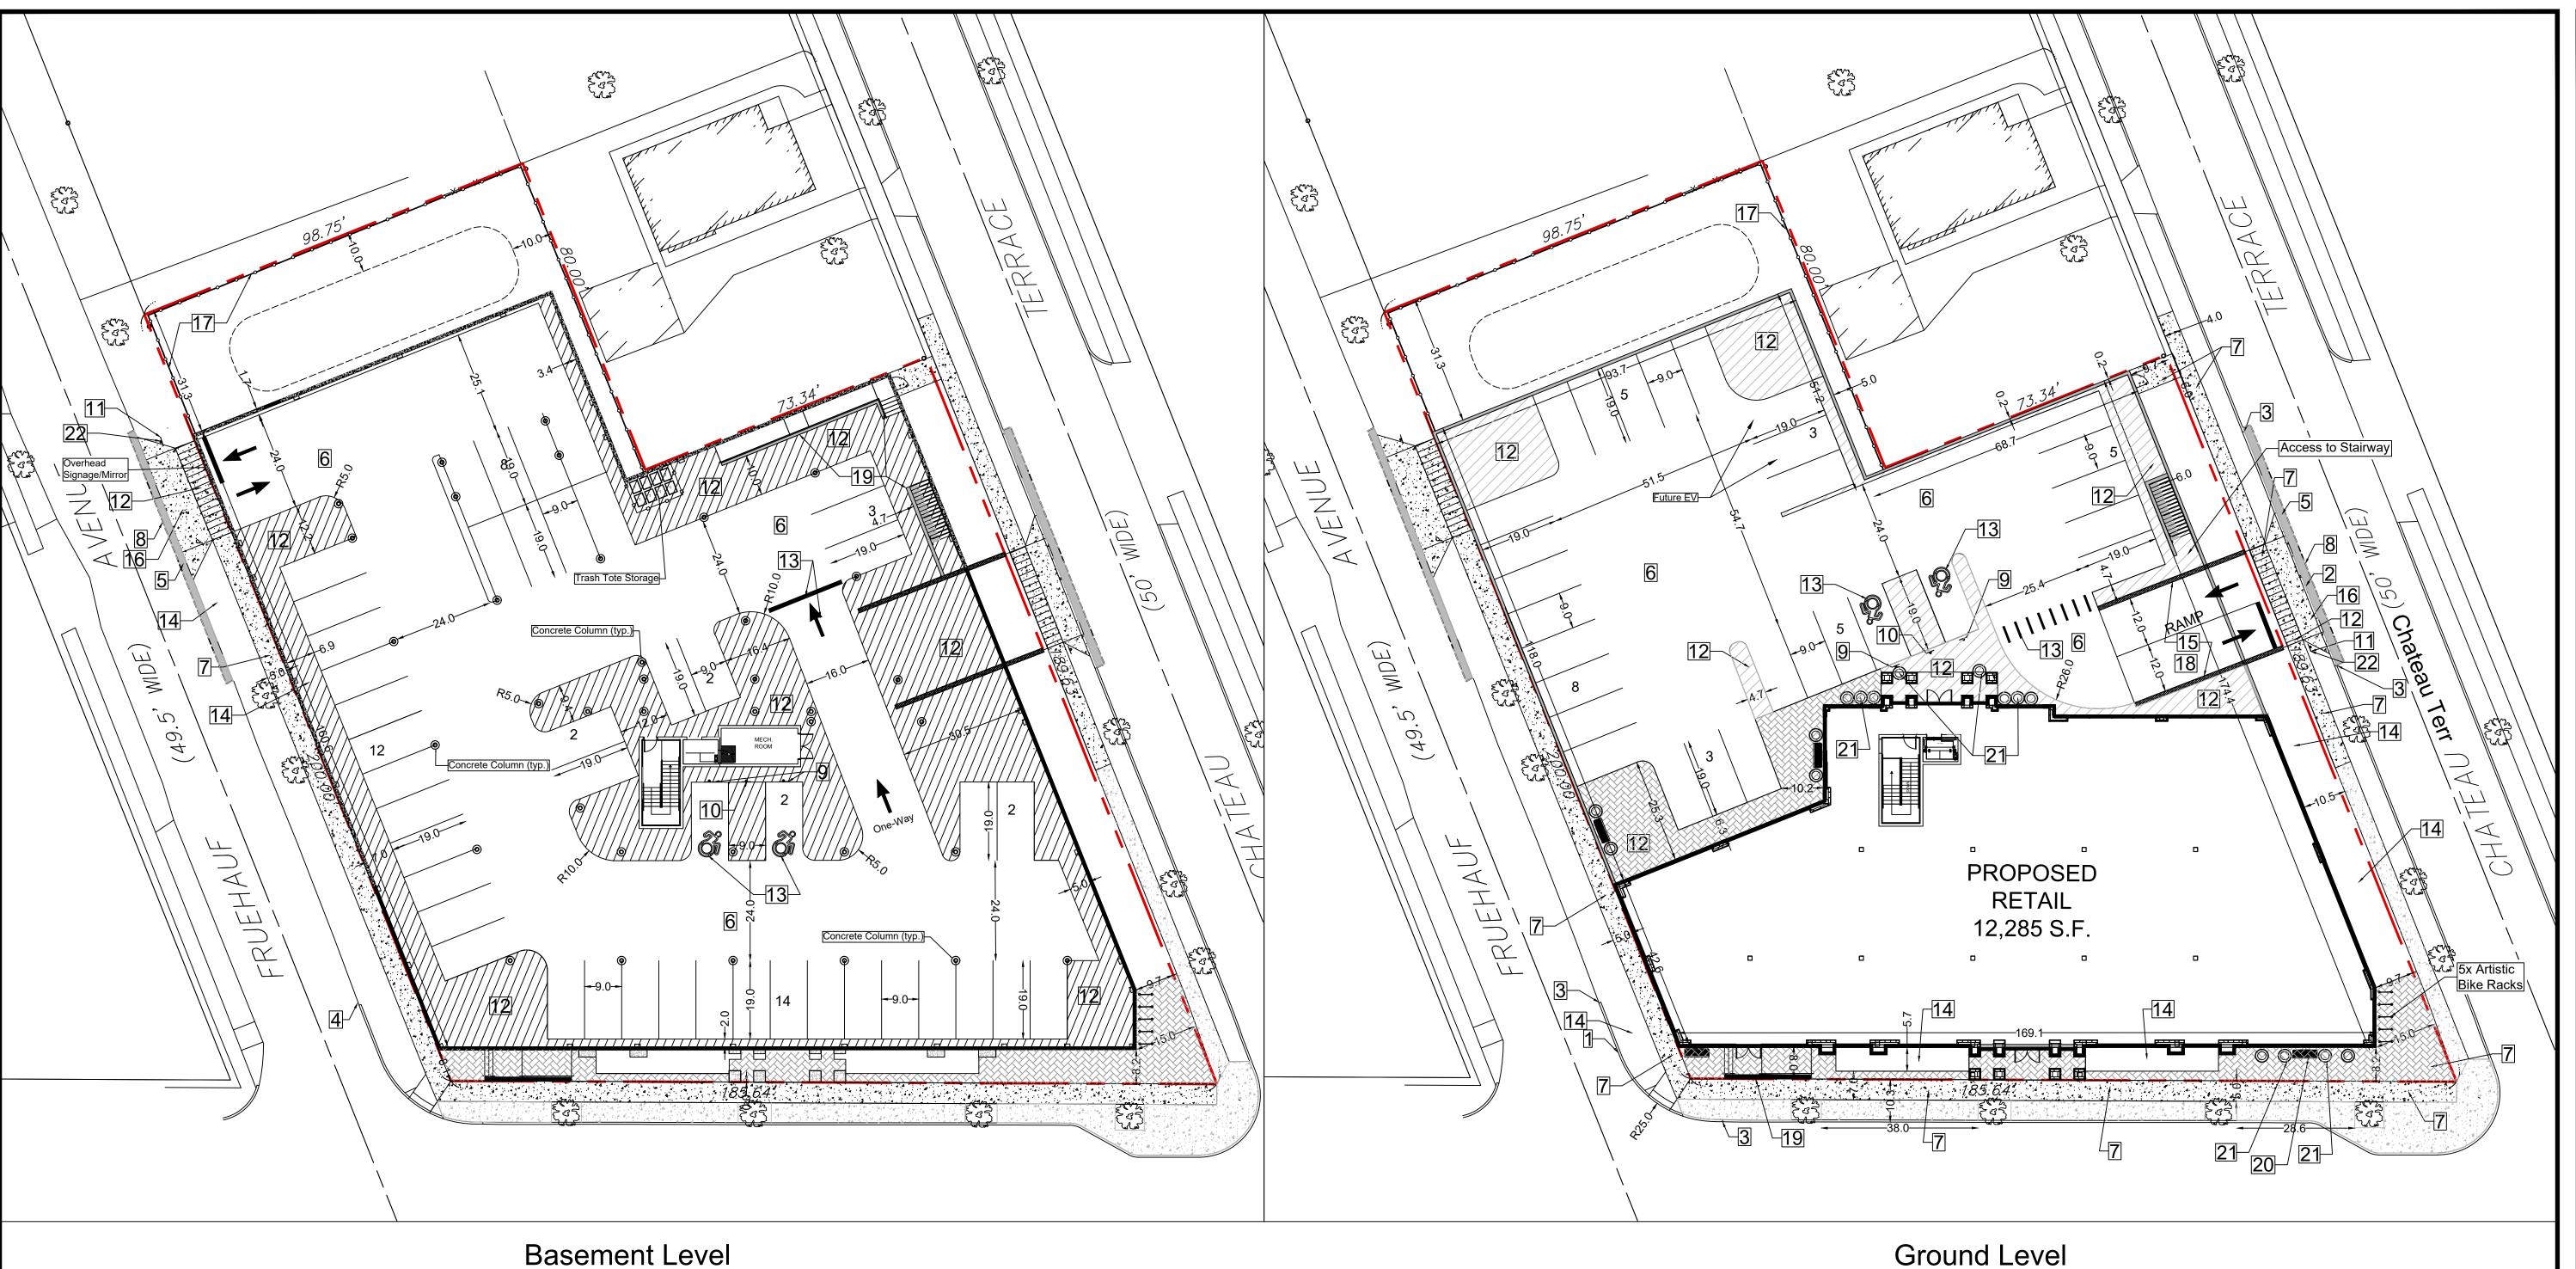

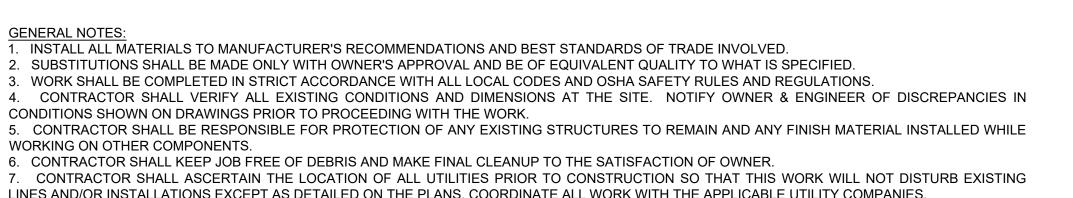

- LINES AND/OR INSTALLATIONS EXCEPT AS DETAILED ON THE PLANS. COORDINATE ALL WORK WITH THE APPLICABLE UTILITY COMPANIES.
- $oldsymbol{\mathsf{S}}$. CONTRACTOR SHALL OBTAIN AND PAY FOR ALL REQUIRED PERMITS NECESSARY TO PERFORM THE WORK. 9. BUILDING DIMENSIONS ARE APPROXIMATE. REFER TO ARCHITECTURAL DRAWINGS FOR LAYOUT DIMENSIONS.
- $10.\;\;$ SIDEWALK DIMENSIONS ARE APPROXIMATE. REFER TO ARCHITECTURAL DRAWINGS FOR THE SIDEWALK PLAN .CONCRETE SIDEWALK SEALERS: (REFER TO ARCHITECTURAL PLANS FOR LOCATION OF CONCRETE TYPES.)
- 11.1. GREY CONCRETE SIDEWALKS SHALL HAVE CHEMMASTERS SILENCURE WITHIN 2HRS AFTER FINAL FINISHING OF CONCRETE AND ALL BLEED WATER HAS DISSIPATED.
- 11.2. EXPOSED AGGREGATE/STAMPED CONCRETE SIDEWALKS SHALL HAVE ONE (x1) COAT CHEMMASTERS SILENCURE AS SOON AS CONCRETE HAS DRIED AFTER PRESSURE-WASHING THE RELEASE AGENT OFF. APRX 30 DAYS AFTER THIS (IF WEATHER PERMITS) APPLY ONE (x1) COAT OF
- 12. LIGHTING FIXTURE ARROW SYMBOLS REFER TO THE DIRECTION THAT THE FIXTURES ARE REQUIRED TO
- FACE. SPECIFIC MOUNT BRACKETS WILL BE REQUIRED DEPENDING ON ORIENTATION AND FIXTURE COUNT.
- 13. CURB ISLAND DIMENSIONS ARE FROM INSIDE OF CURB TO INSIDE OF CURB.
- 14. CONTRACTOR TO PROVIDE NEW PAVEMENT THAT CONFORMS TO THE GRADING PLAN WHILE MAINTAINING, AS A MINIMUM, THE EXISTING STONE BASE. THE MEANS AND METHODS OF OBTAINING NEW GRADES IS LEFT UP TO THE CONTRACTOR AND CAN BE OBTAINED VIA SHIMMING THE PAVEMENT AND THEN A NEW TOP COAT, REMOVING EXISTING ASPHALT PAVEMENT AND REGRADING EXISTING STONE BASE, A COMBINATION OF THESE TWO OR ANOTHER METHOD OF THE CONTRACTORS CHOOSING. FINAL PAVEMENT WORK PLAN SHALL BE PROVIDED TO OWNER AND ENGINEER FOR REVIEW AND APPROVAL

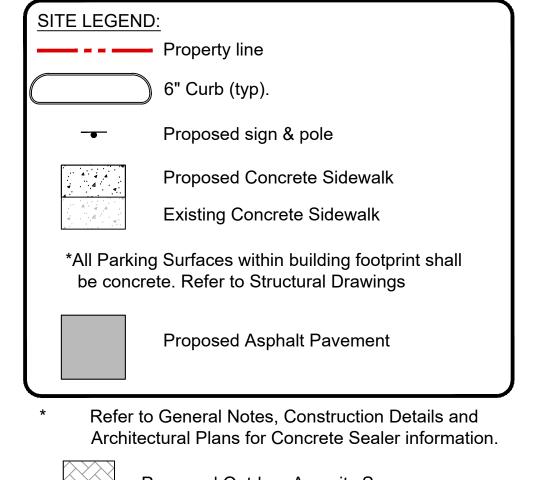



Proposed Outdoor Amenity Space (Paver Surface)



- 1. Proposed 6" concrete Curb.
- 2. Proposed Flush Concrete Curb.

OFFICIAL TOWN USE ONLY

- Match into Existing Curb or runout over 2'.
- Proposed Edge of Pavement. Proposed Standard Duty Pavement.
- 6. Proposed Concrete Deck / Pavement.
- Refer to Structural Drawings
- Proposed Concrete/Paver Sidewalk.
- Match into Existing Pavement. 9. Proposed "Handicapped Parking Only" sign.
- 10. Proposed "No Parking" sign. 11. Proposed STOP Sign.
- 12. 4" Yellow Pavement Stripe (at 2' c-c in no parking
- zones) 13. Proposed White Pavement symbol (stop bar,
- directional arrows, accessibility symbol, text)
- 14. Proposed Landscape Area.
- 15. Proposed Ramp Retaining Wall (Refer to
- 16. Proposed Concrete Driveway.
- Structural Plans)
- 17. Proposed Solid Composite Fence
- 18. Proposed Heated Concrete Ramp
- 19. Proposed Ramp/Stairs with retaining wall. 20. Proposed Pedestrian Bench
- 21. Proposed Circular Landscape Planter
- 22. Traffic Signage (Restricted No Turn)

DRAWING REVISIONS: DATE BY REMARKS 04.29.2025 DZ Arch Updates 05.27.2025 DZ Coordination Notes and Town Comments 06.04.2025 DZ Town Meeting Update 07.14.2025 DZ Site Updates 08.20.2025 DZ Site Updates

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CONSTRUCTION SET



PROPERTY NUMBER:

0

CONSULTANT

JAMES ALLEN RUMSEY


BENDERSON 570 DELAWARE AVE., BUFFALO, NY 14202



Detailed Site Plan

1" = 20' DRAWN BY: DMZ

DRAWING NO. DATE: **04.16.2025**

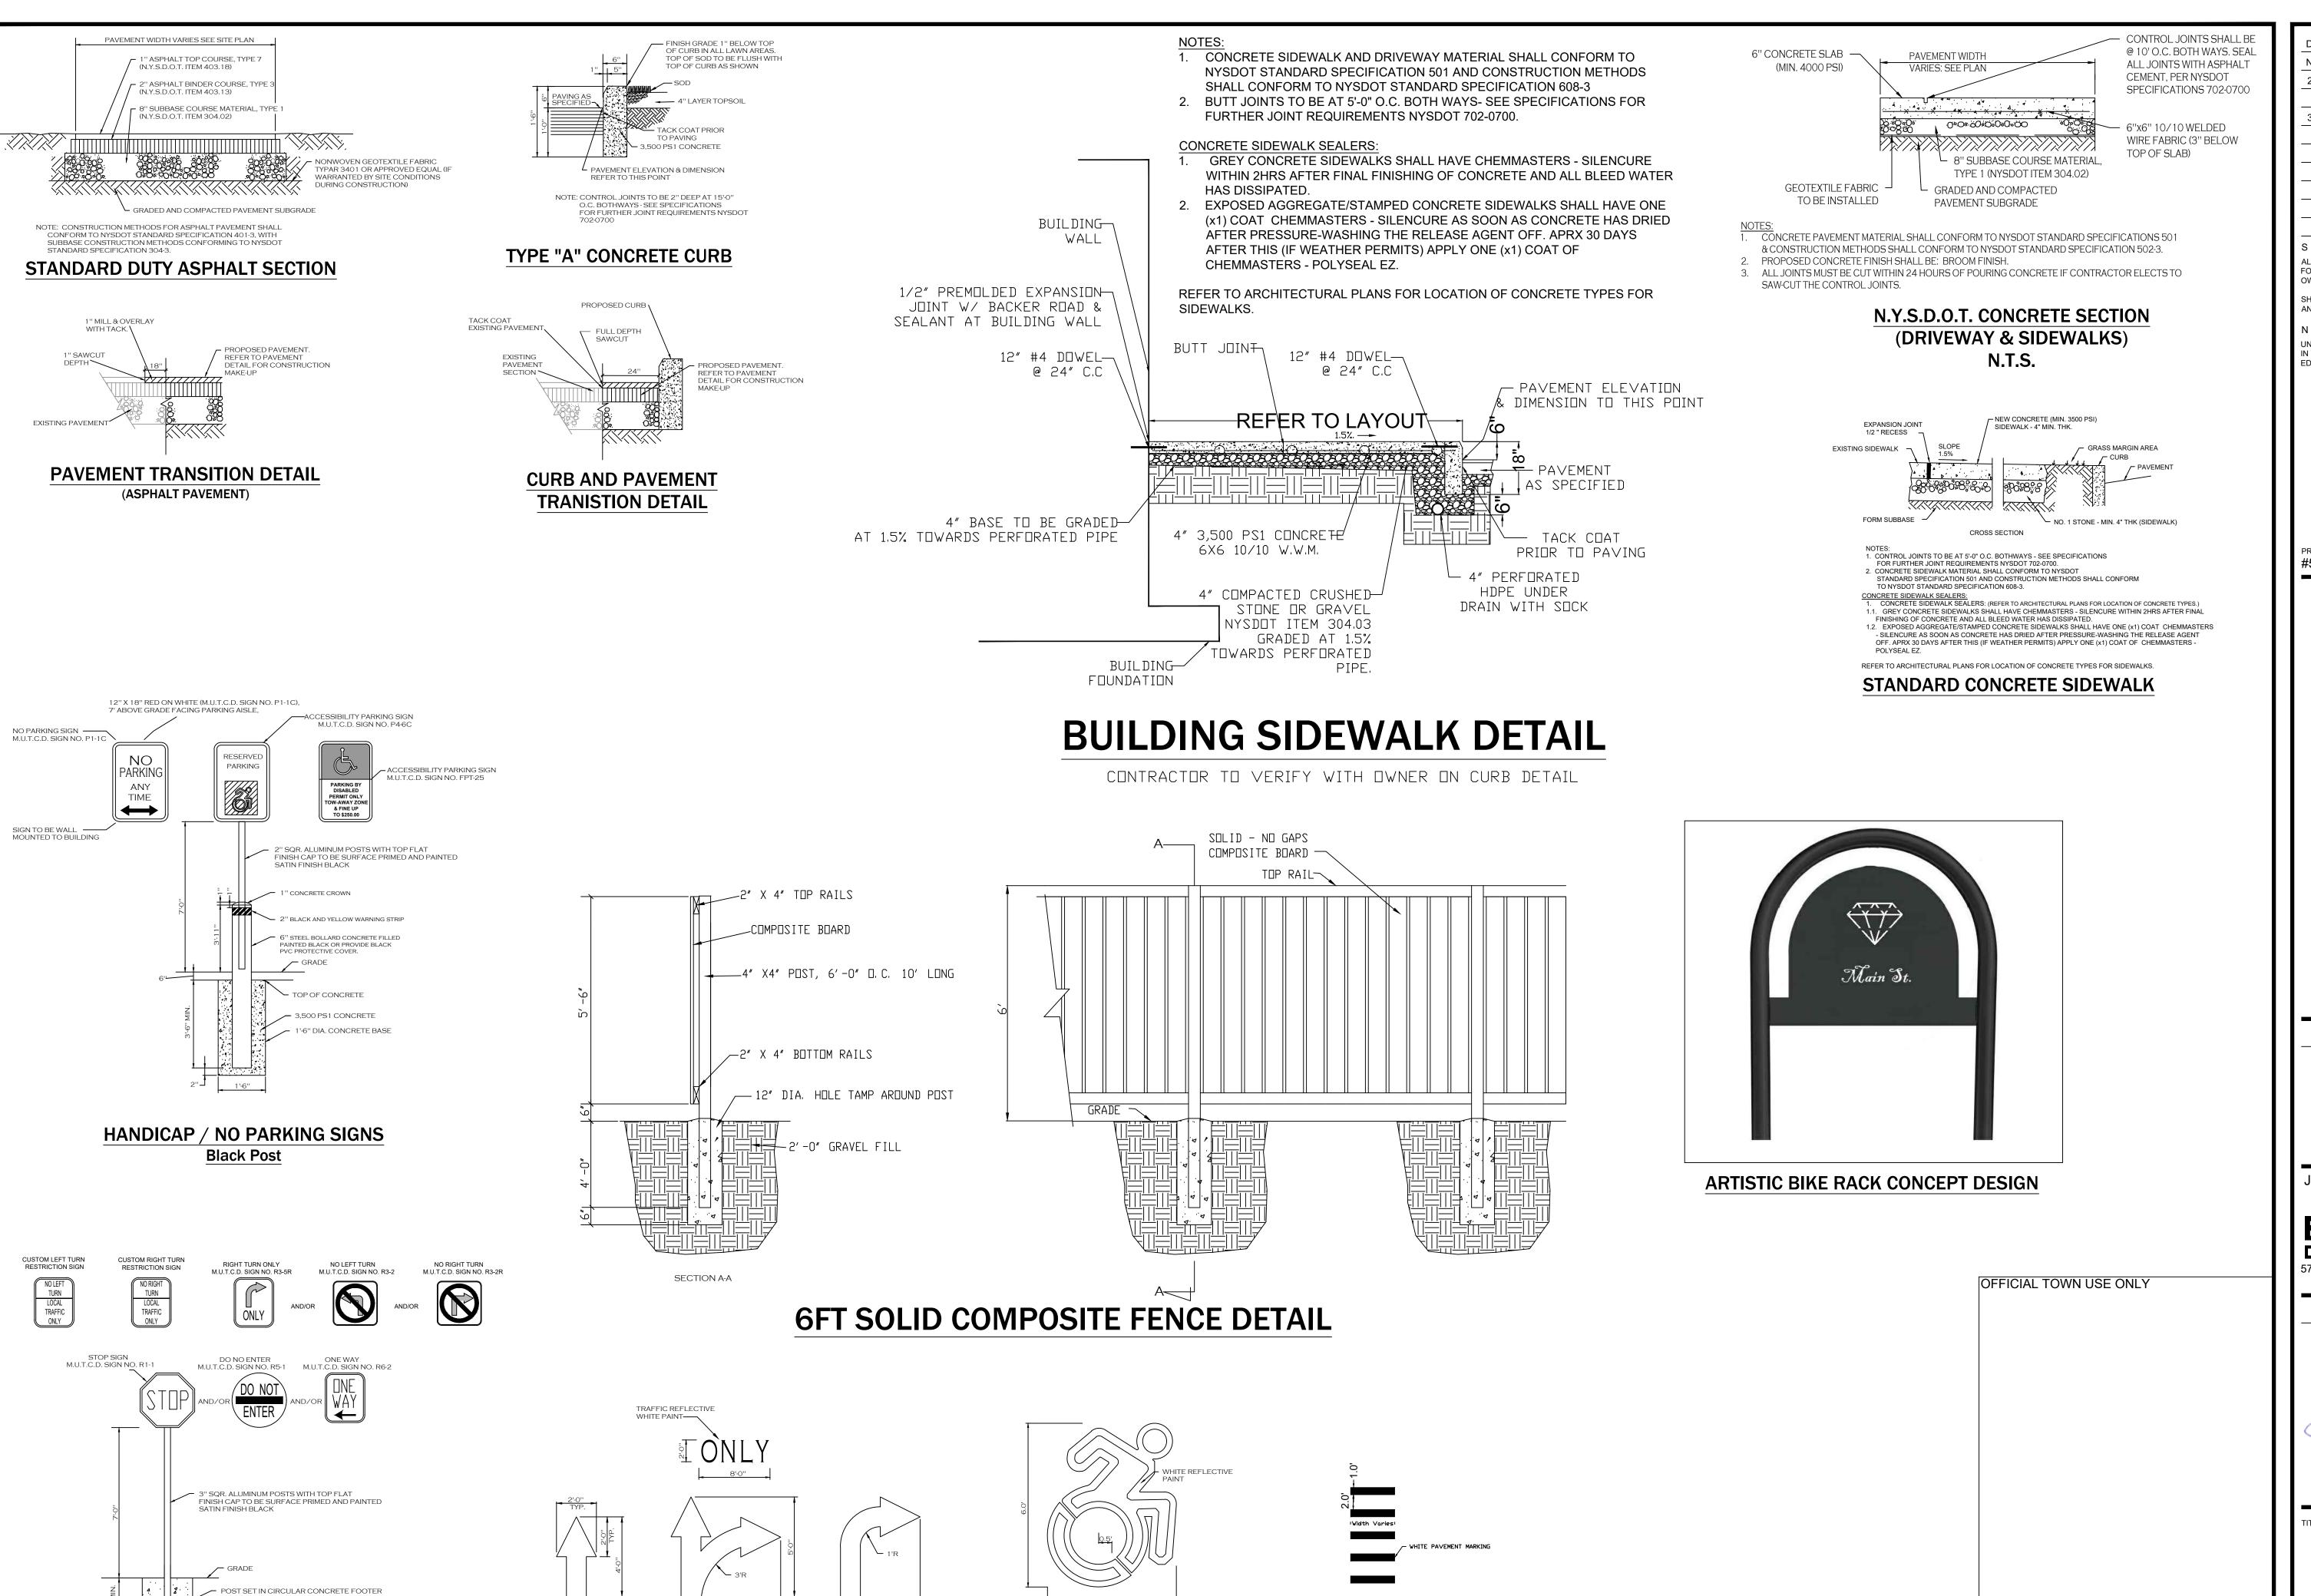

INTERNATIONAL ACCESSIBILITY

SYMBOL

PAINTED TRAFFIC ARROWS

"STOP" / "NO ENTRY" / "ONE WAY" SIGNS

Black Post and Footer

PEDESTRIAN CROSSWALK

DRAWING REVISIONS:

No. DATE BY REMARKS

2 05.27.2025 DZ Coordination Notes

and Town Comments

3 06.04.2025 DZ Town Meeting Update

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CONSTRUCTION SET





AREA:

S

0

0

PROPERTY NUMBER: #5202

st - Snyder 564 Main St. st, NY14226

CONSULTANT

JAMES ALLEN RUMSEY

BENDERSON
DE VELOPMEN
570 DELAWARE AVE., BUFFALO, NY 142

(716) 886-0211 SEAL




TTI E.

Construction Details

SCALE: NTS DRAWN BY:

04.16.2025

C4.2

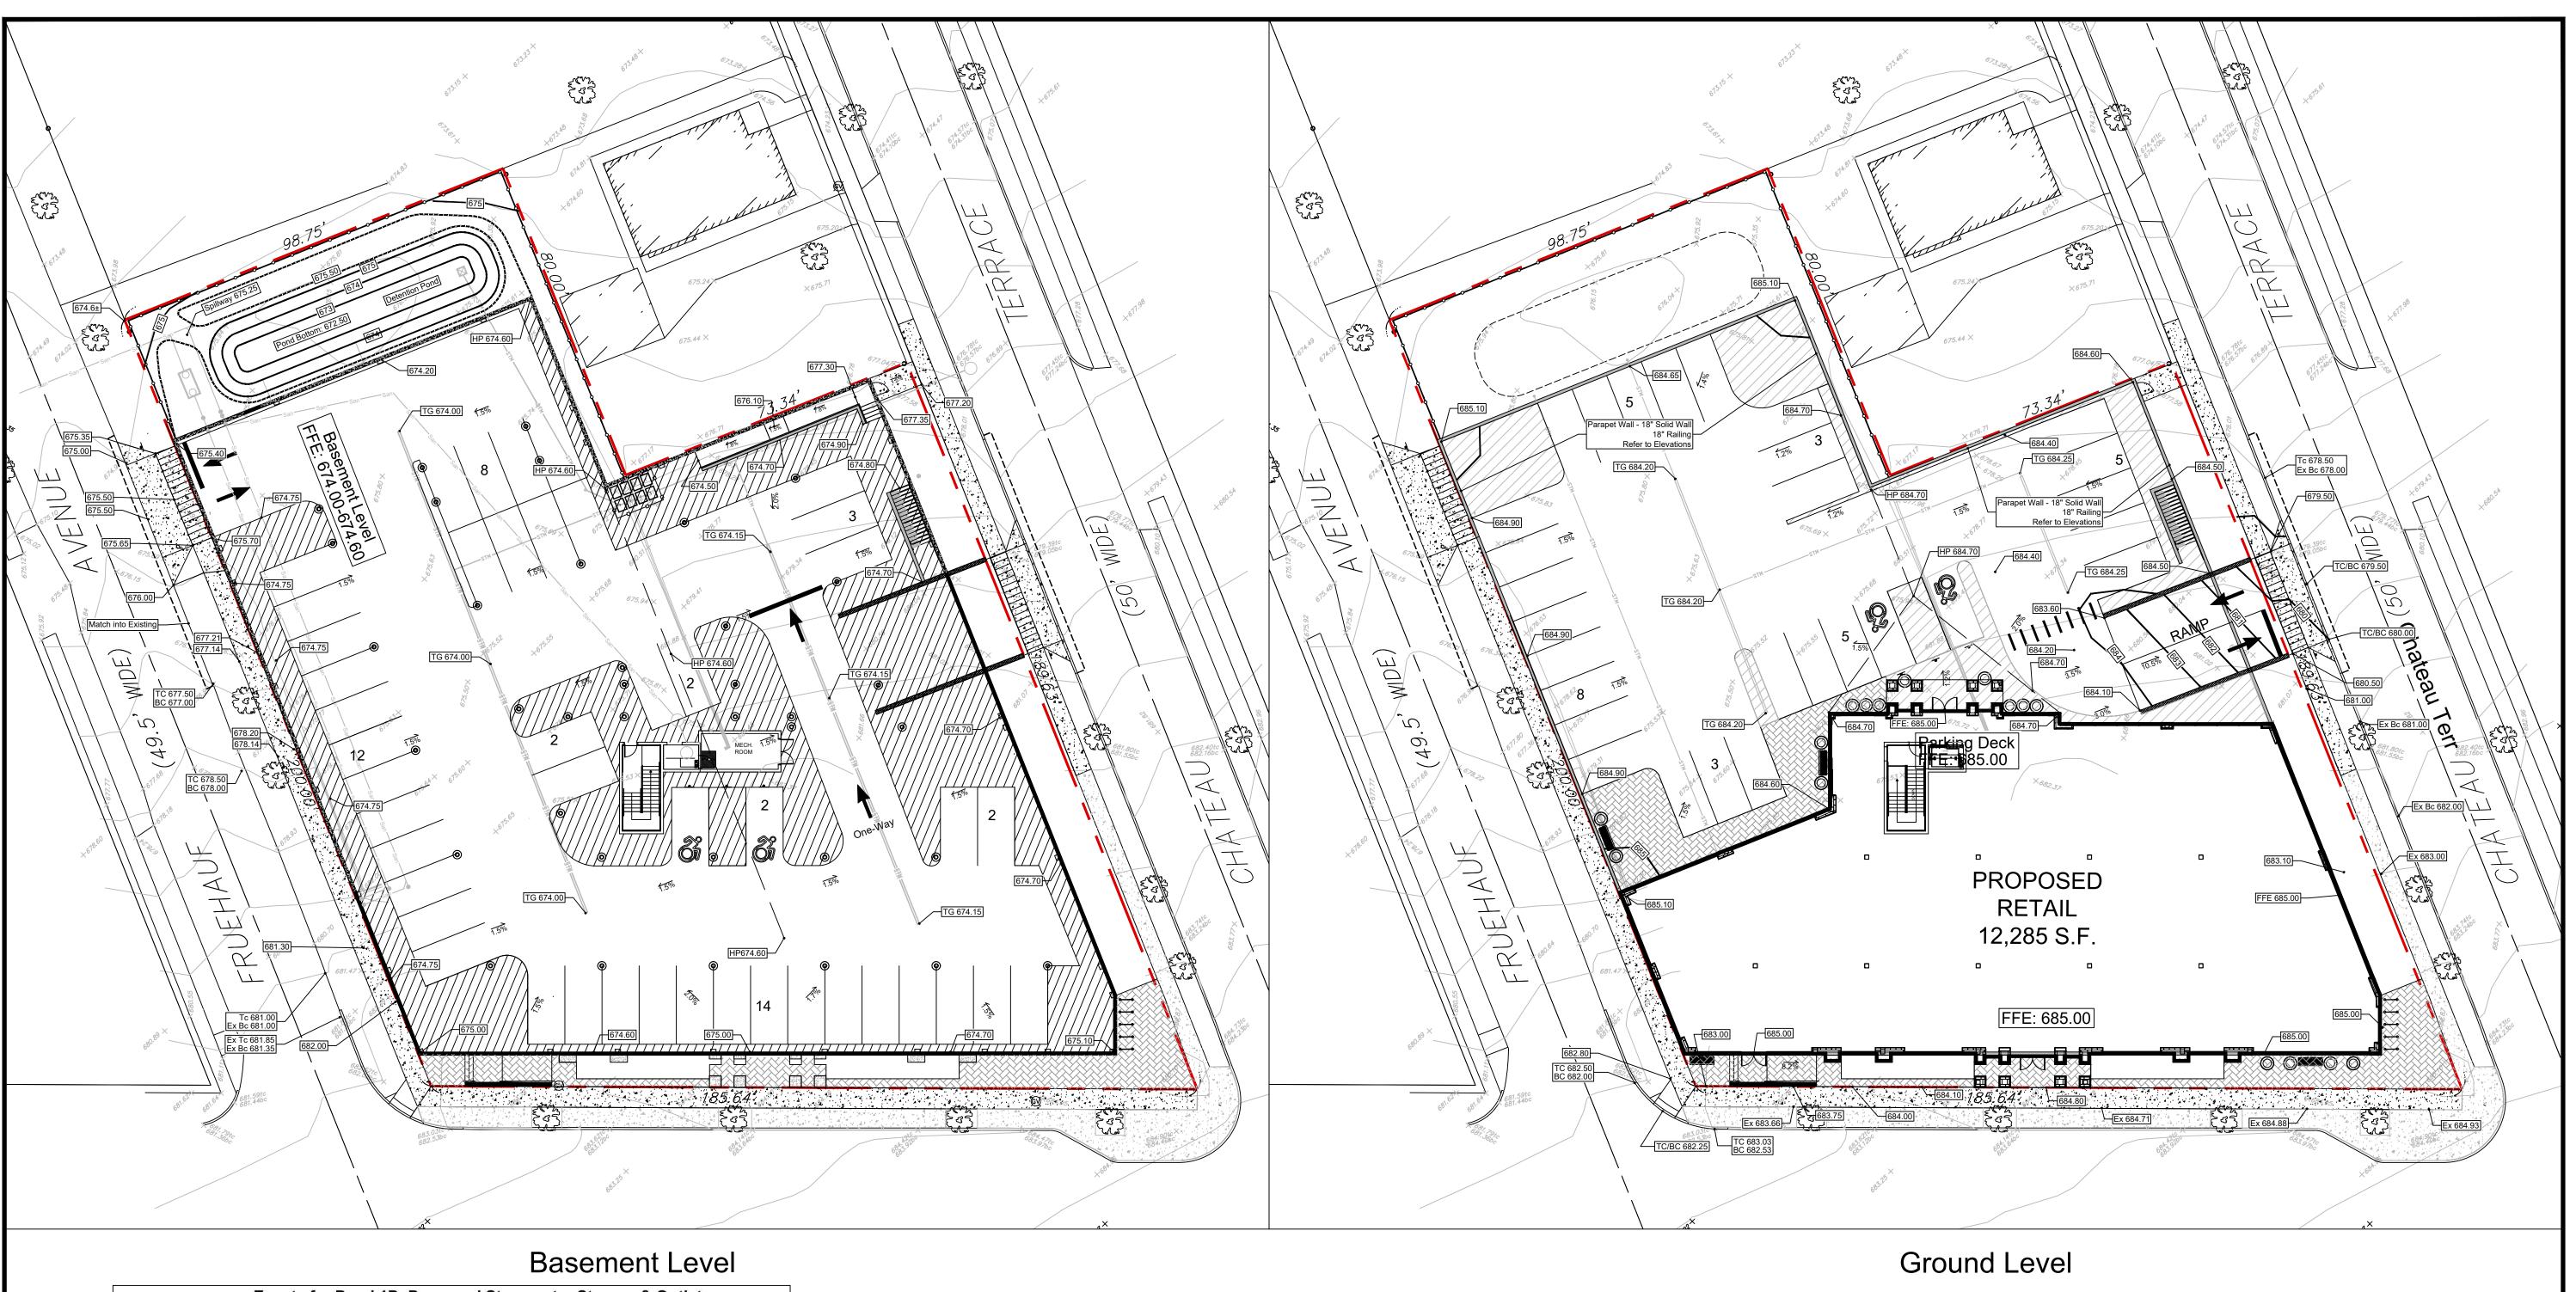

Fnd. Pipe

On Line & 0.6 W.

/674.90

674.70

Basement

Pedestrian Ramp


Scale 1" = 10'

674.80

677.30

Events for Pond 1P: Proposed Stormwater Storage & Outlet Primary Secondary Elevation Storage (cubic-feet) 1.71 0.87 0.00 1-Year 673.58 0.00 673.92 722 2-Year 2.64 1.01 1.01 0.00 674.32 1,075 5-Year 674.64 1,419 0.00 10-Year 1.14 0.00 675.08 1,977 25-Year 675.35 2,366 2.16 0.98 2,525 100-Year 5.29 2.76 675.46

- INSTALL ALL MATERIALS TO MANUFACTURER'S RECOMMENDATIONS AND BEST STANDARDS OF TRADE INVOLVED.
- . SUBSTITUTIONS SHALL BE MADE ONLY WITH OWNER'S APPROVAL AND BE OF EQUIVALENT QUALITY TO WHAT IS SPECIFIED.
- WORK SHALL BE COMPLETED IN STRICT ACCORDANCE WITH ALL LOCAL CODES AND OSHA SAFETY RULES AND REGULATIONS. CONTRACTOR SHALL VERIFY ALL EXISTING CONDITIONS AND DIMENSIONS AT THE SITE. NOTIFY OWNER & ENGINEER OF DISCREPANCIES IN
- CONDITIONS SHOWN ON DRAWINGS PRIOR TO PROCEEDING WITH THE WORK. 5. CONTRACTOR SHALL BE RESPONSIBLE FOR PROTECTION OF ANY EXISTING STRUCTURES TO REMAIN AND ANY FINISH MATERIAL INSTALLED WHILE WORKING ON OTHER COMPONENTS.
- 6. CONTRACTOR SHALL KEEP JOB FREE OF DEBRIS AND MAKE FINAL CLEANUP TO THE SATISFACTION OF OWNER. CONTRACTOR SHALL ASCERTAIN THE LOCATION OF ALL UTILITIES PRIOR TO CONSTRUCTION SO THAT THIS WORK WILL NOT DISTURB EXISTING
- LINES AND/OR INSTALLATIONS EXCEPT AS DETAILED ON THE PLANS. COORDINATE ALL WORK WITH THE APPLICABLE UTILITY COMPANIES.
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THAT SIDEWALK SLOPE DOES NOT

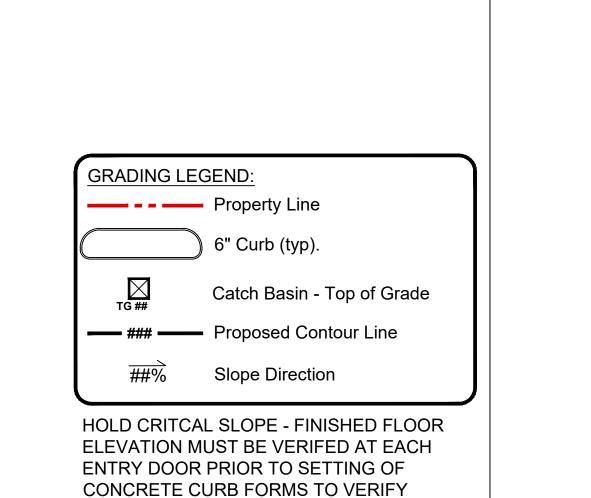EXCEED 1.5%.

OFFICIAL TOWN USE ONLY

Know wha Call PROPERTY NUMBER: #5202	t's below. before you dig. AREA:
Main St - Snyder 4548-4564 Main St. Amherst, NY14226	PROPOSED RETAIL
CONSULTA	ANT
JAMES ALLEN ARCHITEC PREPARED FOR BENDER DEVELOP 570 DELAWARE AVE., BUF (716) 886-02	RSON MENT FALO, NY 14202 I1
STERED ARCHIT	ici de la constant de
TITLE: Gradin Plan SCALE: 1" = 20' DRAWING NO	

DMZ

MAO
DATE:
04.16.2025

DRAWING REVISIONS:

DATE BY REMARKS 04.29.2025 DZ Arch Updates

07.14.2025 DZ Site Updates 08.20.2025 DZ Site Updates

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AND ALL STRUCTURES.

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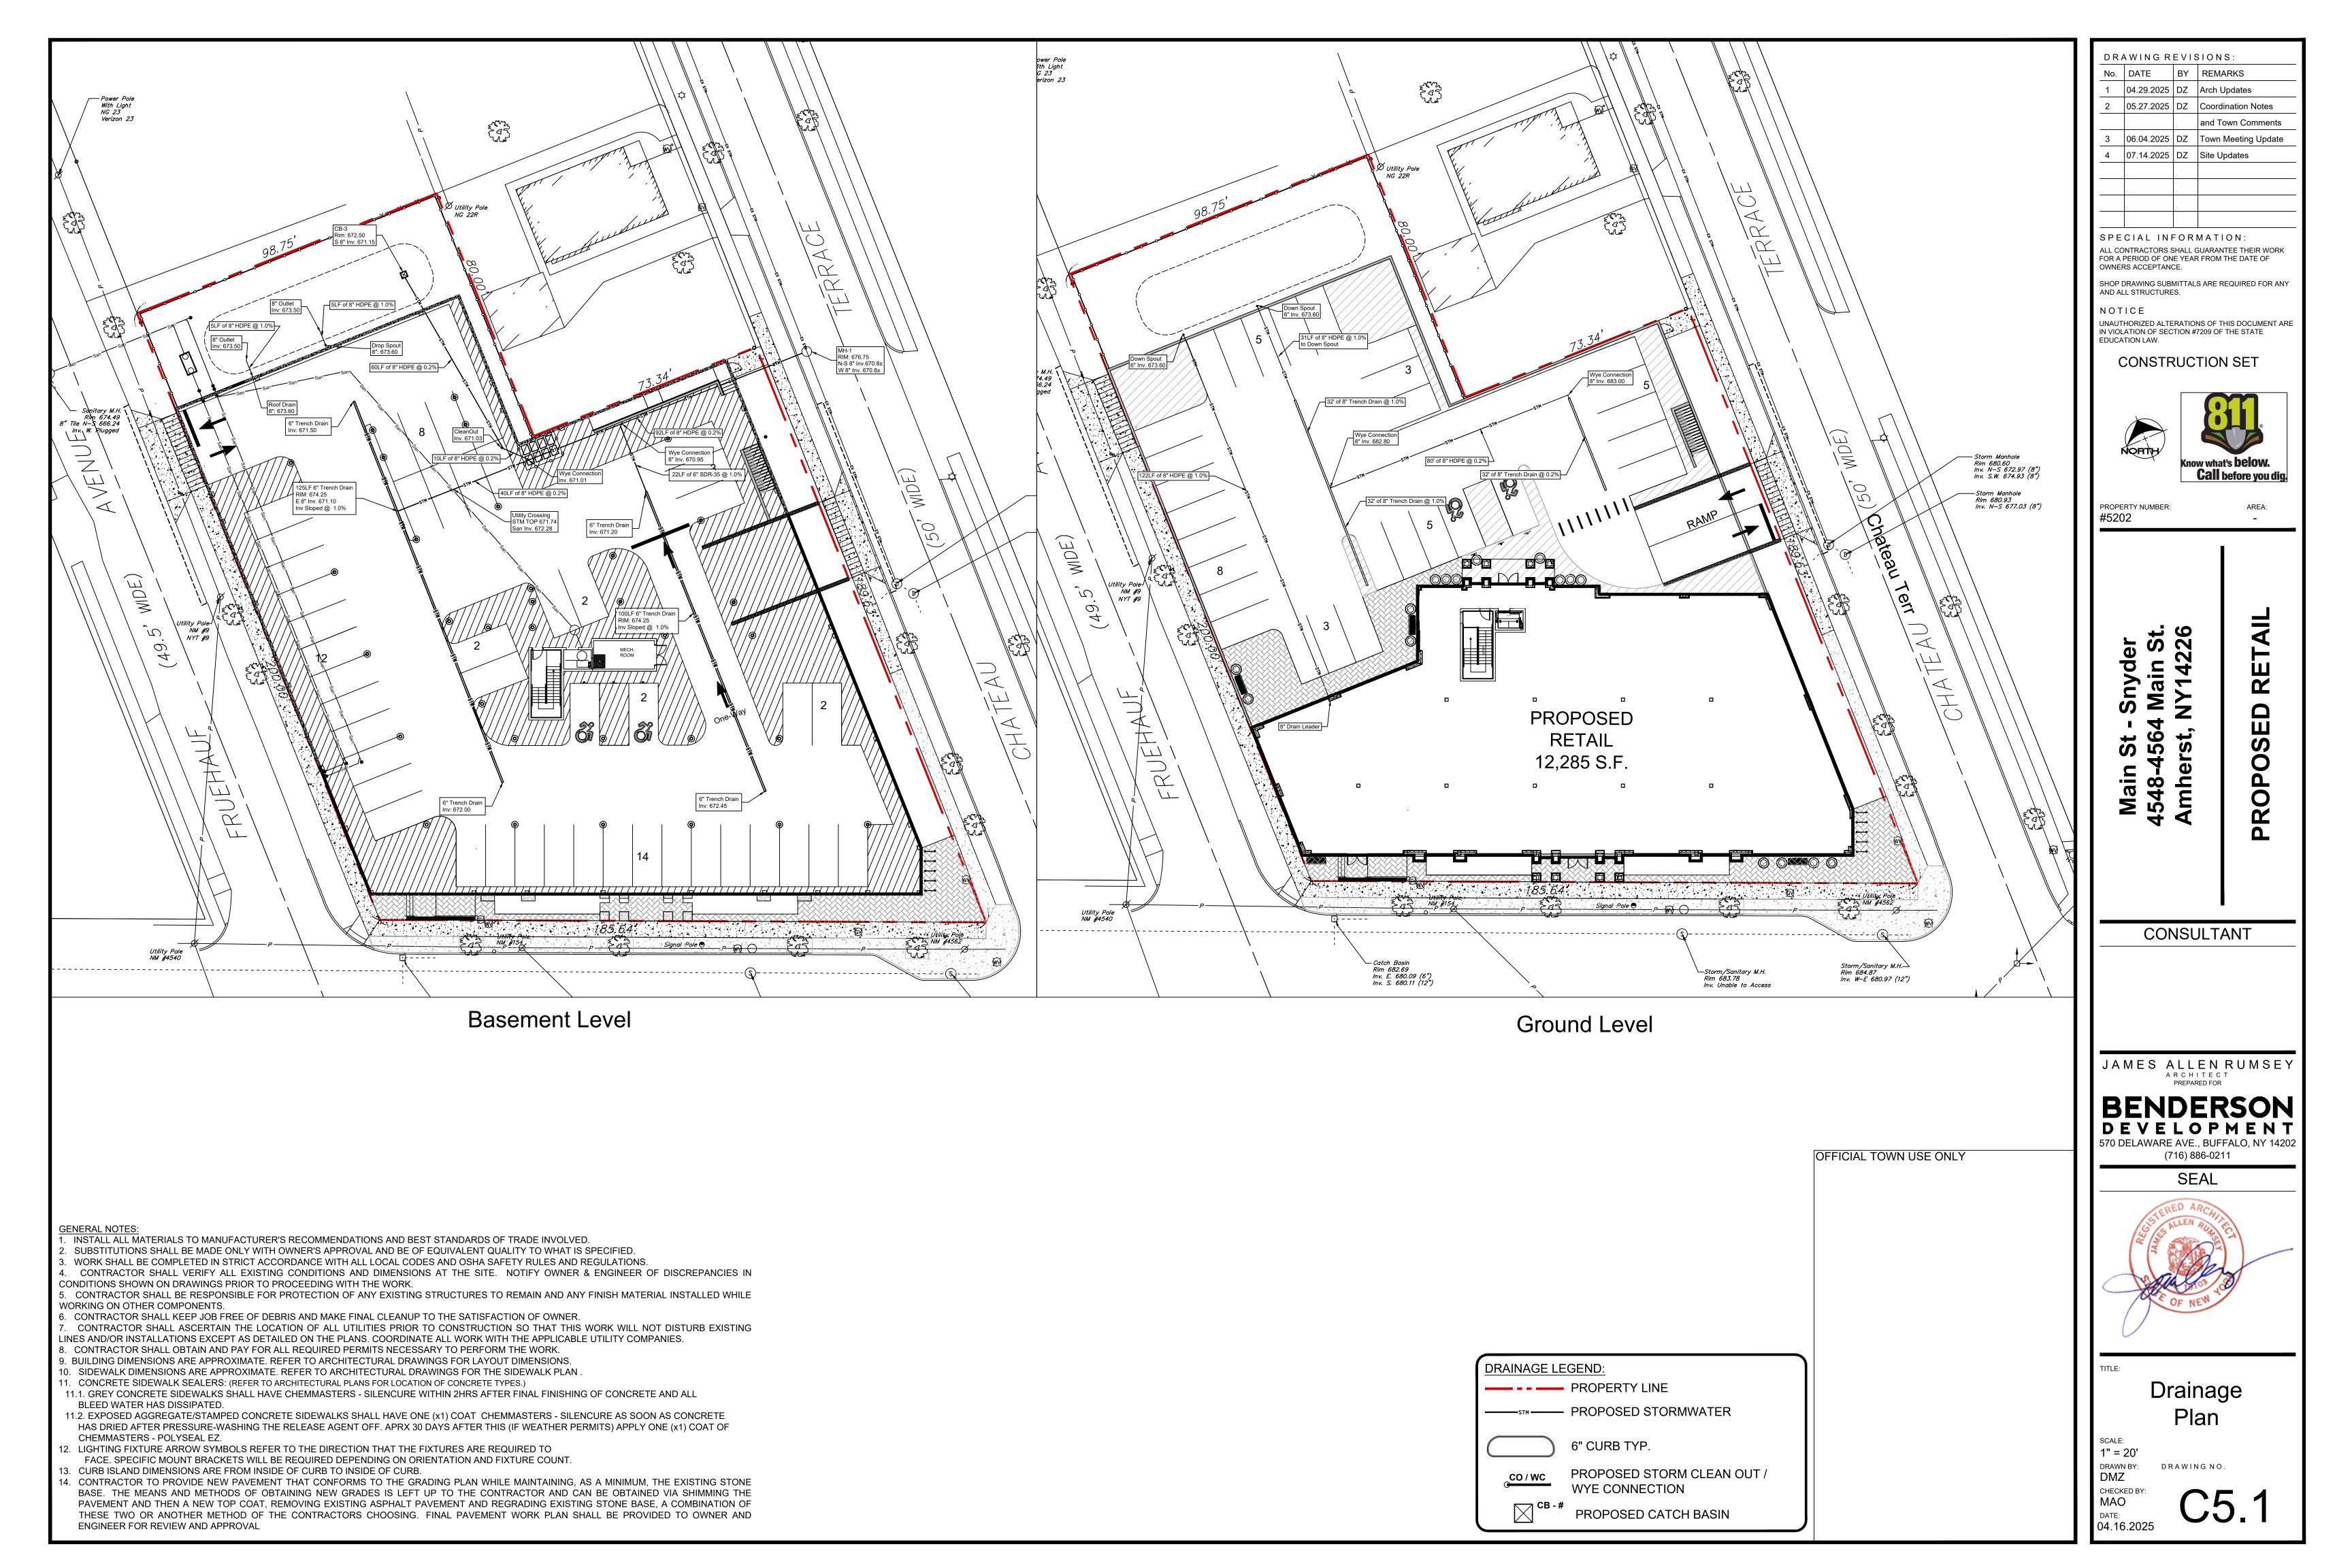
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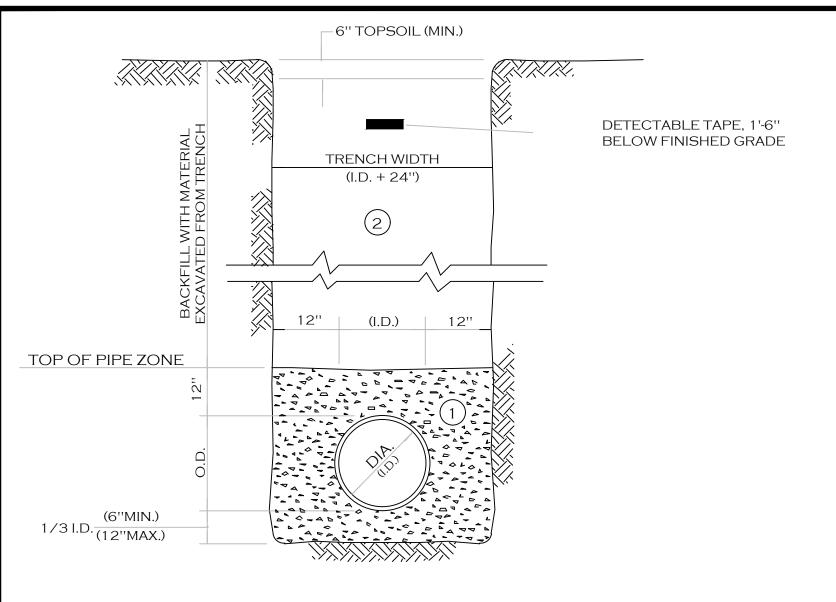
CONSTRUCTION SET

05.27.2025 DZ Coordination Notes

06.04.2025 DZ Town Meeting Update

and Town Comments





- A. PIPE INSTALLATION SHALL BE IN ACCORDANCE WITH MANUFACTURERS RECOMMENDATIONS.
- B. TRENCHING OPERATIONS SHALL INCLUDE ALL NECESSARY DEWATERING.
- C. TRENCH DETAILS ARE ONLY SHOWN FOR PURPOSES OF MATERIAL PLACEMENT AND MAXIMUM PAY LIMITS.
- D. AN OSHA APPROVED MOVABLE PROTECTIVE TRENCH SHIELD SHALL BE USED IN ALL UNSHEETED TRENCH AREAS.

MATERIALS


PIPE BEDDING MATERIAL (NYSDOT 1985 EDITION)

NO. 1 CRUSHED STONE OR CRUSHED GRAVEL WITH A GRADATION CONFORMING WITH NYSDOT SECTION 703-02. THE MATERIAL SHALL BE WELL GRADED WITH NO PARTICLES LARGER THAN ONE INCH AND HAVING A MAXIMUM GRADATION MEETING THE LIMITS DESCRIBED IN THE SPECIFICATIONS. THE BEDDING SHALL BE COMPACTED IN 6" LIFTS WITH EQUIPMENT ACCEPTABLE TO THE PIPE MANUFACTURER.


NO SLAG SHALL BE ALLOWED FOR MATERIAL (1)

2 BACKFILL MALL..... COMPACTED IN 6" LIFTS. BACKFILL MATERIAL SHALL BE NATIVE SOIL CONTAINING NO UNSUITABLE MATERIAL


TRENCH SECTION IN UNPAVED AREAS

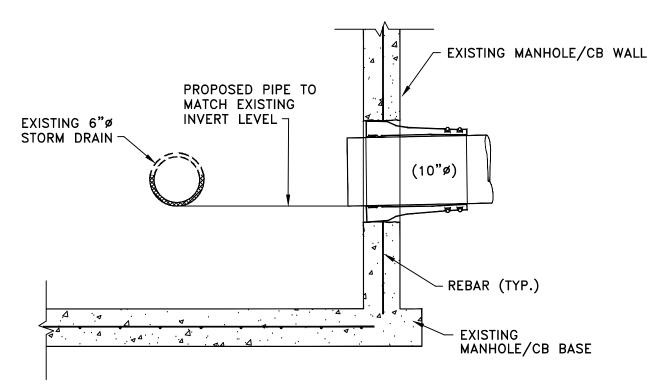

- 1. CORE DRILL ENTRANCE HOLE IN PRECAST MANHOLE BARREL, BASE AND/OR BENCH FOR REQUIRED PIPE CLEARANCE. PER MANUFACTURERS RECOMMENDATIONS.
- 2. DOES NOT APPLY TO HOUSE LATERALS.
- 3. WATERTIGHT PIPE TO MANHOLE BOOT SEAL REQUIRED FOR ALL CORE DRILLED ENTRANCE HOLES IN MANHOLE BARREL AS SHOWN BELOW.

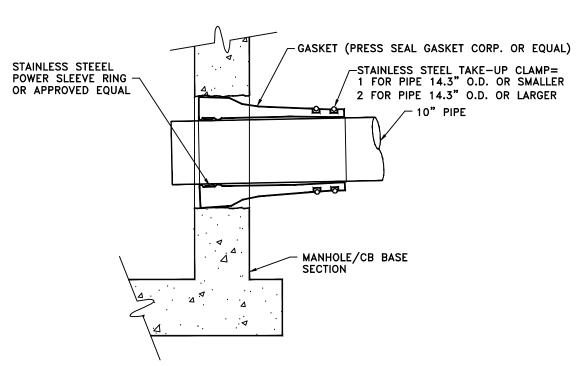

CONNECTION TO EXISTING MANHOLE/CB

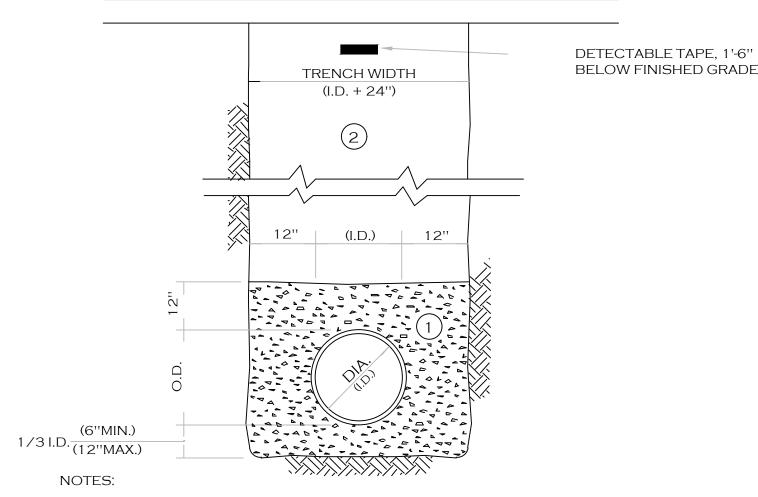

- A. PIPE INSTALLATION SHALL BE IN ACCORDANCE WITH MANUFACTURERS RECOMMENDATIONS.
- B. TRENCHING OPERATIONS SHALL INCLUDE ALL NECESSARY DEWATERING.
- C. TRENCH DETAILS ARE ONLY SHOWN FOR PURPOSES OF MATERIAL PLACEMENT AND MAXIMUM PAY LIMITS.
- D. AN OSHA APPROVED MOVABLE PROTECTIVE TRENCH SHIELD SHALL BE USED IN ALL UNSHEETED TRENCH AREAS.

MATERIALS

PIPE BEDDING MATERIAL (NYSDOT 1985 EDITION)


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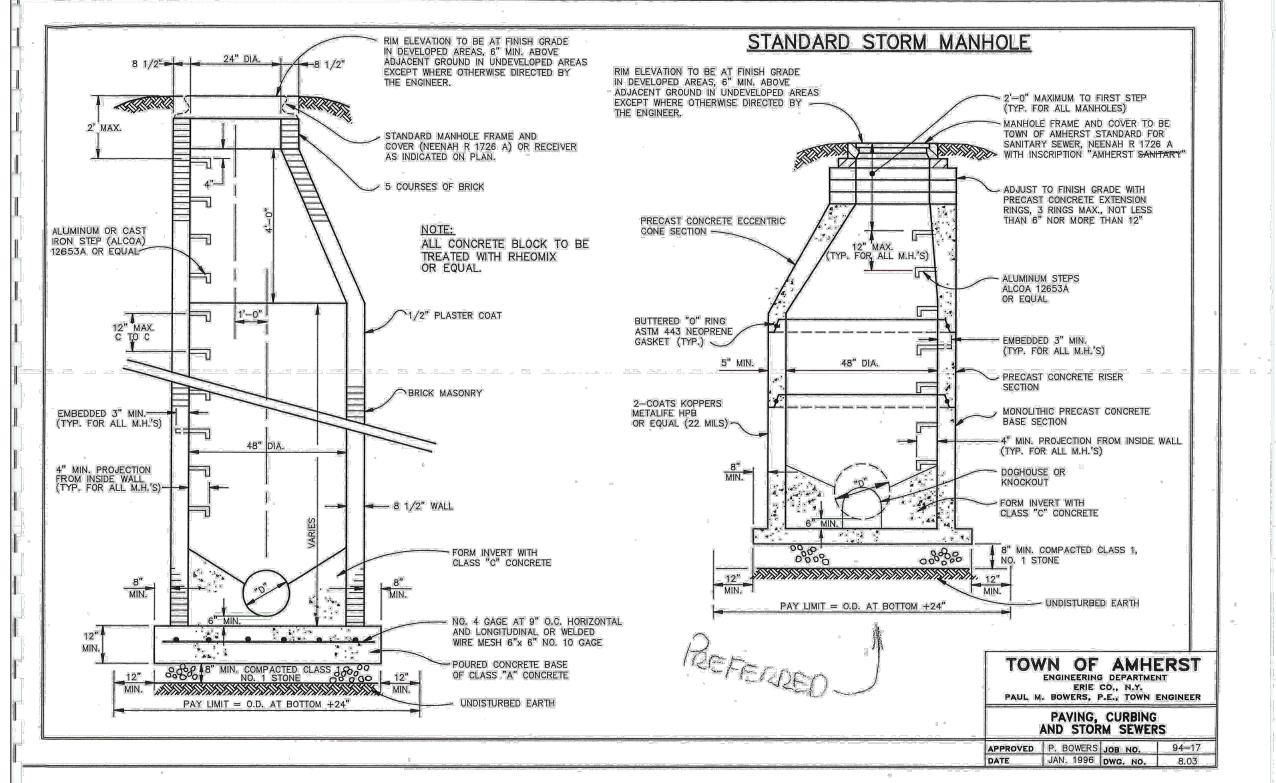
NO SLAG SHALL BE ALLOWED FOR MATERIAL (1)

TYPE 2 CRUSHED STONE OR CRUSHED GRAVEL WITH A GRADATION CONFORMING WITH NYSDOT SECTION 304-2.02 TYPE 2. THE MATERAIL SHALL BE WELL GRADED WITH NO PARTICLES LARGER THAN TWO INCHES AND HAVING A MAXIMUM GRADATION MEETING THE LIMITS DESCRIBED IN THE SPECIFICATIONS. THE BEDDING SHALL BE COMPACTED IN 6" LIFTS WITH EQUIPMENT ACCEPTABLE TO THE PIPE MANUFACTURER.

NO SLAG SHALL BE ALLOWED FOR MATERIAL (2)

TRENCH SECTION IN PAVED AREAS



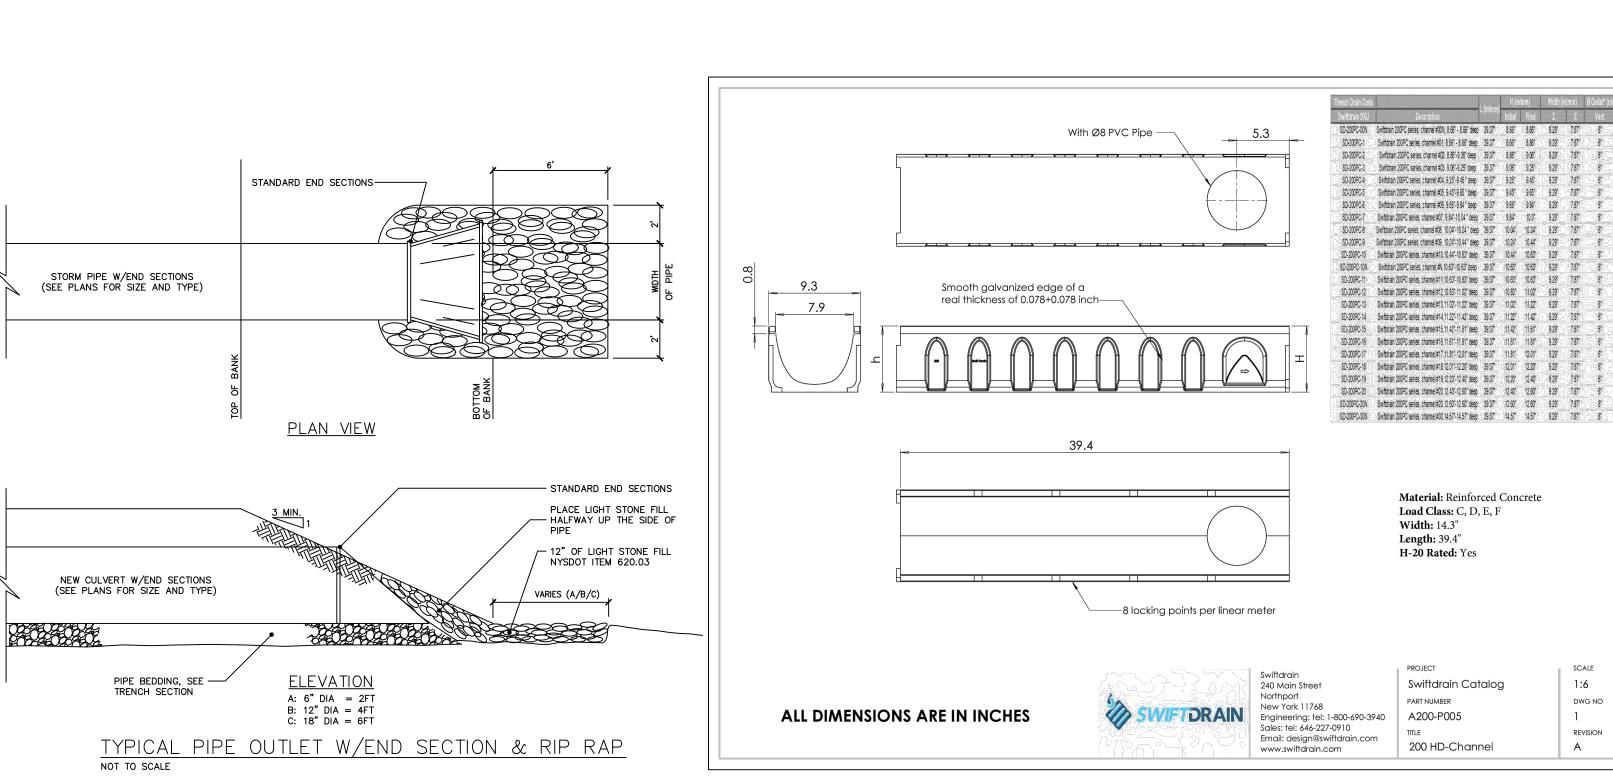

1:6

REVISION

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CONSTRUCTION SET

AND ALL STRUCTURES.



AREA:

Δ.

PROPERTY NUMBER:

#5202

inyder Main St Main (

CONSULTANT

JAMES ALLEN RUMSEY ARCHITECT

570 DELAWARE AVE., BUFFALO, NY 14202 (716) 886-0211

OFFICIAL TOWN USE ONLY

SEAL





Details

NTS DRAWING NO. DRAWN BY: DMZ CHECKED BY MAO

DATE:

04.16.2025

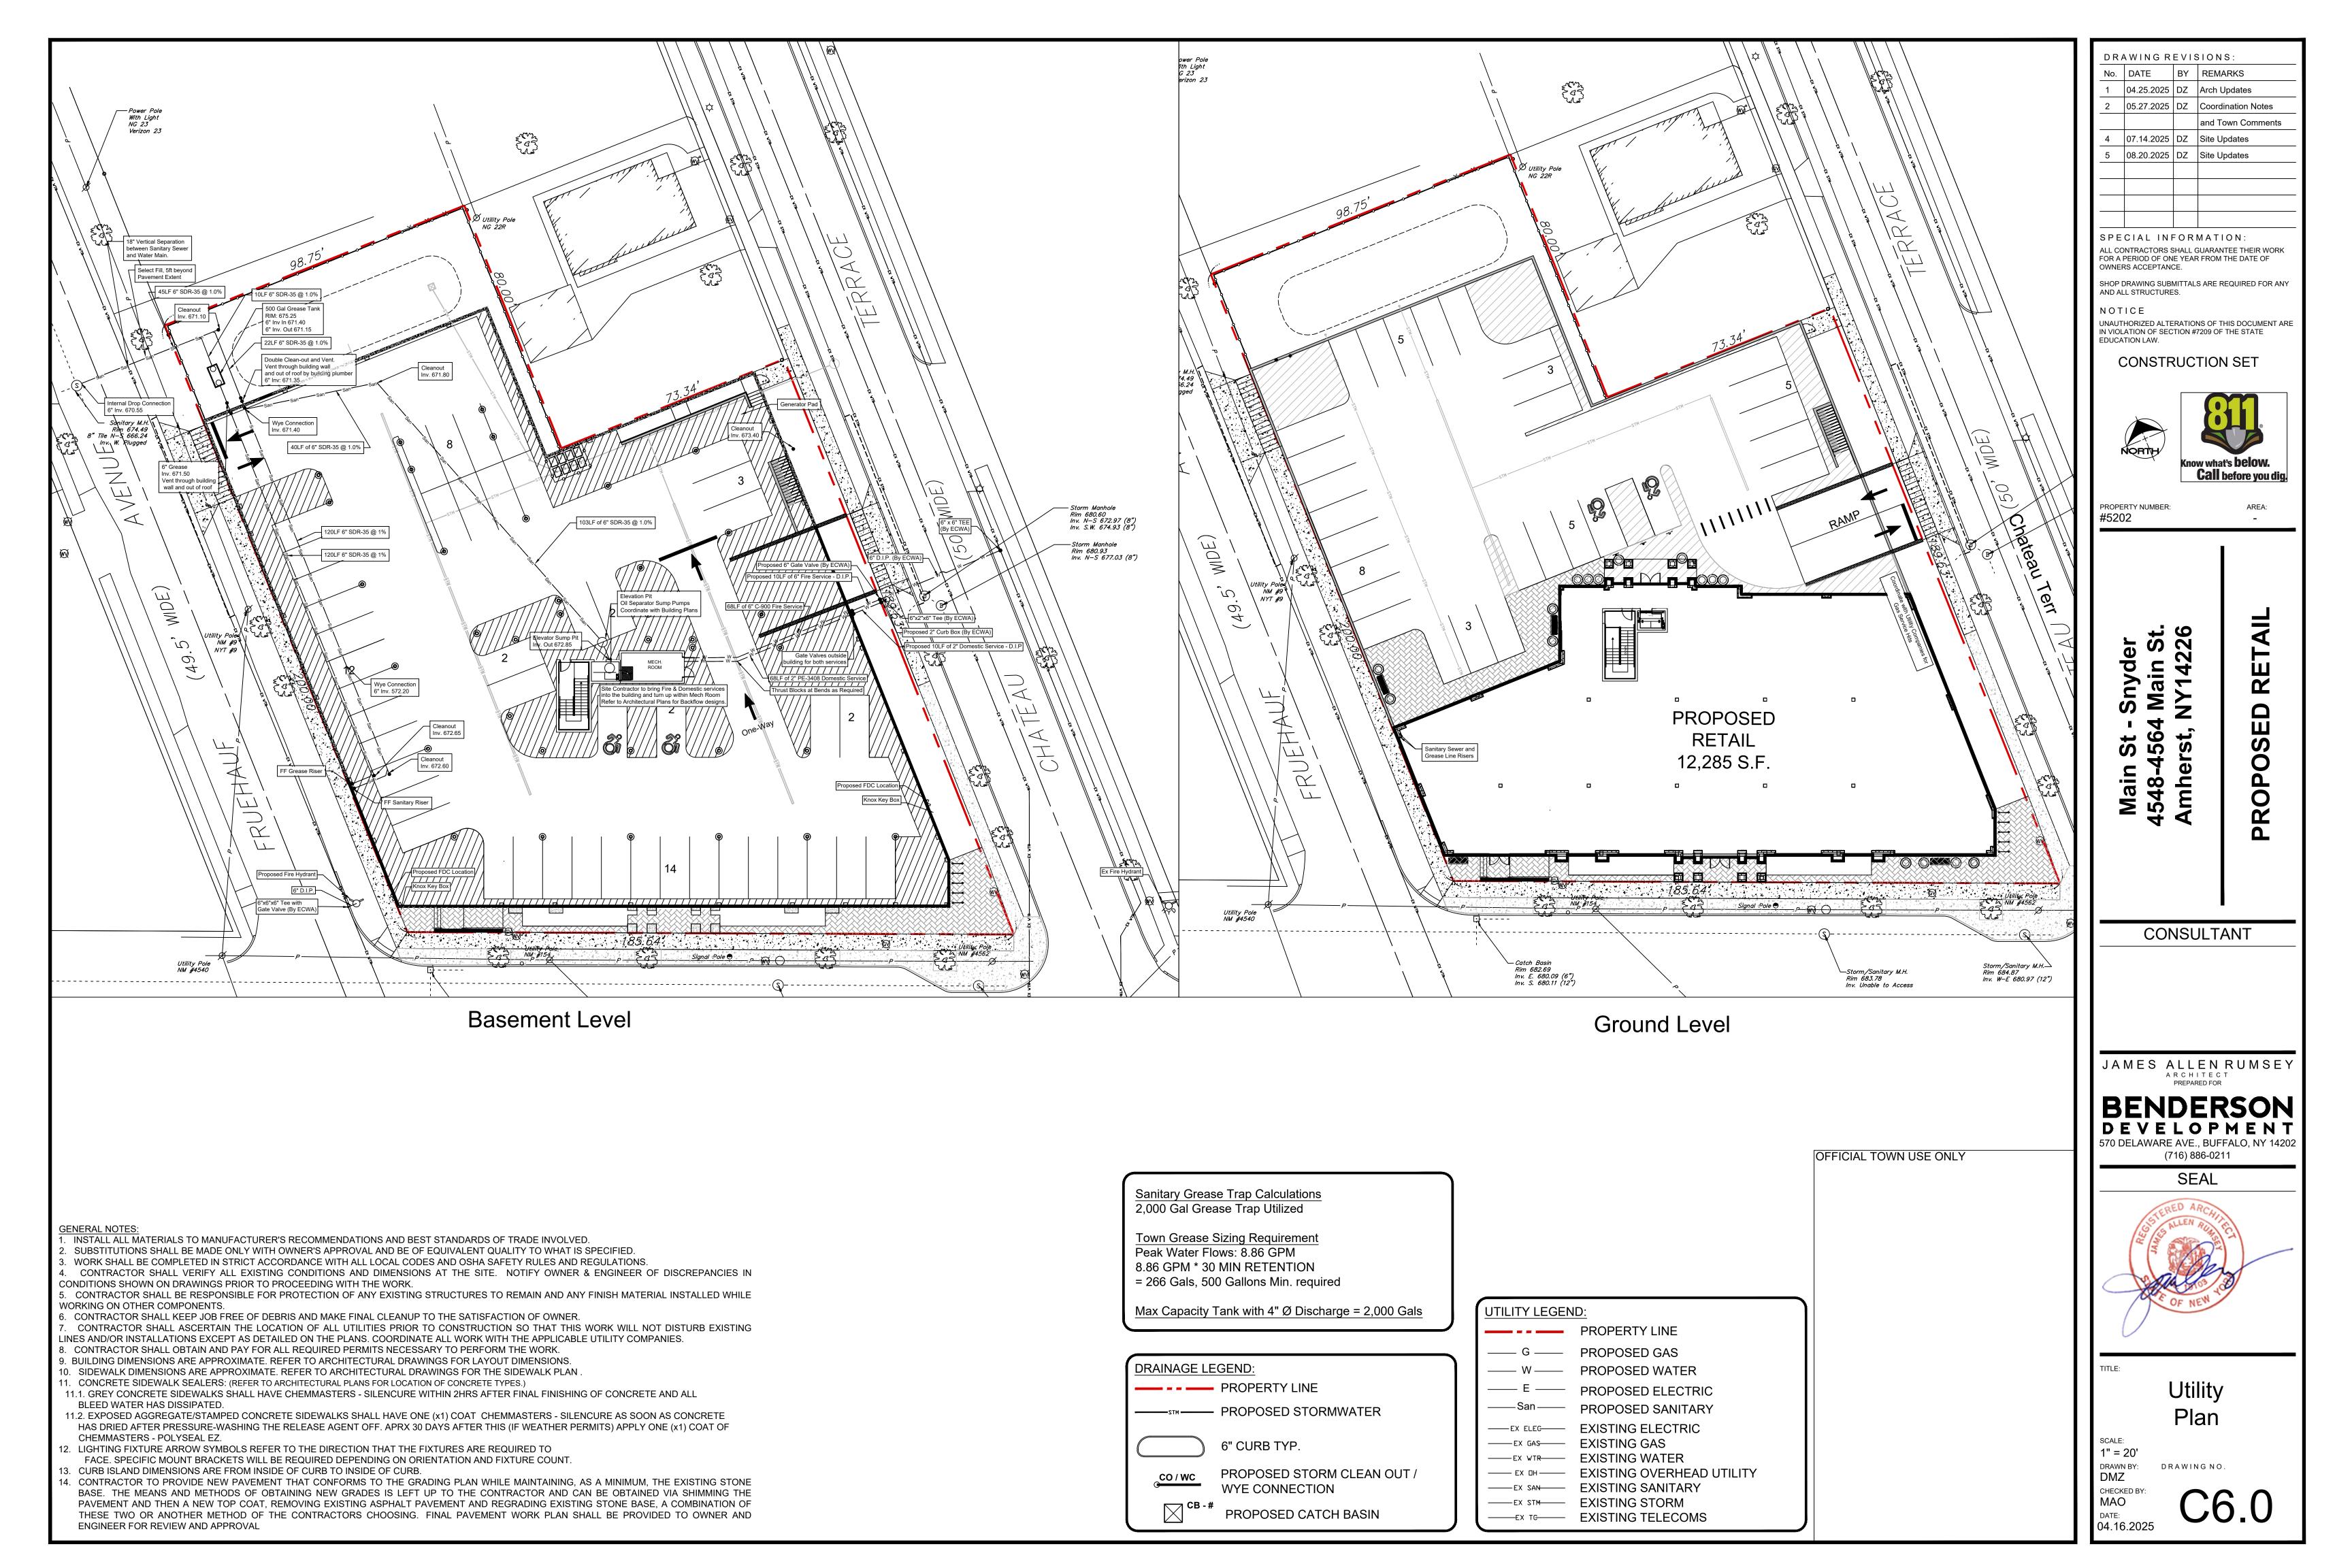

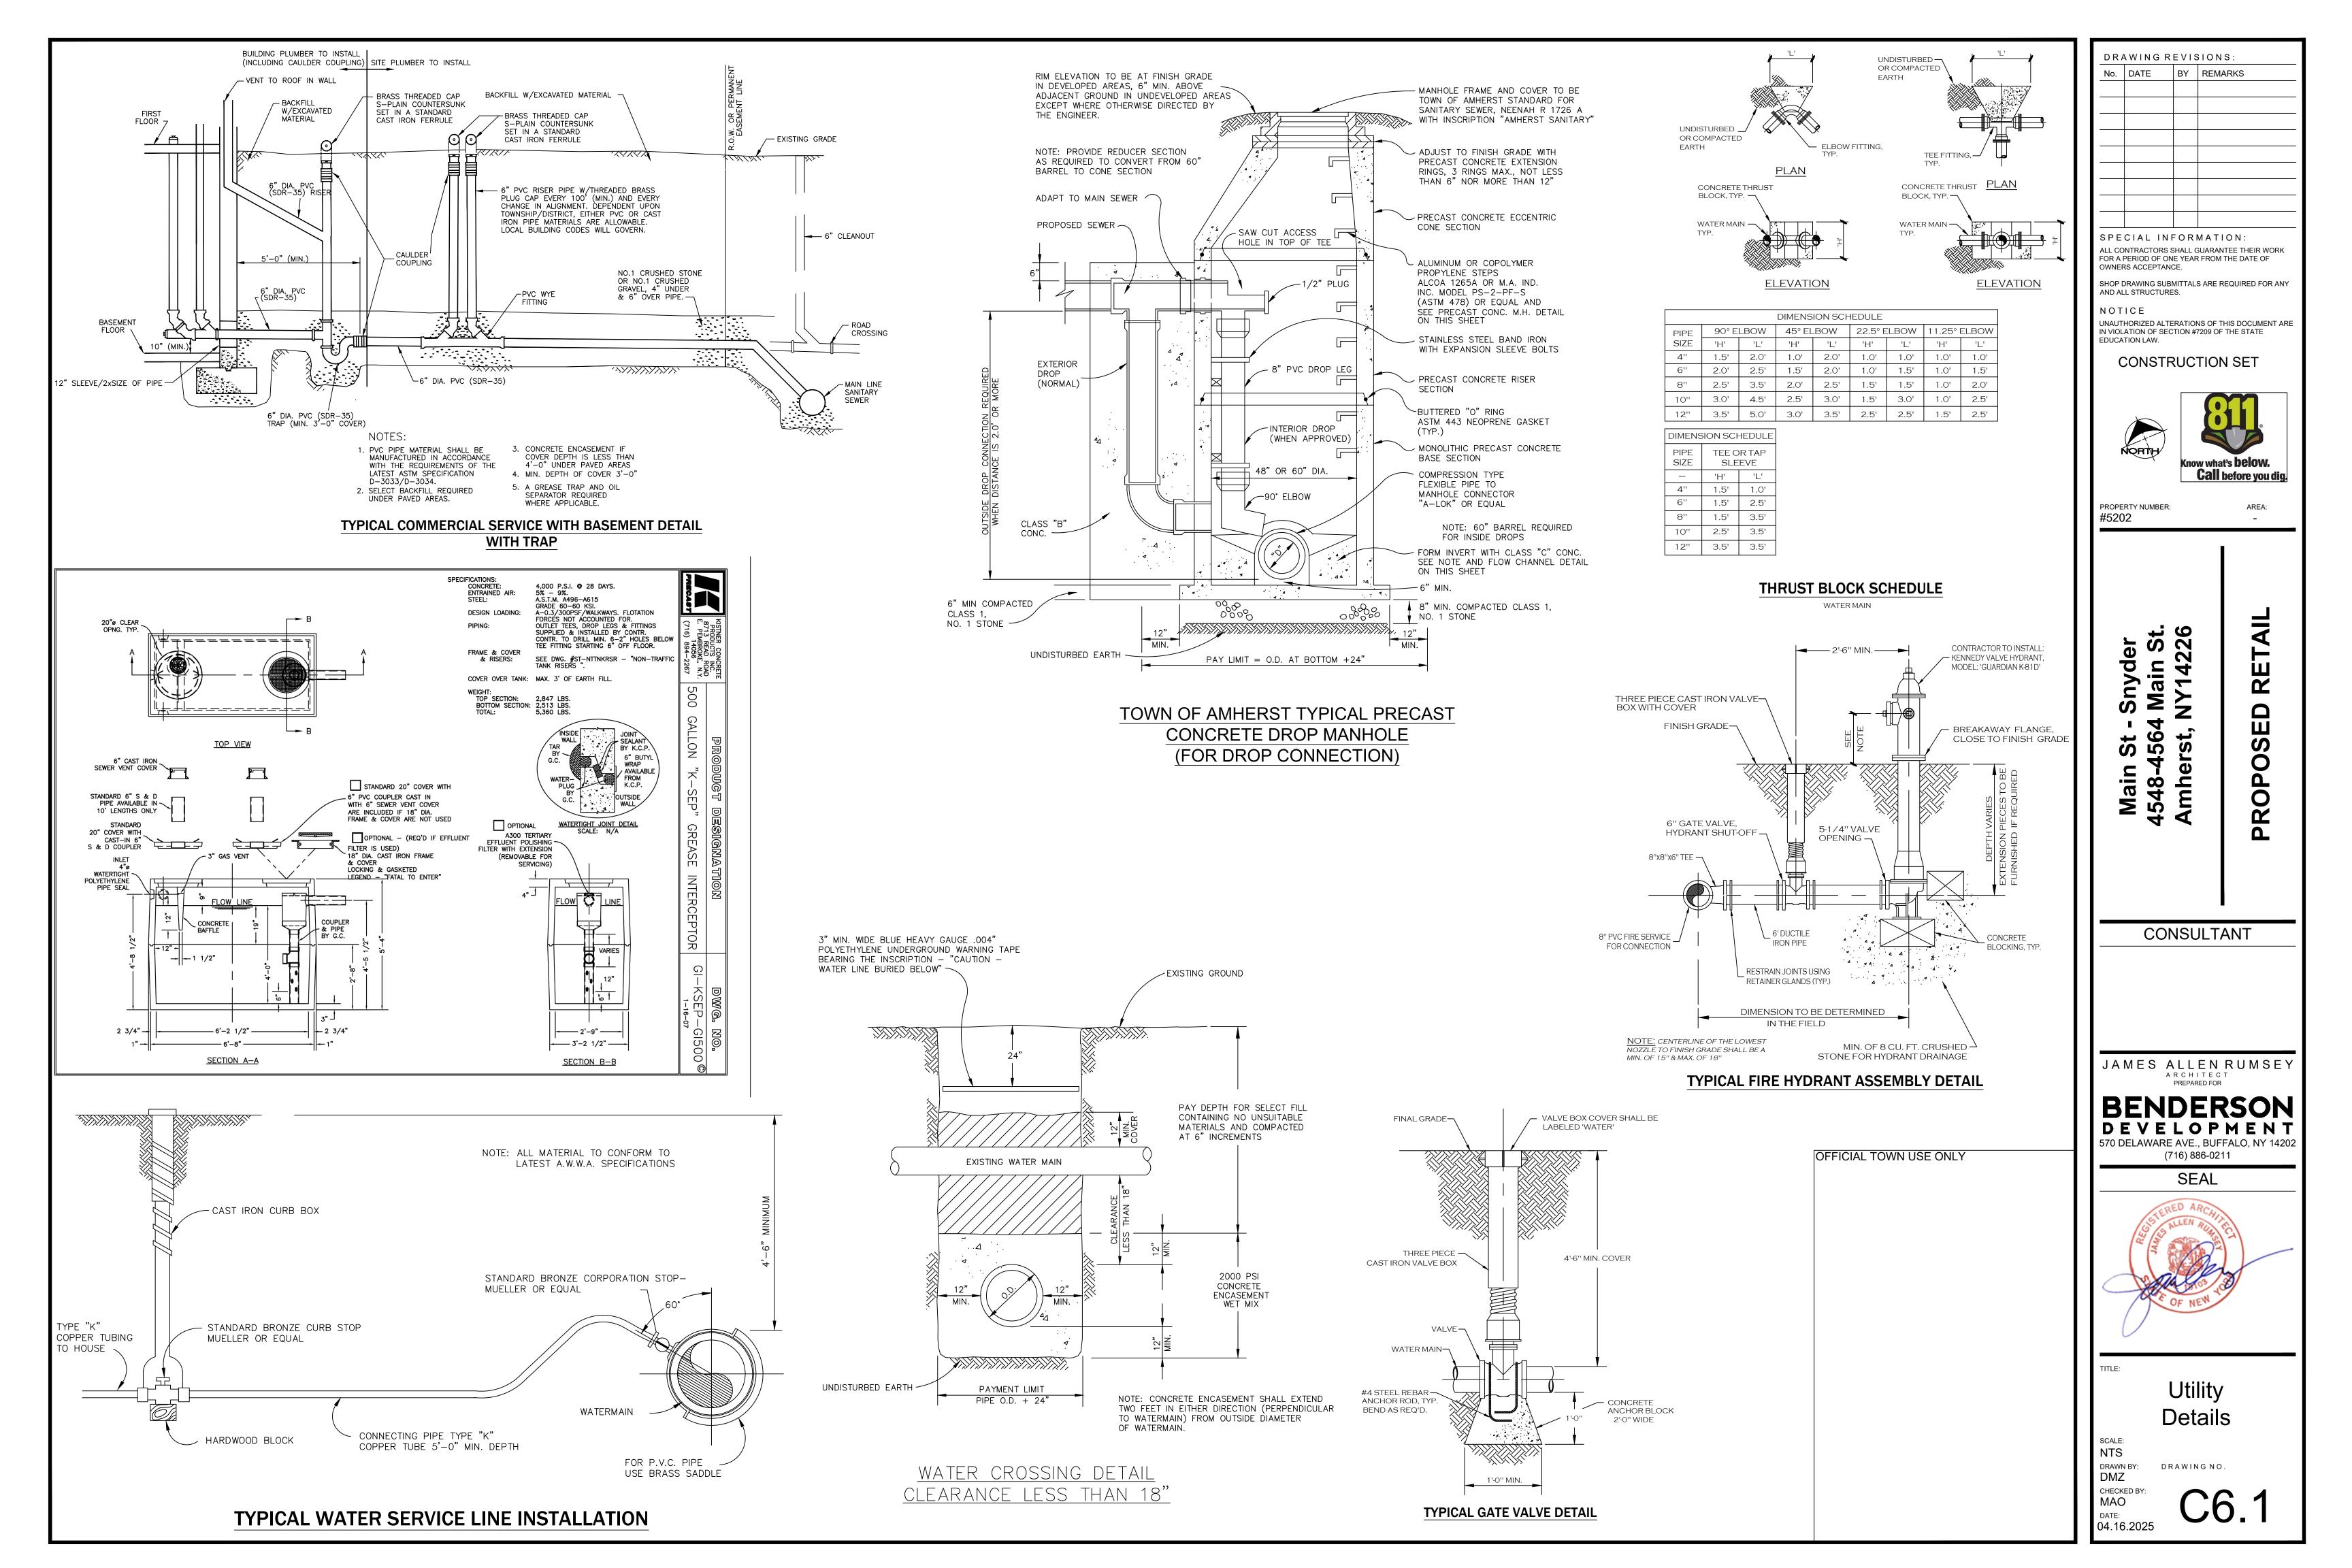

LANDSCAPE NOTES

- 1. LANDSCAPE CONTRACTOR SHALL SECURE CURRENT PLANS AND SPECIFICATIONS FOR PROPER CONSTRUCTION METHODS AND MATERIAL OF ALL LANDSCAPING PRIOR TO COMMENCING WORK.
- 2. ALL PLANTS SHALL MEET OR EXCEED THE MINIMUM REQUIREMENTS AS NOTED IN THE LATEST EDITION OF THE AMERICAN STANDARD FOR NURSERY STOCK, BY THE AMERICAN ASSOCIATION OF NURSERYMEN, ANSI Z60.1 (LATEST
- 3. THE CONTRACTOR SHALL BE RESPONSIBLE FOR HIS OWN QUANTITY TAKEOFF.
- 4. THE CONTRACTOR SHALL PERFORM A ROUGH FIELD STAKEOUT OF ALL PLANT MATERIAL AND SHRUB-BEDS. CONTACT OWNER'S REPRESENTATIVE FOR INSPECTION AND APPROVAL. LOCATIONS SHOWN ON THE PLANS CONVEY DESIGN INTERFECT ONLY. ACTUAL LOCATIONS WILL BE AS DIRECTED BY THE LANDSCAPE ARCHITECT AT THE TIME OF
- 5. THE CONTRACTOR IS HEREBY NOTIFIED THAT UNDERGROUND UTILITIES EXIST. SHOULD LOCATION OF TREES BE WITHIN 5' OF UNDERGROUND UTILITIES, RELOCATE SAID TREES TO A MINIMUM OF 5' FROM BALL TO UTILITIES.
- 6. SHOULD LOCATION OF TREES BE WITHIN 20' OF OVERHEAD WIRES, RELOCATE SAID TREES TO A MINIMUM OF 20'
- 7. ALL TREES AND SHRUBS SHALL RECEIVE A 3" LAYER OF BLACK SHREDDED HARDWOOD BARK MULCH.
- 8. ALL PLANTS MUST BE HARDY UNDER CLIMATE CONDITIONS THAT EXIST AT THE PROJECT SITE AND GROWN AT A NURSERY AT THE SAME HARDINESS ZONE AS THE PROJECT LOCATION.
- 9. NO SUBSTITUTIONS SHALL BE PERMITTED WITHOUT PRIOR WRITTEN APPROVAL OF THE OWNER OR OWNER'S PROJECT
- 10. ANY PLANT WHICH DIES, TURNS BROWN, OR DEFOLIATES (PRIOR TO TOTAL ACCEPTANCE OF THE WORK) SHALL BE PROMPTLY REMOVED FROM THE SITE AND REPLACED WITH MATERIAL OF THE SAME SPECIES, QUANTITY, AND SIZE
- MEETING ALL PLANT LIST SPECIFICATIONS. 11. THE CONTRACTOR IS RESPONSIBLE FOR FULLY MAINTAINING ALL PLANT MATERIALS (INCLUDING, BUT NOT LIMITED TO

WATERING, SPRAYING, MULCHING, FERTILIZING, AND REMOVAL OF STAKES AND GUYS) AND NEWLY ESTABLISHED LAWN


- 12. ALL AREAS DISTURBED BY UTILITY INSTALLATION AND SITE GRADING ACTIVITY SHALL RECEIVE 6" APPROVED TOPSOIL (TO A COMPACTED DEPTH OF 6", UNLESS OTHERWISE SPECIFIED BY THE GOVERNING MUNICIPALITY) BE FINE GRADES,
- SEEDED, MULCHED, AND WATERED UNTIL A HEALTHY STAND OF GRASS IS OBTAINED. 13. ANY IRRIGATION COMPONENT DAMAGED DURING SITE OR LANDSCAPE RENOVATIONS MUST BE REPAIRED OR
- REPLACED TO THE SATISFACTION OF THE OWNER. 14. A ONE YEAR GUARANTEE SHALL BE PROVIDED ON ALL PLANT MATERIALS FROM THE DATE OF PROVISIONAL
- ACCEPTANCE.

15. PLANTING BACKFILL MIXTURE SHALL CONSIST OF 3 PARTS TOPSOIL AND 1 PART COMPOST THOROUGHLY MIXED.

PLANTING SOIL DEPTH SHALL BE 3' MINIMUM, AND BE FREE FROM CONSTRUCTION DEBRIS AND FOREIGN MATERIALS. 16. STAKE TREES IMMEDIATELY AFTER PLANTING.

AREAS UNTIL THE WORK IS ACCEPTED IN TOTAL BY THE OWNER.

17. LOCATIONS OF EXISTING BURIED UTILITIES SHOWN ON THE PLANS ARE BASED UPON BEST AVAILABLE INFORMATION AND ARE TO BE CONSIDERED APPROXIMATE. IT IS THE RESPONSIBILITY OF THE CONTRACTOR TO VERIFY THE LOCATIONS OF ALL UNDERGROUND UTILITIES WITHIN AND ADJACENT TO THE WORK AREA. IF ANY TREE IS LOCATED CLOSER THAN 5' TO AN UNDERGROUND UTILITY, IT SHALL BE RELOCATED TO A LOCATION THAT IS A MINIMUM OF 5'
AWAY AS MEASURED FROM THE ROOTBALL. THE CONTRACTOR SHALL BE RESPONSIBLE FOR REPAIRING ANY AND ALL DAMAGE TO UTILITIES, STRUCTURES, AND SITE APPURTENANCES, ETC., WHICH OCCURS AS A RESULT OF THE

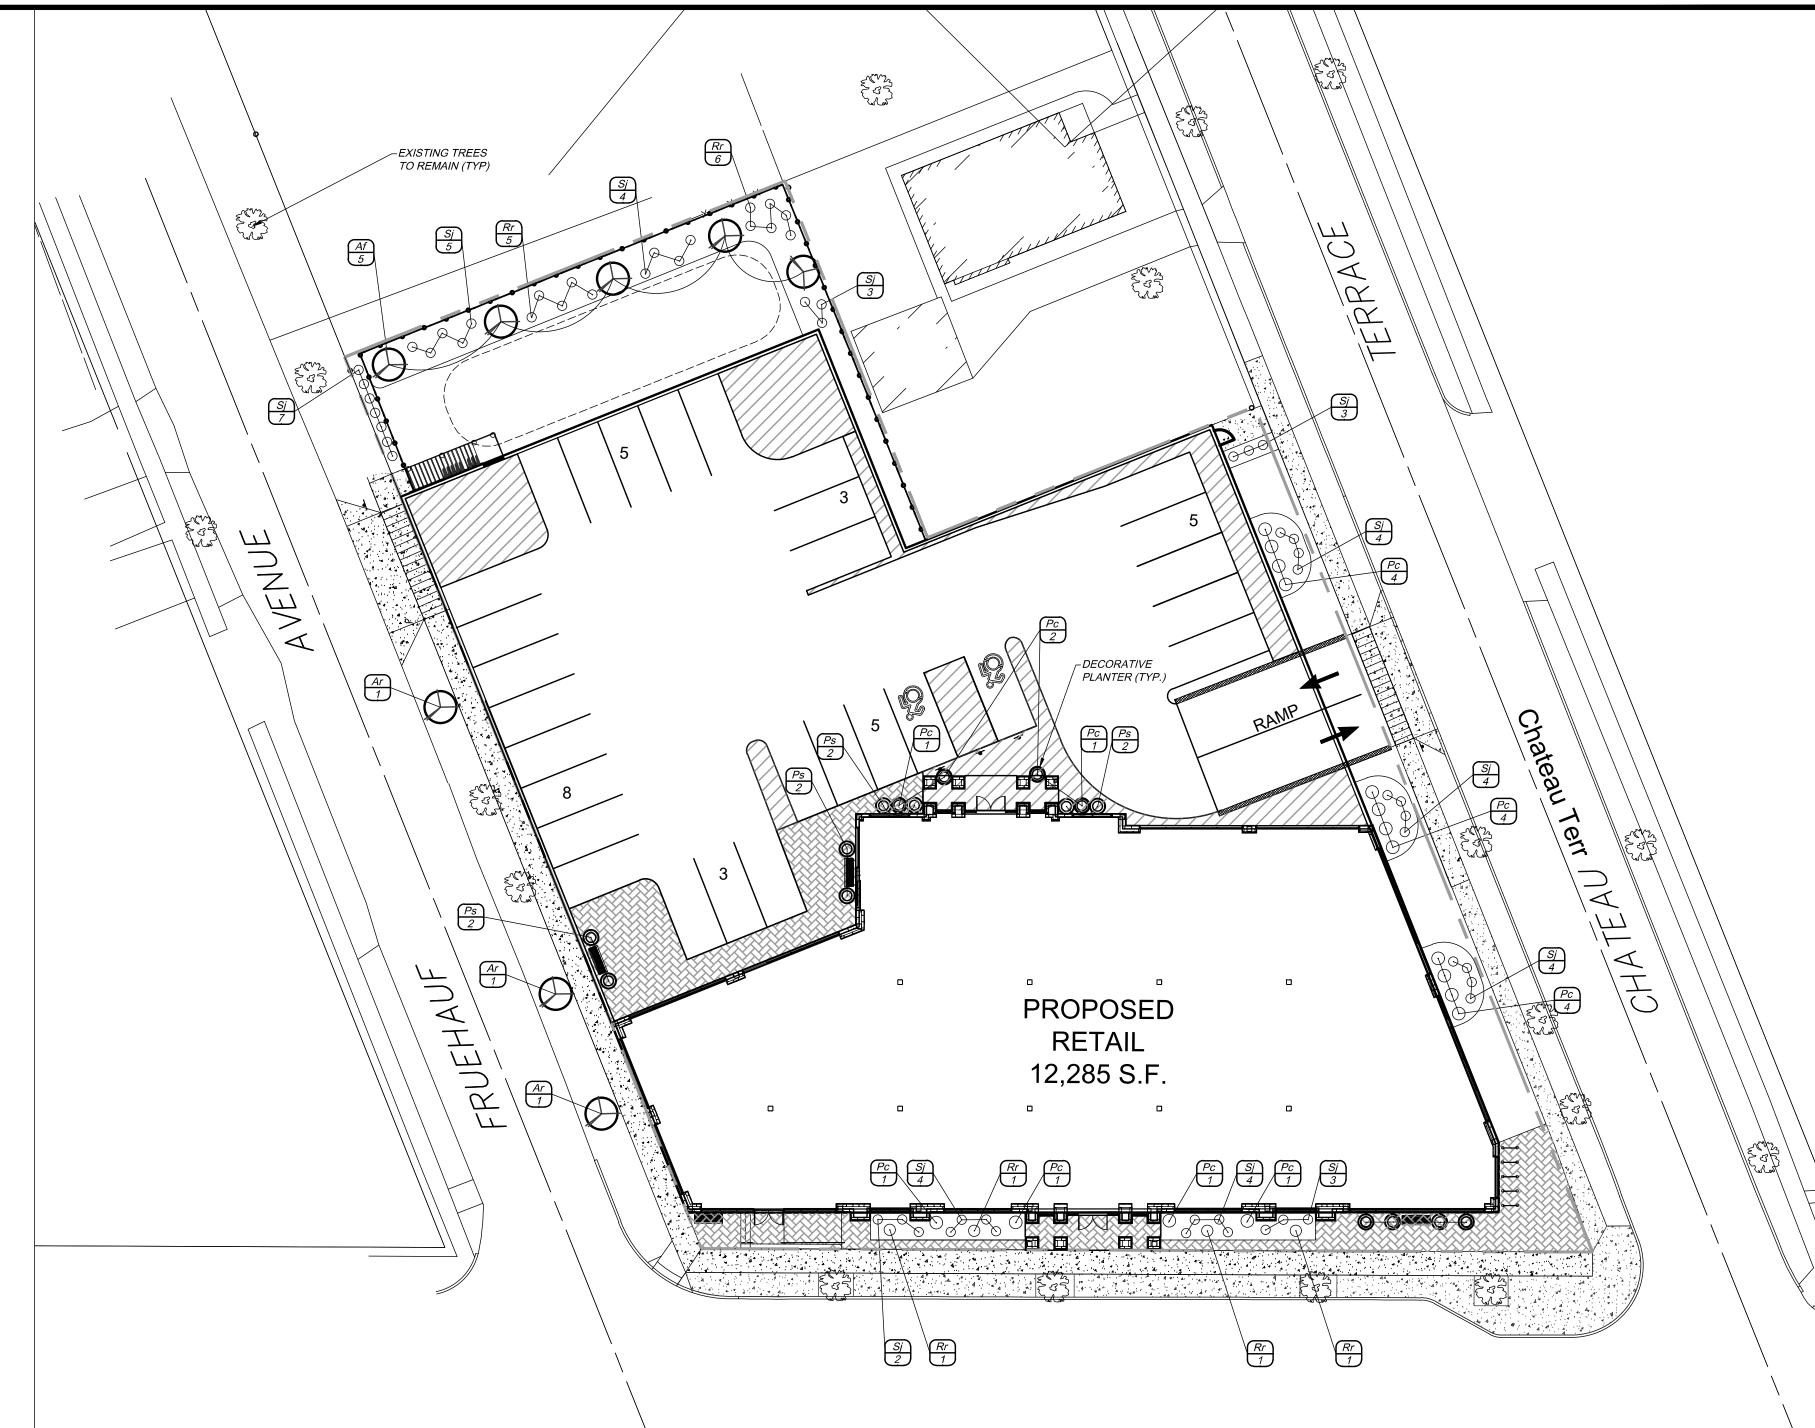

MEDIUM IMPACT LANDSCAPE SCREEN OPTION 1


PLANT TYPE	SPACING	DISTANCE	DISTANCE/SPACING	PLANT QUANTITY
LARGE DECIDUOUS TREES (Zs)	1/25 L.F.	112 Ft	112/25 = 4.48 (ROUND TO 5)	5
EVERGREEN & DECIDUOUS SHRUBS Sj	1/5 L.F.	112 Ft	112/5 = 22.4 (ROUND TO 23)	23

PLANT SCHEDULE

QTY	KEY	BOTANICAL NAME	COMMON NAME	SIZE	ROOT	MATURE SIZE
ORNAI	IENTA	L / DECIDUOUS TREES				
5	Af	ACER X FREEMANII 'JEFFERSRED'	FREEMAN MAPLE	2.5" CAL.	ВВ	HT. 40-50', SP. 30-40'
3	Ar	ACER X FREEMANII	ARMSTRONG MAPLE	2.5" Cal	ВВ	HT. 40-55', SP. 30-40"
SHRUB	s				•	
67	Sj	SPIREA JAPONICA 'GOLD MOUND'	GOLD MOUND SPIREA	3 GAL. (24" MIN.)	CONT.	HT. 2-3', SP. 4'
11	Рс	PRUNUS X CISTENA	PURPLELEAF SAND CHERRY	3 GAL. (24" MIN.)	CONT.	HT. 3-4', SP. 4'
8	Rr	ROSA 'RADRAZZ'	KNOCK OUT ROSES	3 GAL. (24 MIN")	CONT.	HT. 3-4', SP. 3-4'
PEREN	NIALS	& GRASSES				
8	PS	PENNISETUM SETACEUM	FOUNTAIN GRASS	3 GAL. (24" MIN)	CONT.	HT. 3-5', SP. 2-4



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CONSTRUCTION SET

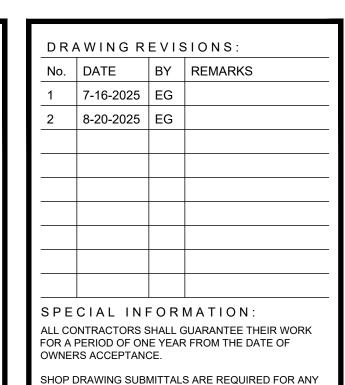

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AREA:

NORTH

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CONSULTANT



• LANDSCAPE COSTICH
217 LAKE AVENUE
ROCHESTER, NY 14608
(585) 458-3020


SURVEYING





Overall Landscaping Plan

DRAWING NO. DRAWN BY:

CHECKED BY: ERG DATE: 5/29/2025

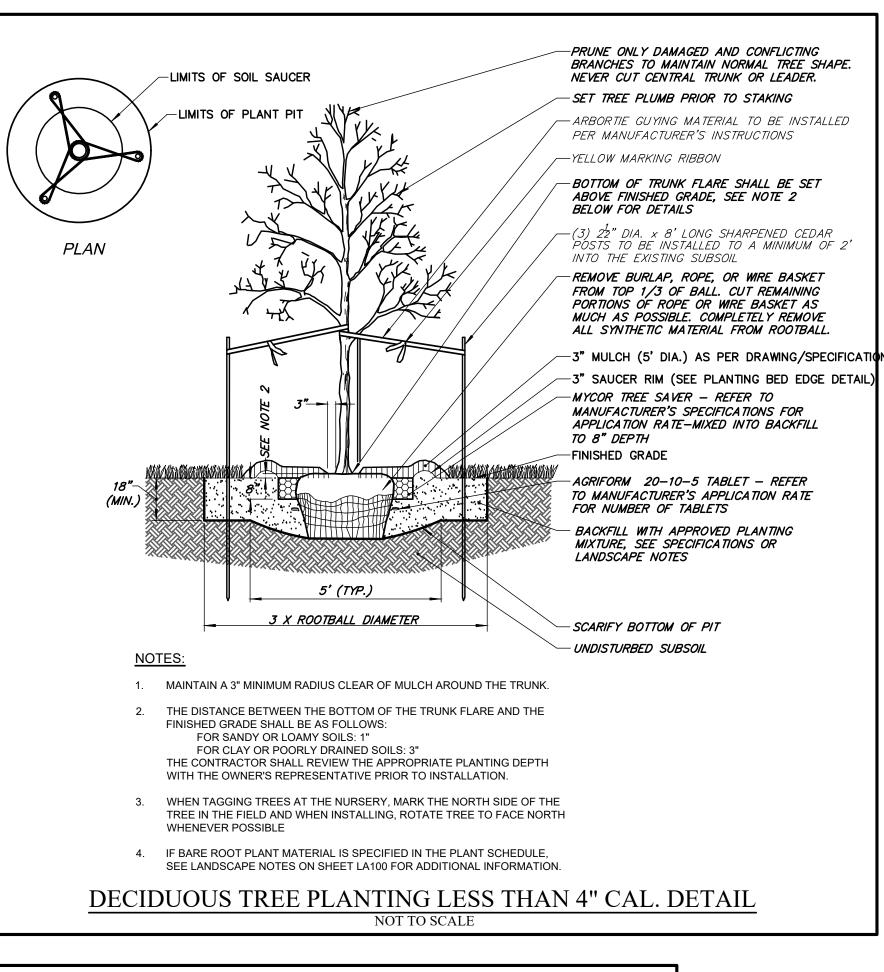

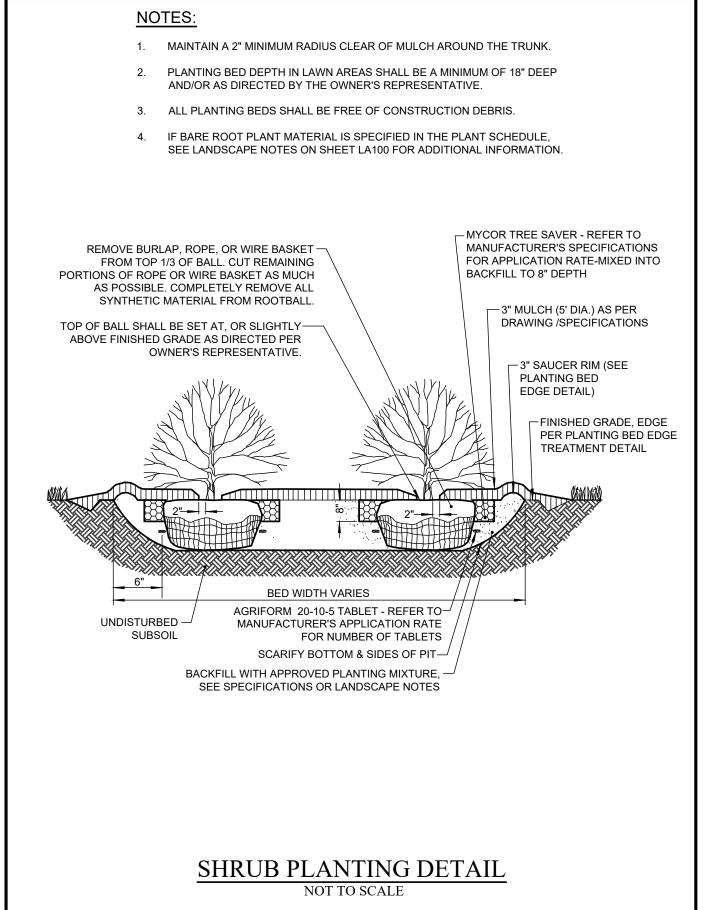

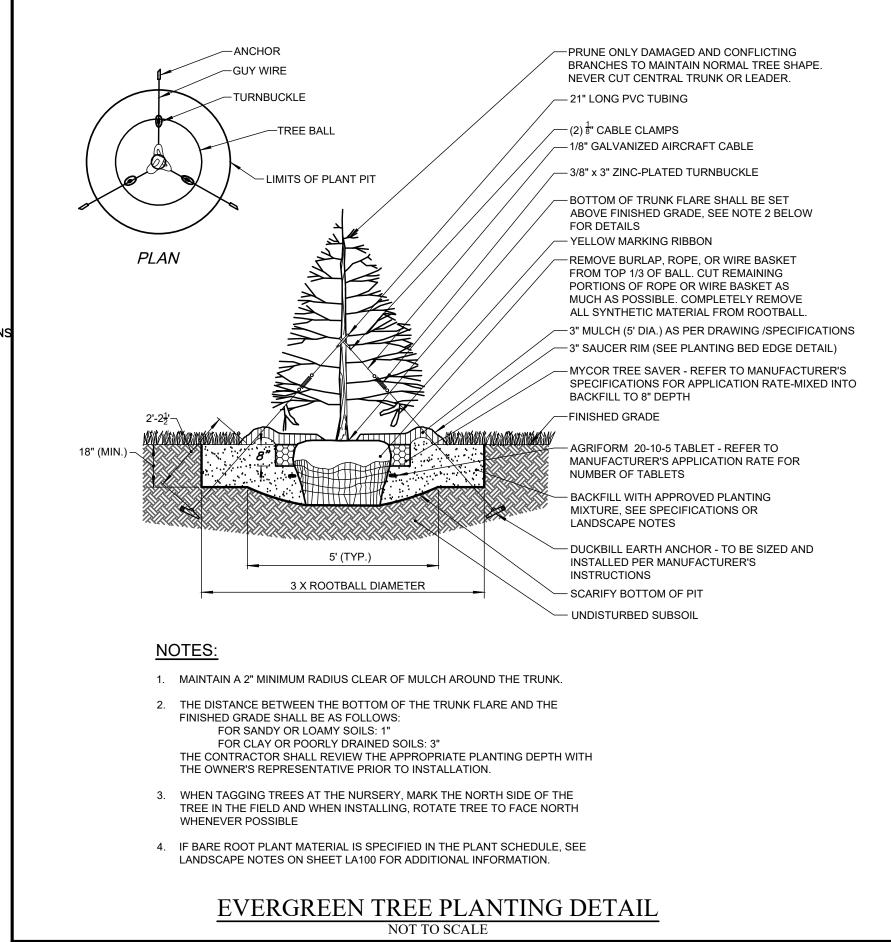

DRAWING REVISIONS:

No. DATE BY REMARKS

1 04.25.2025 DZ Arch Updates

2 05.27.2025 DZ Coordination Notes
and Town Comments

SPECIAL INFORMATION:
ALL CONTRACTORS SHALL GUARANTEE THEIR WORK FOR A PERIOD OF ONE YEAR FROM THE DATE OF

OWNERS ACCEPTANCE.

SHOP DRAWING SUBMITTALS ARE REQUIRED FOR ANY AND ALL STRUCTURES.

NOTICE

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CONSTRUCTION SET



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PROPERTY NUMBER: #5202

AREA:

| | AIL

PROPOSED RETA

CONSULTANT



S

• LANDSCAPE ARCHITECTURE

217 Lake Avenue

Engineering

SURVEYING

LAND

ENGINEERING ROCHESTER, NY 14608 (585) 458-3020

JAMES ALLEN RUMSEY

BENDERSON DEVELOPMENT 570 DELAWARE AVE., BUFFALO, NY 14202

(716) 886-0211

SEAL



Landscaping Details


SCALE: NTS

DATE: 05/29/2025

DRAWN BY: DRAWING NO.
TDM
CHECKED BY:
ERG

C7.1

OFFICIAL TOWN USE ONLY

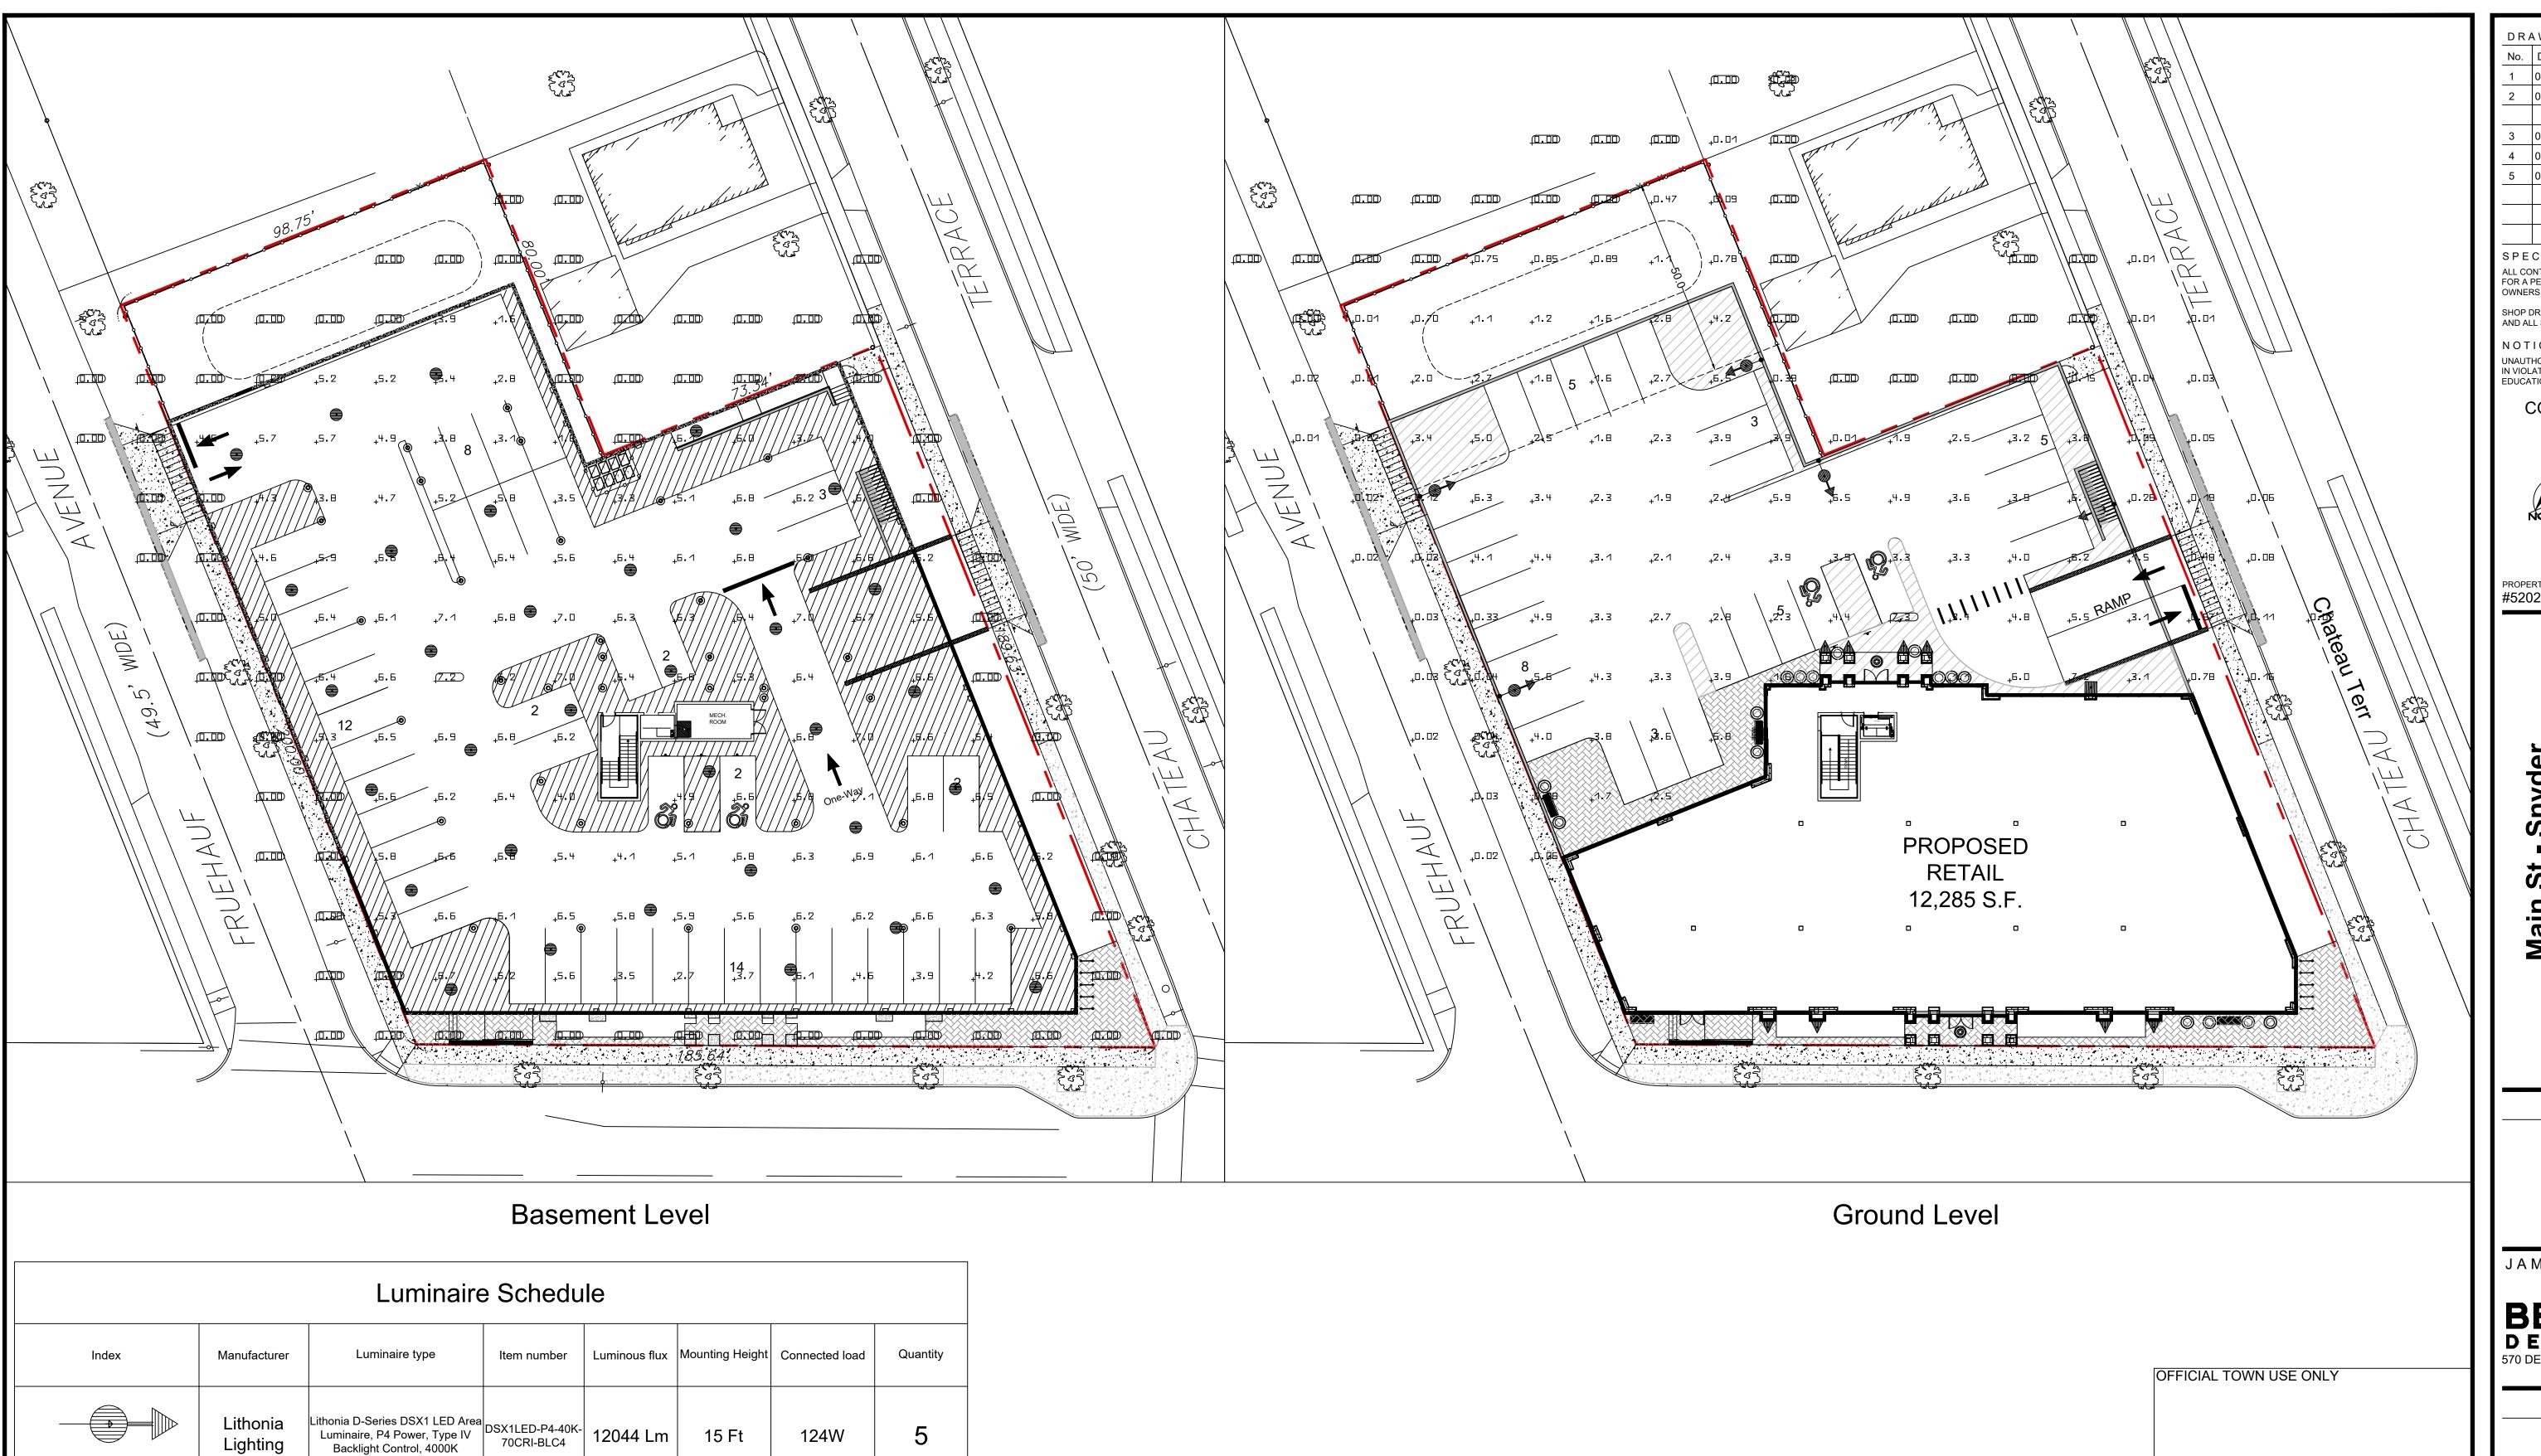

		FOOTCAND	DLE LEVELS AT GRAI	DE	
#	Name	Parameter	Min	Max	Average
1	Non-Residential Parking Area	Ground Level Parking and Site	0.44 fc Code: 0.2 fc	7.26 fc Code: 10.0 fc	1.45 fc Code: 1.5 fc
2	Canopy Area	Basement Parking Area	2.10 fc Code: 2.0 fc	7.26 fc Code: 15.0 fc	4.75 fc Code: 10.0 fc

DRAWING REVISIONS: No. DATE BY REMARKS 04.25.2025 DZ Arch Updates 05.27.2025 DZ Coordination Notes and Town Comments 06.04.2025 DZ Town Meeting Update 07.14.2025 DZ Site Updates 08.20.2025 DZ Site Updates

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CONSTRUCTION SET



PRO

CONSULTANT

JAMES ALLEN RUMSEY

570 DELAWARE AVE., BUFFALO, NY 14202

(716) 886-0211



Lighting Plan

1" = 20' DRAWN BY: DMZ

DRAWING NO. MAO
DATE:
04.16.2025

Ð

Lithonia

Lithonia

Lithonia

Building Sconces- Refer to Architectural Plans

Lithonia VCPG Ultimate LED
Parking Garage,V8-P3 Power,
Type V Medium, 4000K

VCPGXLED-V8-P3
-40K-70CRI-T5M

6334 Lm

Lithonia WDGE3 LED Wall Sconce, P2 Power, Type4, 4000K K-70CRI-R4 8779 Lm

Lithonia RCNY LED Canopy Luminaire, ALO1, Symmetric 0K-70CRI-SYMC 8355 Lm


34

10 Ft

15 Ft

10 Ft

59W

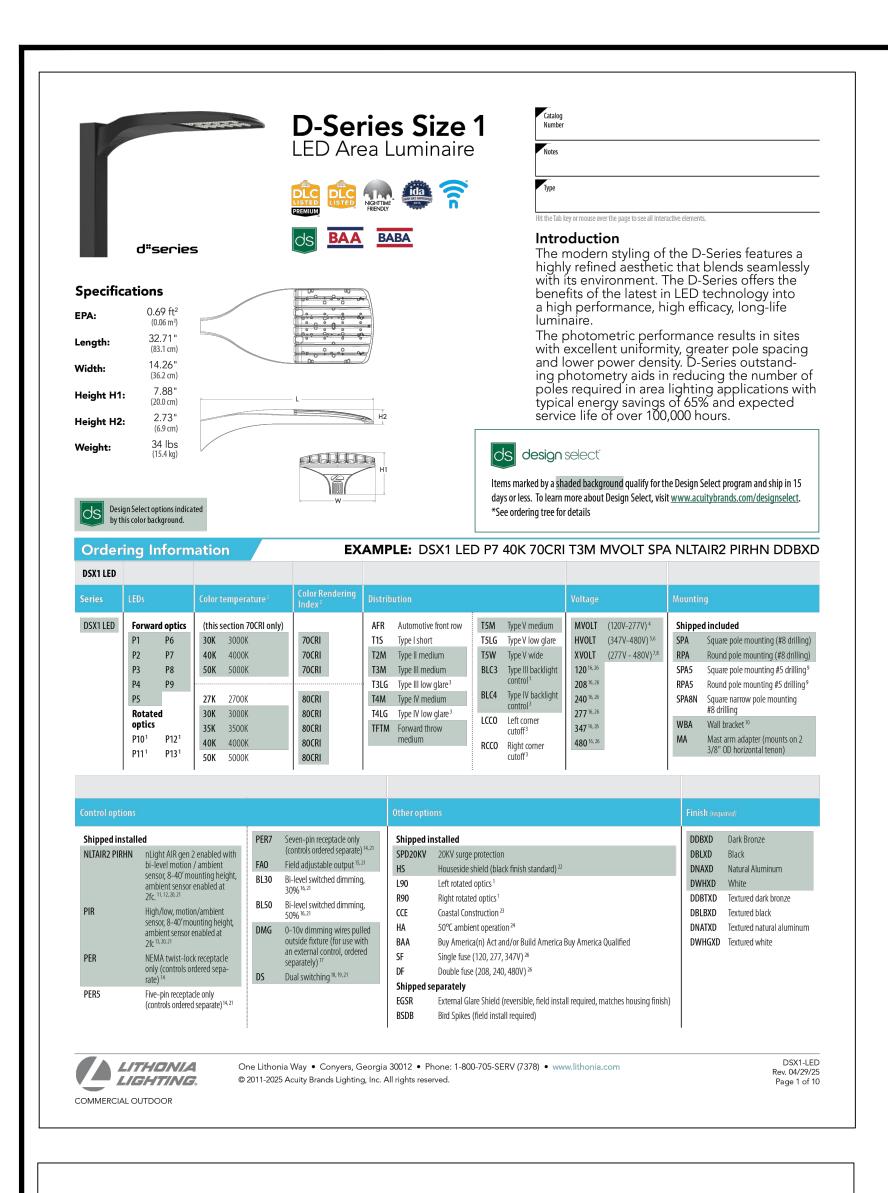

WDGE3 LED

ds BAA BABA

Specifications

WDGEAWS DDBXD WDGE 3/8inch Architectural Wall Spacer (specify finish)

WDGE3PBBW DDBXD U WDGE3 surface-mounted back box (specify finish)

LITHONIA LIGHTING.

The WDGE LED family is designed to meet specifier's every

that blends with any architecture. The clean rectilinear

design comes in four sizes with lumen packages ranging

from 1,200 to 25,000 lumens, providing a true site-wide

solution. Embedded with nLight® AIR wireless controls, the

WDGE family provides additional energy savings and code

WDGE3 has been designed to deliver up to 12,000 lumens


2 Not qualified for DLC. Not 4 PE not available in 480V and with 7 Available with MVOLT only and


WDGE3 LED


Rev. 02/24/25

y sensors/controls.
5 DMG option not available with

Architectural Wall Sconce

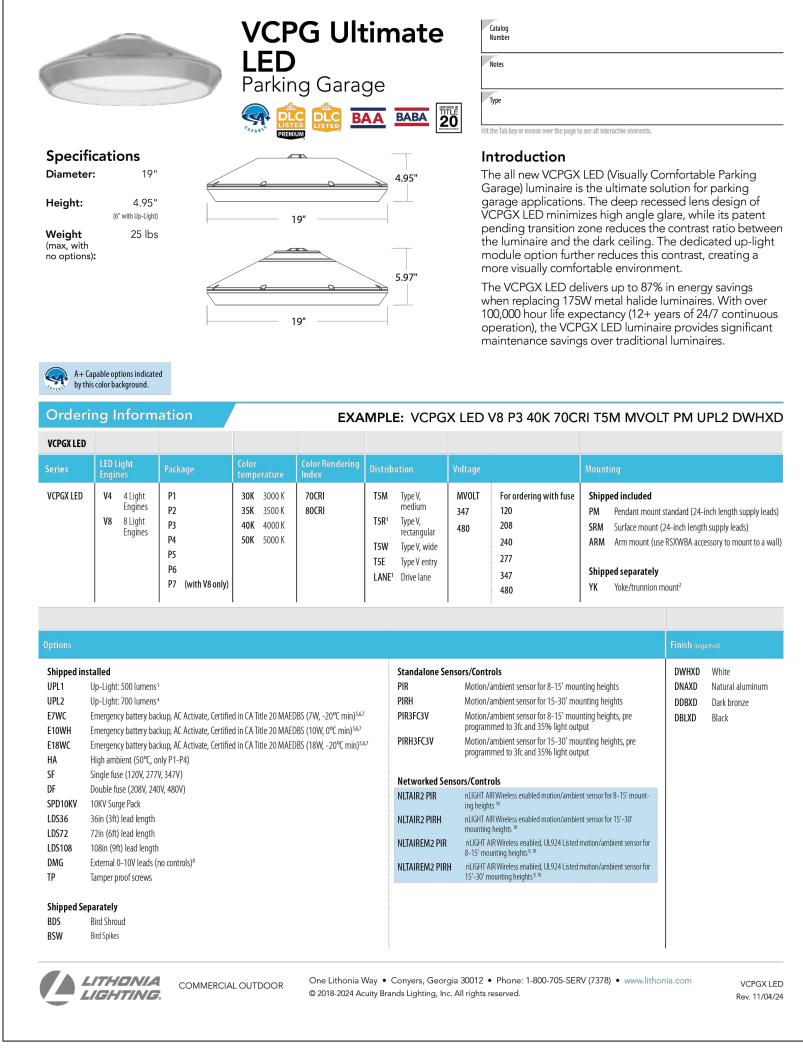

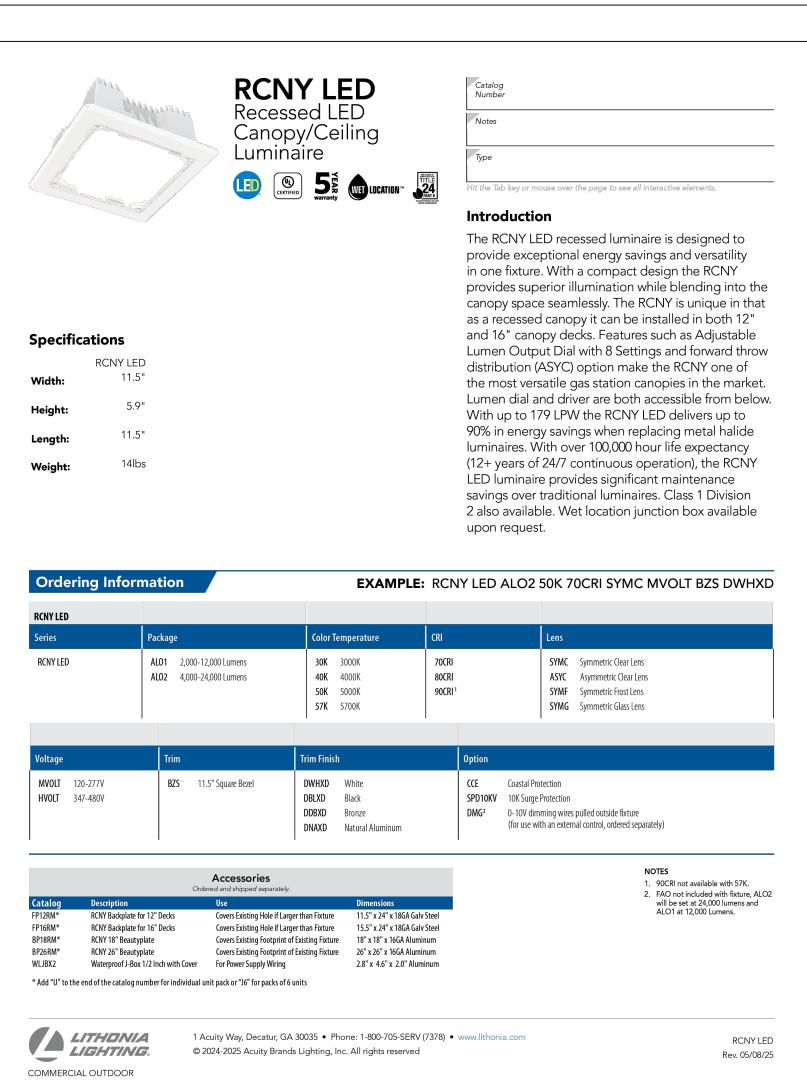

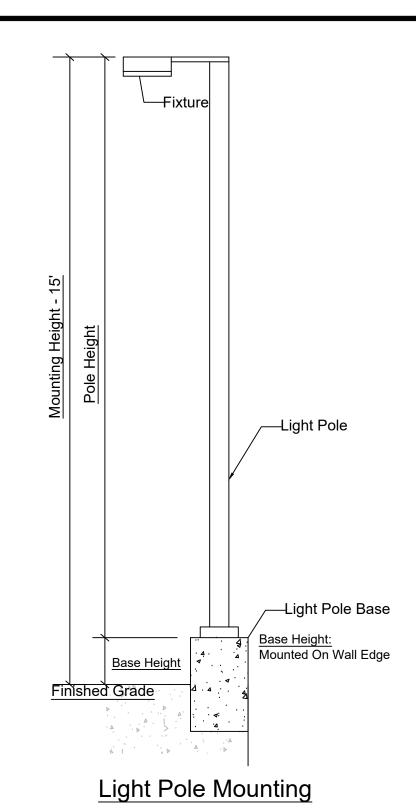

Prin Outdoor Wall Light 1-Light | Glass Rectangle Shade 59158BKDS © 2025 Kichler Lighting LLC All Rights Reserved SPECIFICATIONS - 8.25in Certifications/Qualifications ADA Compliant Dark Sky Compliant kichler.com/warranty Height From Center Of Wall Opening (Spec Sheet) 16.75in 4.6 LBS Weight Canopy Height Canopy Width Canopy Depth Electrical Input Voltage 120 V Light Source Light Source Lamp Included # Of Bulbs/LED Modules Max Or Nominal Watt GU10 (10mm Twist And Lock) ALSO IN THIS FAMILY Socket Type Dimmable Mounting/Installation Interior/Exterior Exterior Product Mounting Weight 4.6 LBS Lead Wire Length Wire Connectors Wire Nuts FIXTURE ATTRIBUTES Housing/Glass 59157OZ 59157BKDS Primary Material Aluminum Shade Included Glass Rectangle Shade Shade Description 5.75L, 11.25H, 5.75W Shade Dimensions Product/Ordering Information 59158BKDS 783927074490 59157OZDS 59159BK 59159BKDS Olde Bronze Olde Bronze KICHLER. Kichler.com

> **Building Architectural Lighting** Refer to Elevations for specifications

DRAWING REVISIONS: No. DATE BY REMARKS 06.04.2025 DZ Town Meeting Update 08.20.2025 DZ Site Updates SPECIAL INFORMATION:

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CONSTRUCTION SET



Know what's **below.**

PROPERTY NUMBER: #5202

AREA:

Snyder Main St. NY14226 S 0

0

1

CONSULTANT

JAMES ALLEN RUMSEY ARCHITECT

570 DELAWARE AVE., BUFFALO, NY 14202 (716) 886-0211

OFFICIAL TOWN USE ONLY

SEAL

Lighting

Details

DRAWN BY: DRAWING NO. DMZ CHECKED BY MAO

DATE: 04.16.2025

through a precision refractive lens with wide distribution, perfect for augmenting the lighting from pole mounted (without options) Items marked by a shaded background qualify for the Design Select program and ship in 15 days or less. To learn more about Design Select, visit www.acuitybrands.com/designselect. WDGE LED Family Overview WDGE1 LED 750 1,200 2,000 -- --Visual Comfort WDGE2 LED Visual Comfort 1,200 | 2,000 | 3,000 | 4,500 | 6,000 WDGE2 LED Precision Refractive
 Standalone / nLight
 700
 1,200
 2,000
 3,200
 4,200
 WDGE3 LED Precision Refractive
 Standalone / nLight
 6,000
 7,500
 8,500
 10,000
 12,000
 WDGE4 LED Precision Refractive Ordering Information **EXAMPLE:** WDGE3 LED P3 40K 70CRI R3 MVOLT SRM DDBXD MVOLT **30K** 3000K Shipped included Shipped separately **40K** 4000K **SRM** Surface mounting bracket AWS 3/8 inch Architectural wall spacer³ R3 Type 3 480¹ PBBW Surface-mounted back box (top, left, **50K** 5000K R4 Type 4 ICW Indirect Canopy/Ceiling Washer bracket (dry/ right conduit entry). Use when there RFT Forward Throw is no junction box available.3 E15WH Emergency battery backup, Certified in Standalone Sensors/Controls CA Title 20 MAFDBS (15W, 5°C min) Bi-level (100/35%) motion sensor for 8-15' mounting heights. Intended for use on switched circuits with external dusk to dawn switching. DBLXD Black Bi-level (100/35%) motion sensor for 15-30' mounting heights. Intended for use on switched circuits with external dusk to dawn switching DNAXD Natural aluminum in CA Title 20 MAEDBS (18W, -20°C PIR1FC3V Bi-level (100/35%) motion sensor for 8-15'mounting heights with photocell pre-programmed for dusk to dawn operation. DWHXD White PIRH1FC3V Bi-level (100/35%) motion sensor for 15-30 mounting heights with photocell pre-programmed for dusk to dawn operation. **DSSXD** Sandstone Photocell, Button Type 4 DDBTXD Textured dark 0-10V dimming wires pulled outside fixture (for use with an external DBLBXD Textured black NLTAIR2 PIRH Embedded wireless controls by nLight with Passive Infrared Occ sensor and on/off photocell for 15'-30' mounting heights. DNATXD Textured natural Bottom conduit entry for back box NLTAIREM2 PIR Embedded wireless controls by nLight with UL924 listed emegency operation, Passive Infrared Occ sensor and on/off photocell for 8-15' (PBBW). Total of 4 entry points. **DWHGXD** Textured white NLTAIREM2 PIRH Embedded wireless controls by nLight with UL924 listed emegency operation, Passive Infrared Occ sensor and on/off photocell for SPD10KV 10kV Surge pack⁶ 15'-30' mounting heights **DSSTXD** Textured sandstone CCE Coastal Construction ³ See page 4 for out of box functionality Accessories 1 347V and 480V not available with 3 For PBBW and AWS with CCE 6 Not available with E20WC

COMMERCIAL OUTDOOR One Lithonia Way • Conyers, Georgia 30012 • Phone: 1-800-705-SERV (7378) • www.lithonia.com

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